

February 18, 2020 Small Footprint DADU Submission

### **DESIGN TEAM**

#### **Neiman Taber Architects**

1435 34<sup>th</sup> Ave Seattle, WA 98122 206.760.5550 David Taber

## **Harriot Valentine Engineers**

1932 First Ave Seattle, WA 98101 206.778.2990 Jim Harriot

### **Johnson Lyric Construction**

1900 NW Dock Pl Seattle, WA 98107 206.784.2323 Eric Johnson

# **PROJECT DESCRIPTION**

Neiman Taber Architects specializes in small unit housing. We incorporated many of the lessons we have learned over the years for this DADU prototype.

### **Balance Privacy and Community:**

- Allow two families to share one small plot of land comfortably.
- Open the DADU out to the side yard. Both homes can have porous relationships to the outdoors while minimizing the sightlines from one home into another.
- Shared garden beds and storage provide a natural place for the two families to share resources.

## **Keep it Simple**

- The home itself is a simple rectilinear form with a gable roof.
- Conventional construction methods, a limited exterior material palette, and simple detailing will minimize costs.

# **Use the Volume**

- Tall ceilings let small spaces feel larger.
- Open the interior to the exterior living space.
- Separate the bed space from the living area with a lofted sleeping platform.
- A split-level loft makes for an easier climb.

## **DESIGN CRITERIA COMPLIANCE**

#### Low cost

- Foundation system to be slab on grade with turned-down edges to frost line.
- House is designed as simple rectilinear form with a gable roof.
- Primary building supplies to be specified and locally sourced at Home Depot or Lowes.
- Special design elements to be site fabricated, using dimensional framing lumber and plywood.

### **Green Building and Design**

- Enroll in Built Green certification program.
- Passive heating and cooling.
- Run conduit for PV-ready.
- Capture roof run-off for watering and rain garden.

### **Privacy**

- Is created by positioning primary views, entry and outdoor space towards side yards, while strategically locating windows towards house and adjacent rear yard.
- Square floor plan allows for rotation to adjust to specific site conditions.
- Garden trellis defines entry and outdoor space and while providing privacy.

#### Context

- The DADU is designed as a modern interpretation of a traditional, vernacular housing form. This transitional style blends naturally with both new and older housing styles.
- Use of vernacular exterior materials and re-interpreted design elements.

## **Culturally Responsive Design**

- Strong indoor/outdoor relationship.
- Incorporates natural materials.
- Garden trellis and planting space.
- Open plan allows for small gatherings.

# Constructability

- Slab on grade foundation system.
- Tilt-up wall construction with gable roof.
- One siding material, minimal exterior trim.

# **Architectural Variety**

 As noted, the DADU is designed as a modern interpretation of a traditional, vernacular housing form. By offering different siding material and roofing options, the design can subtly transform to fit various settings.

## **Broad Applicability**

- The square floor plan allows for rotation to adjust to specific site conditions.

# **CONSTRUCTION ESTIMATE**

See attached spreadsheet

### **MAJOR MATERIAL LIST**

- Metal roofing panels
- Stained vertical cedar plank siding
- Anderson windows and doors
- Polished slab on grade concrete floors
- Clear coated dimensional lumber and maple plywood for shelving system, guardrail wall, pullout clothes storage bins, steps and ladder
- Clear coated T&G wood flooring at lofts
- Sheetrock walls and ceiling, painted white
- Painted wood window sills and wall base

## **LIST OF MECHANICAL SYSTEMS**

- King Electric fan-driven wall heaters
- Rheem Electric tankless water heater

## **COST FOR DADU PLAN SET AND HOURLY RATE**

- \$500 per plan set (architectural + structural)
- \$100 per hour for permitting work and design changes

# **DESIGN OPTIONS**

- Siding: #1) Painted cement board shakes, #2) ainted cement board lap
- Roof: #1) Asphalt shingles, #2) Cedar shakes



# February 18, 2020 Small Footprint DADU Plan Submission Project Cost Estimate


Hard Costs based on space type and scope	Cost/SF	Sq. Ft.	Cost
General Conditions			\$8,000
Excavation and backfill			\$2,800
Sitework and landscaping			\$15,000
Slab on grade foundation, polishing	\$22.00	265	\$5,830.00
Architectural metals			\$800.00
Framing (material and labor)	\$20.00	265	\$5,300.00
On-site millwork (site built shelving, guardrail wall, storage, misc.)			\$14,000
Cabinetry (kitchen and bath)			\$3,500
Waterproofing / WRB			\$1,700
Insulation			\$3,400
Siding and trim			\$5,200
Trells structure			\$4,500
Flashing, gutter, downspouts, storage basins			\$4,000
Interior doors			\$450
Windows and doors			\$4,750
Drywall			\$4,800
Kitchen counters	\$50.00	14	\$700
Carpentry			\$2,600
Wood flooring + install (lofts)	\$10.00	100	\$1,000.00
Painting (interior)			\$2,800
Painting (exterior)			\$5,000
Appliances			\$2,600
Plumbing / Mechanical			\$7,000
Electrical			\$8,700
Subtotal			\$114,430
GC Overhead & Profit (10%)			\$11,443
State Sales Tax on Construction at 10.1%			\$12,713
Contingency (10% +/-)			\$11,443
Construction cost - Total			\$150,029
Soft Costs			
Architect's and Structural Engineer's fee			\$500
Printing costs, misc. reimbursables			\$500
Building Permit (1.5% of Construction cost / TBD)			\$2,250
Subtotal			\$3,250
Total Project Budget			\$156,530









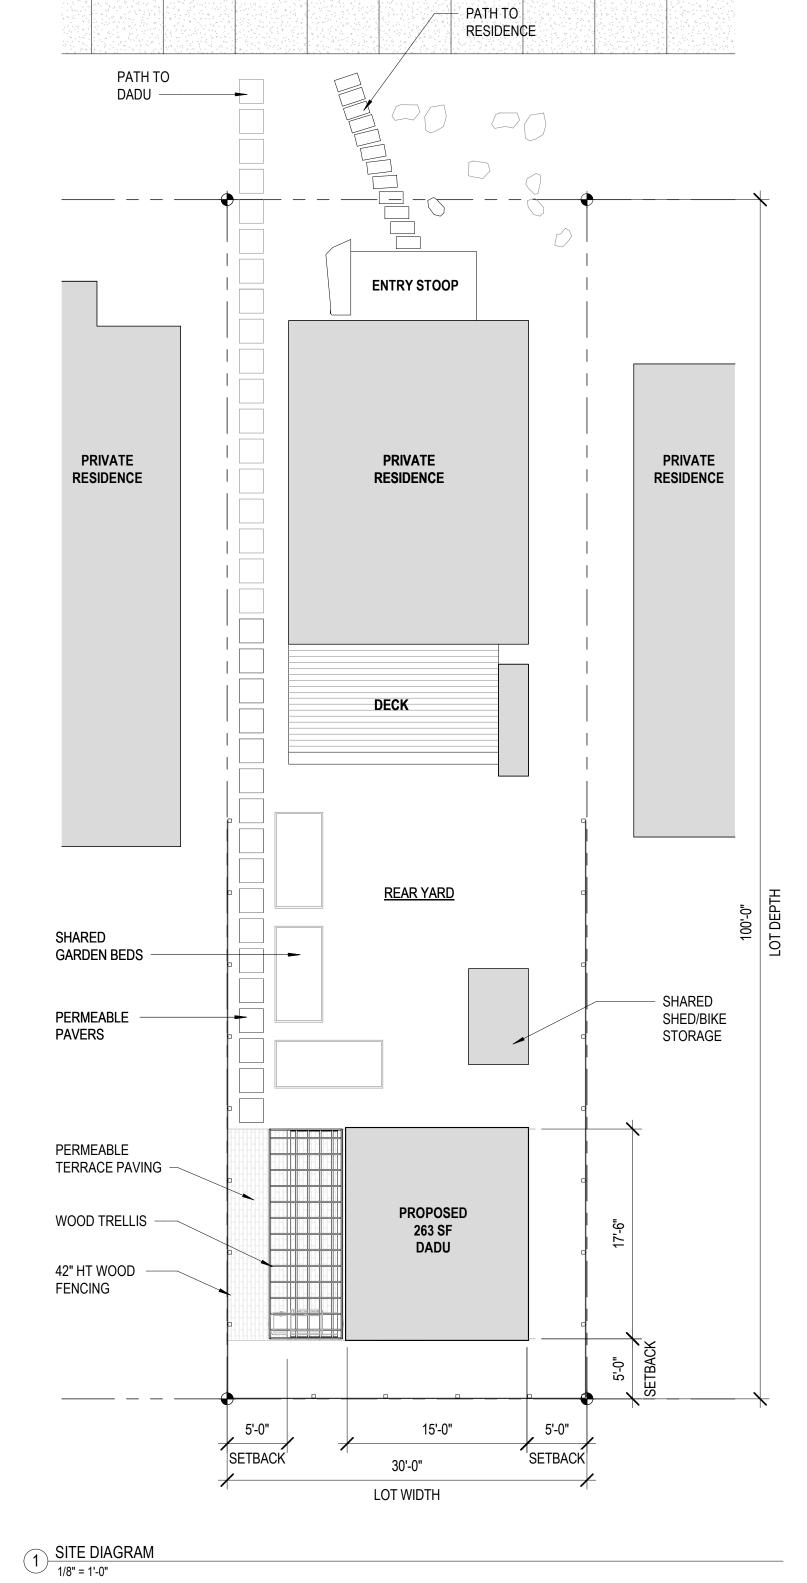

SMALL FOOTPRINT DADU SUBMISSION

Designer's Stamp

7236

REGISTERED

ARCHITECT

DAVID NEIMAN

STATE OF WASHINGTON

No.

Date

Revision

Code Official's Approval Stamp

Project Numbers: PROJECT 3XXXXXXX / 6XXXXXXX


Sheet Title

SITE PLAN

Date 02.18.2020

1.0



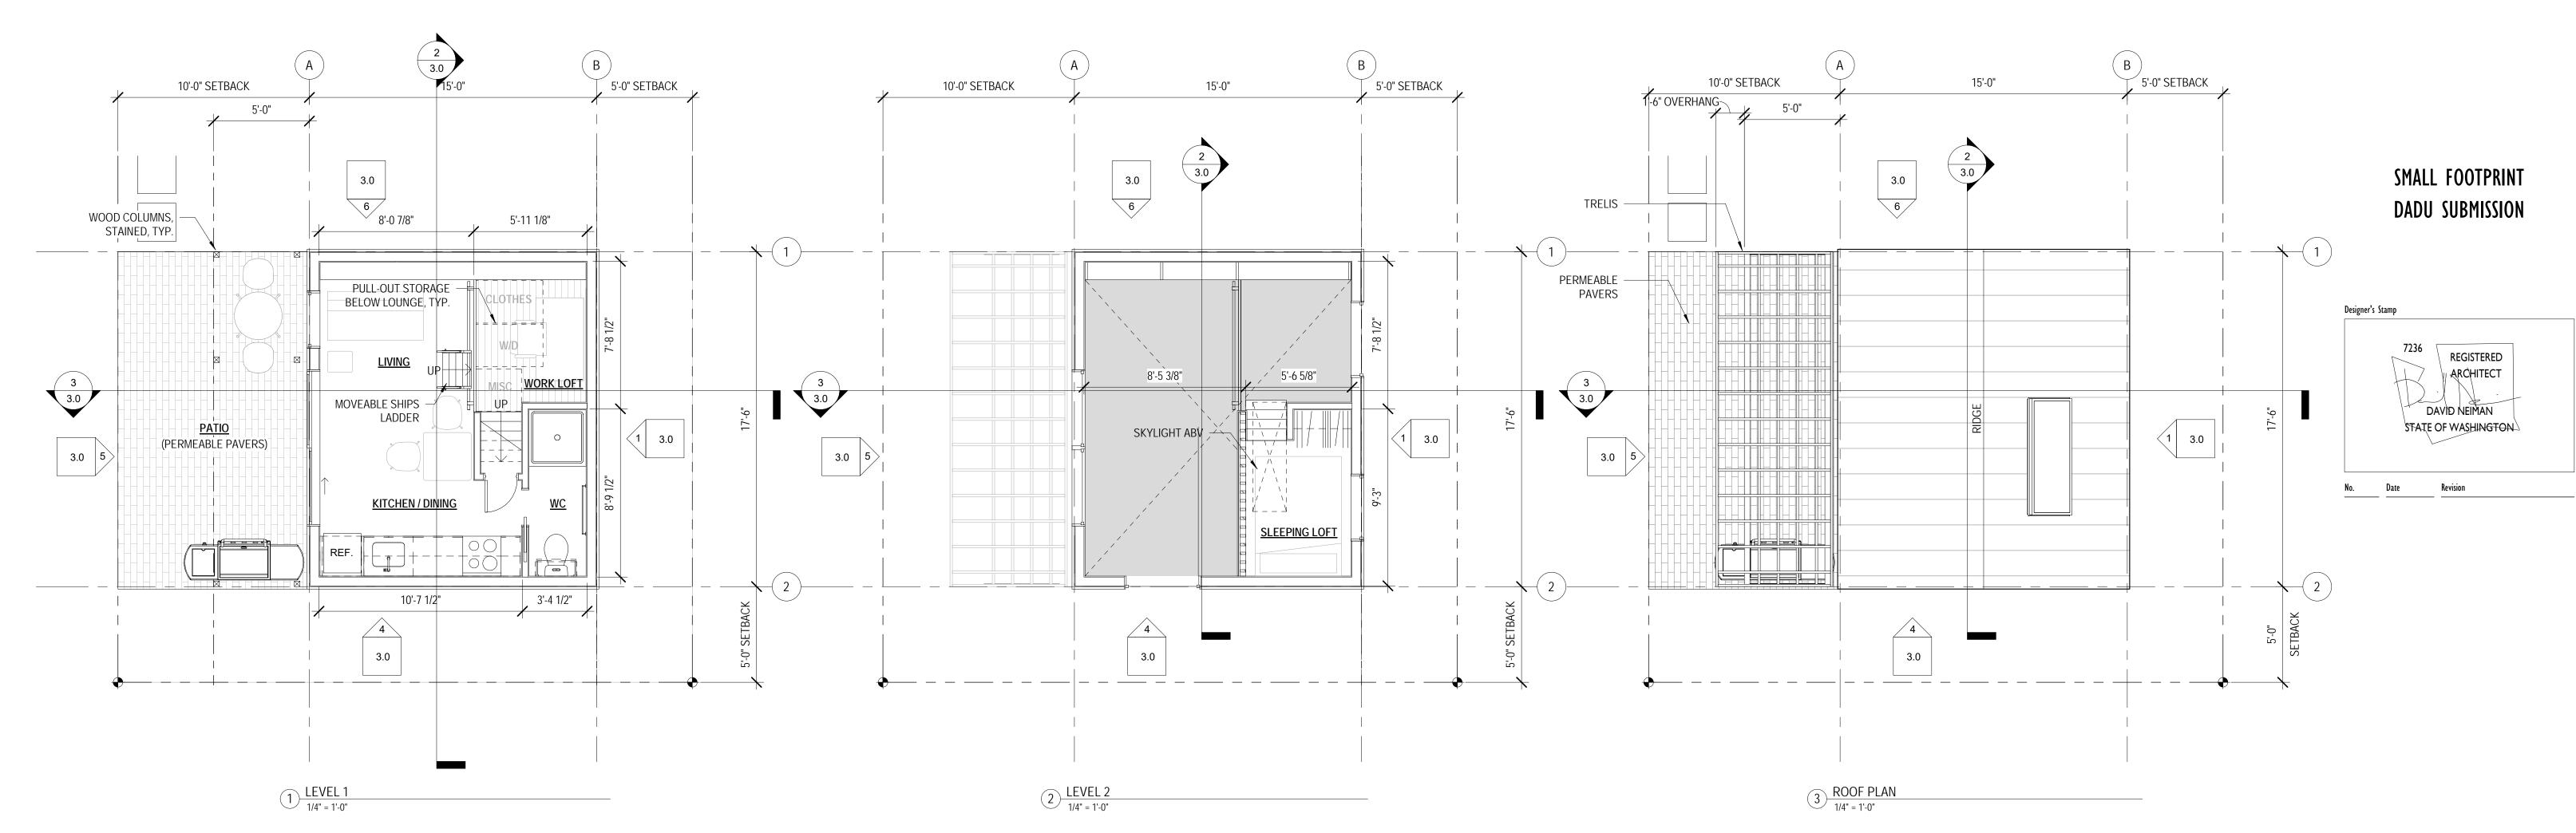


Code Official's Approval Stamp

Project Numbers: PROJECT 3XXXXXX / 6XXXXXX

Sheet Title FLOOR PLANS


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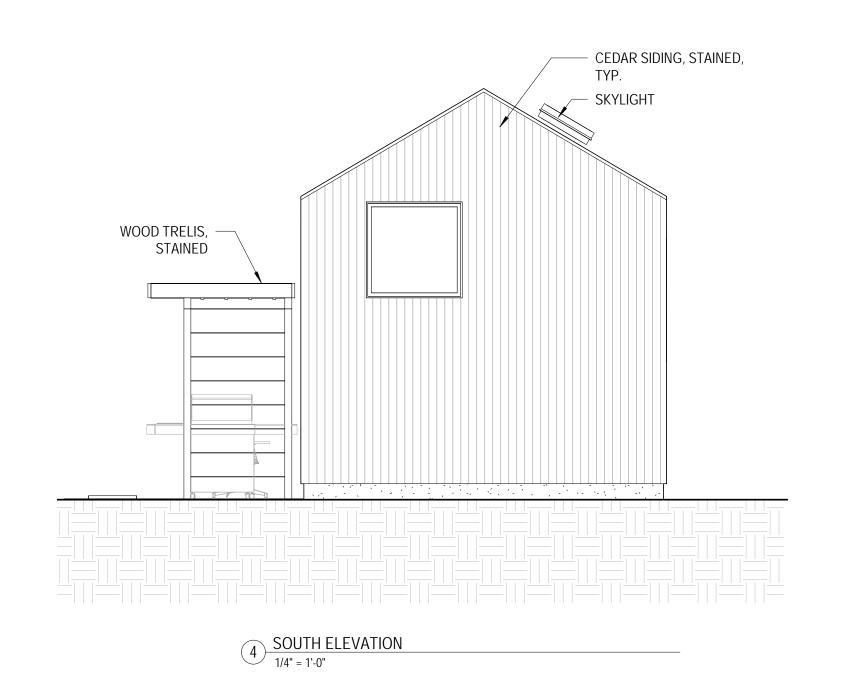


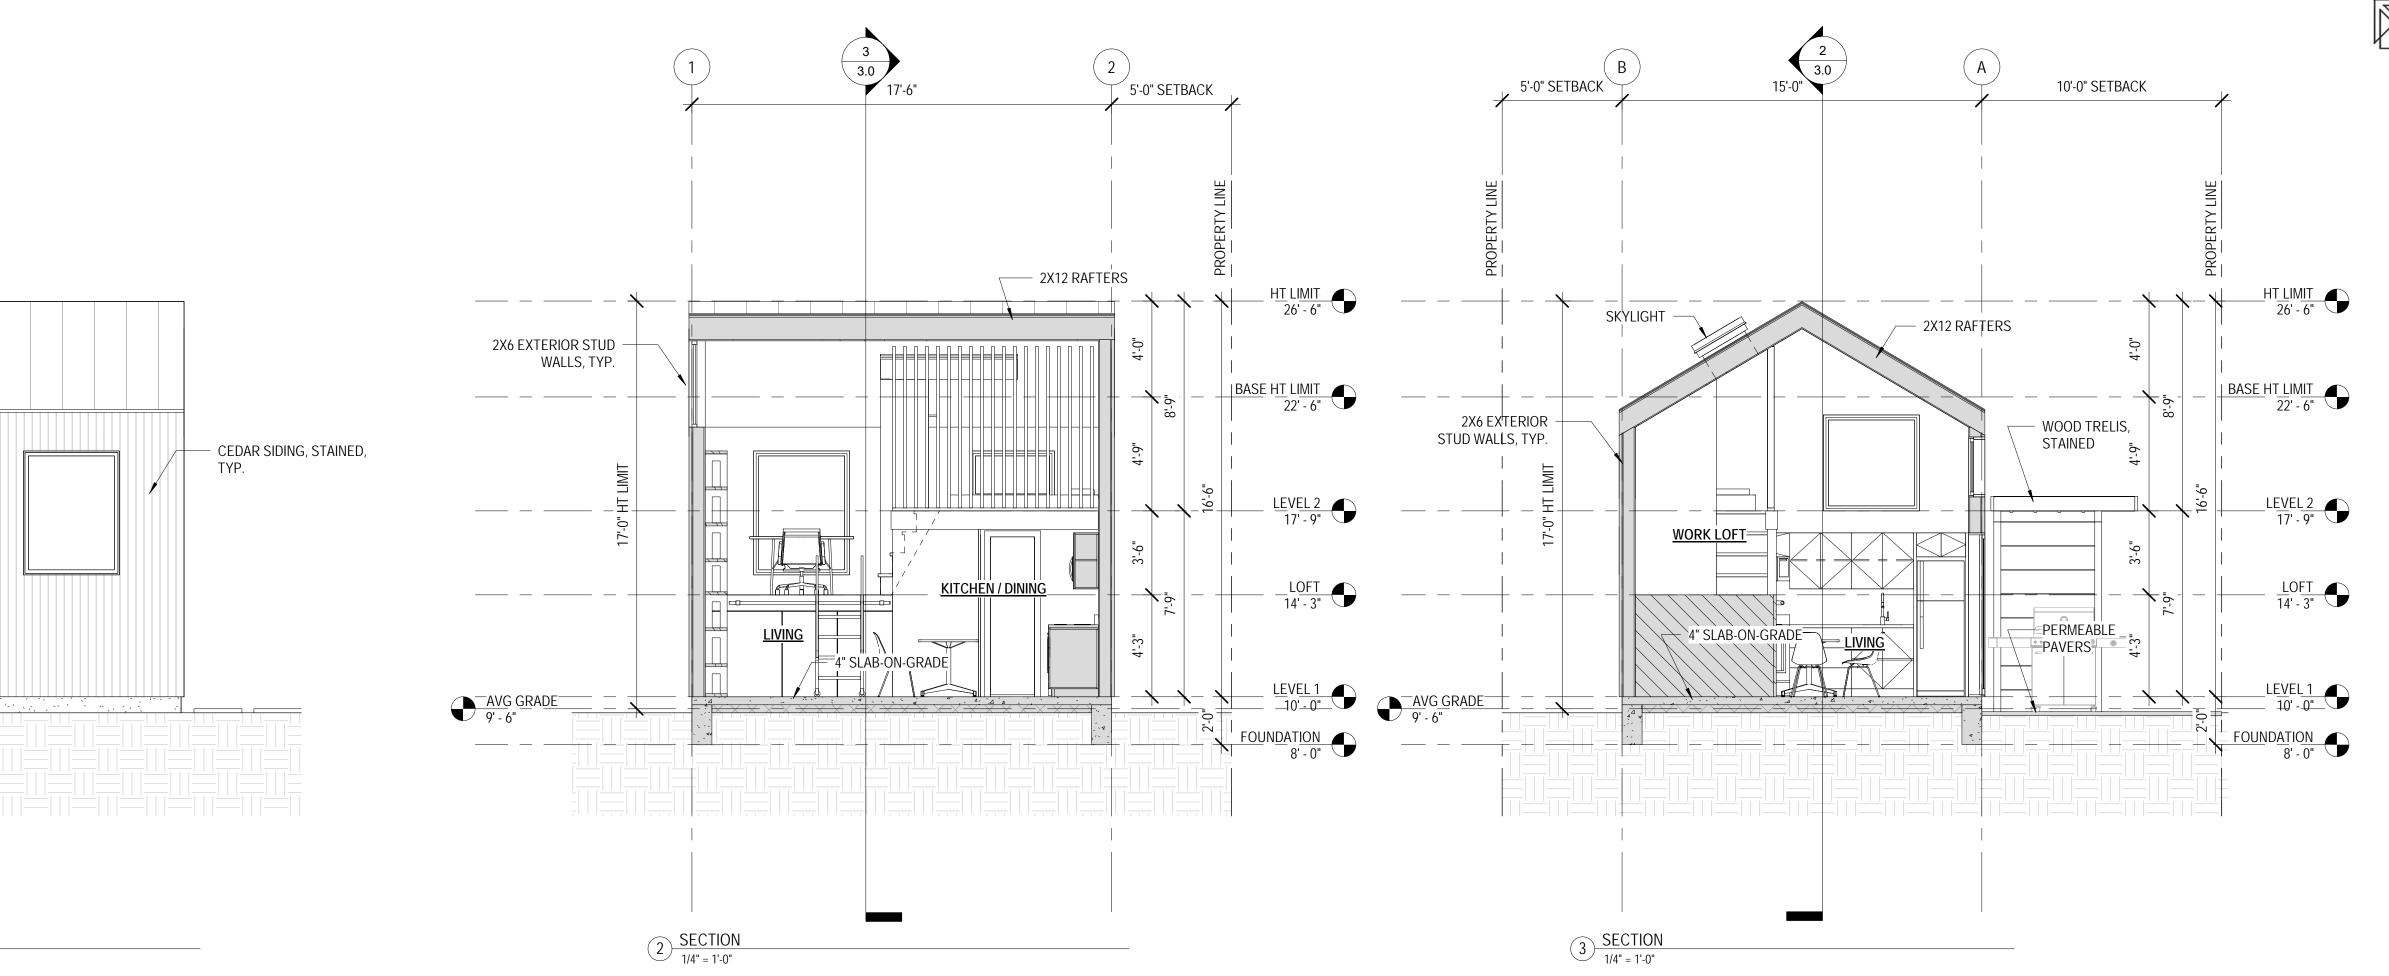

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SMALL FOOTPRINT DADU SUBMISSION



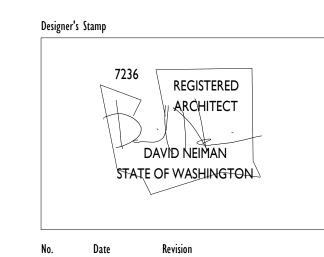


METAL ROOFING -


EAST ELEVATION

1/4" = 1'-0"

SKYLIGHT -



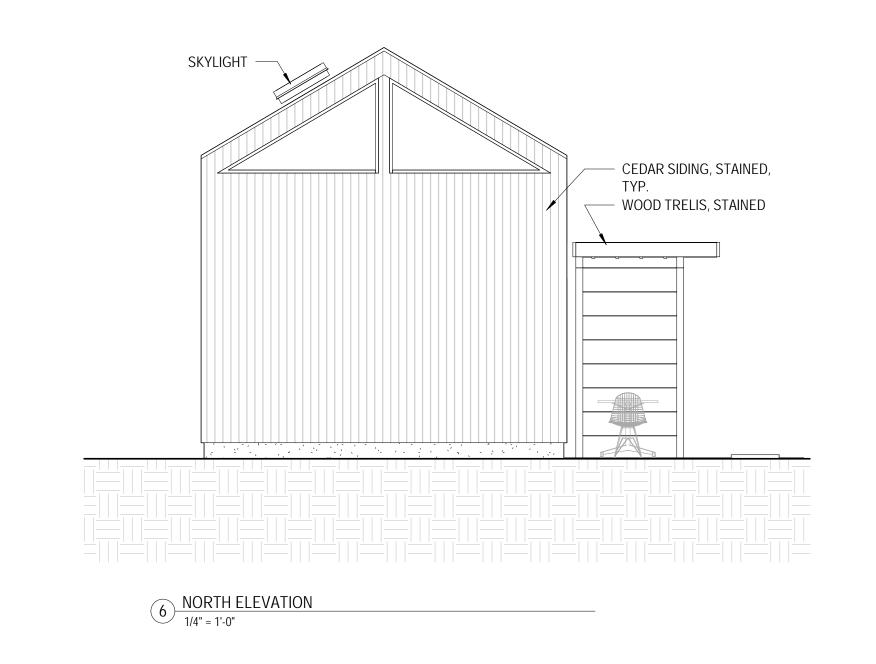

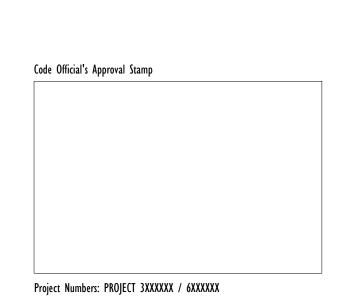

Sheet Title
SECTIONS / ELEVATIONS

02.18.2020 Number

3.0