
Narrative for Landmarks Preservation letter dated June 8th, 2022

- 1) The new blade sign was added above the ATM location, as the ATM is fully recessed, it's not visible from cars driving by along University Ave. The sign is installed using 2 bolts through the center of the shadow boxed area above the ATM. The sign is only lit up at night.
- 2) The ATM installation was easier than expected. This is due to the fact that the painted brick under the first-floor windows of the University National Bank is actually painted hollow clay blocks and foe trim. No stone was cut in the installation of this new ATM. We did have to remove the lower section of the storefront window to accommodate the machine, but we sized the machine so the upper ½ of the window (the large re-lite) would not have to be removed or disturbed. We were also able to avoid any damage to the columns which can be best seen in the attached picture labeled "cut clay brick under new ATM". The glazing we did take out during this install was not historic, it's tinted, paned and we think from the early 1980's. Should the ATM go away, a rebuild of this area should be fairly easily accomplished with concrete brick, wood trim and new tinted glass.
- 2.A) Note the evolution of the Western Façade. Originally the bank only occupied the Southern 3rd of the street level façade and the entry to the bank was located where the ATM was located when we purchased the building (the SW corner (see image "Old ATM location SW corner". The rest of the Western Façade had doors in it with additional retailers. This all changed in 1926 when the University National Bank took over the entire first floor. A new main entry was centered in the West Façade (where it sits today), a glass storefront was added to the SW corner (something we plan on adding back to the area during the interior TI work in early 2023) and a grand awning was added over the main West entrance (which is there today). Today when walk along the University Way sidewalk, you can still enter under the same canopy, same set of wooden front doors, walk into the same wooden vestibule and walk down the same marble staircase as a customer did in 1926.
- 3) SW Corner: When purchasing the University National bank, in the SW corner there was an old Wells Fargo ATM and completely rotten wood canopy (with no roof) over the ATM for customers use. There was also a MASSIVE Wells Fargo sign over the ATM area on the SE corner (see SE corner at Purchase Picture attached). Note – you can also see the terrible condition the exterior wood was in on the entire building when zooming in. This SE corner was originally used as an entry into the original bank (see MOHAI photo from 1925 with doorway show and no canopy). From the 1927 (After the big bank renovation) until the invention of the ATM, this corner was used as a display window for those walking by (see Historic Rendering photo attached). This is the history and evolution to that corner. When purchasing the building in 2018, Wells Fargo demanded that their ATM remain on the grounds for the next 20 years. A new lease was to be signed with the purchase docs. We did our research and wanted to turn that corner back into what it looked like in 1927 after the big bank renovation. Two reasons for not going to the original look – 1) DPD would not allow a door to go back into that location for clearance / ADA reasons. And 2) for nearly 100 years now, the main entry to the bank was centered in the W façade and the SW corner has been a window display. We wanted to keep that look, keep the main entry and canopy centered in the W façade. So, we agree to keep an ATM at the UNB site, but we forced Wells Fargo to remove it from the SE corner, along with their massive sign and re-locate it as far N on the Western façade as possible. This made it the lease visible to all and we think is the appropriate place. Furthermore, we are developing a plan (not designed yet) with the interior tenants to rebuild that SE corner window display and rehab the old historical light stands (one of them are ripped off).

- 4) See the attached "Western Elevation with new ATM image". The sign as indicated above is attached with two through bolts, centered in the stone shadow box above the first-floor window relite as shown in additional images attached. This sign sits approx. 5.5ft above the top of the ATM, centered. The sign is on a photocell and is illuminated at night only.
- 5) Please see the ATM Permit Set Drawings attached.
- 6) See photos attached taken from the N and S of the ATM along the sidewalk.
- 7) N/A
- 8) Value of the ATM project is approx. 28,000 dollars.

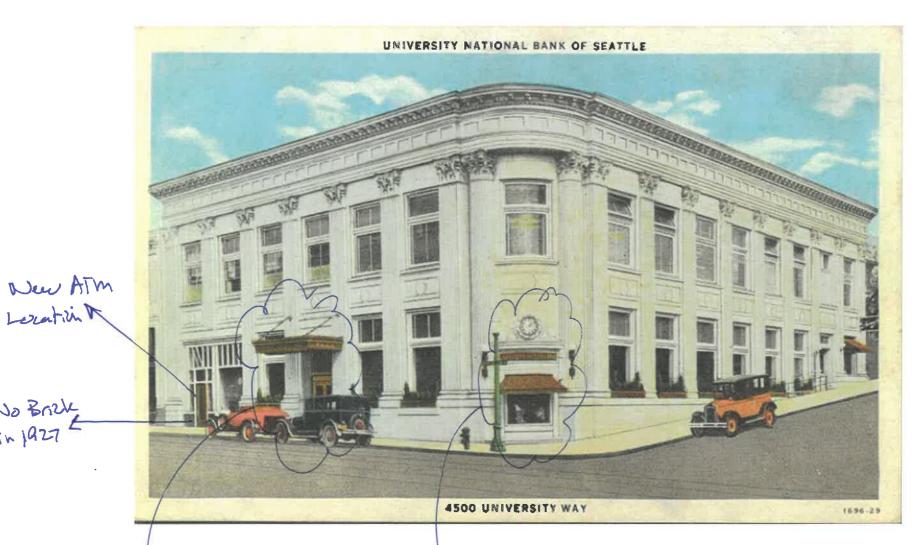

1926 Rehab Rendering (Narritie 2A) (Narritive 3)




New Central Location/Entry

Location A

Petail Store Front From 1926 - Approx 1978



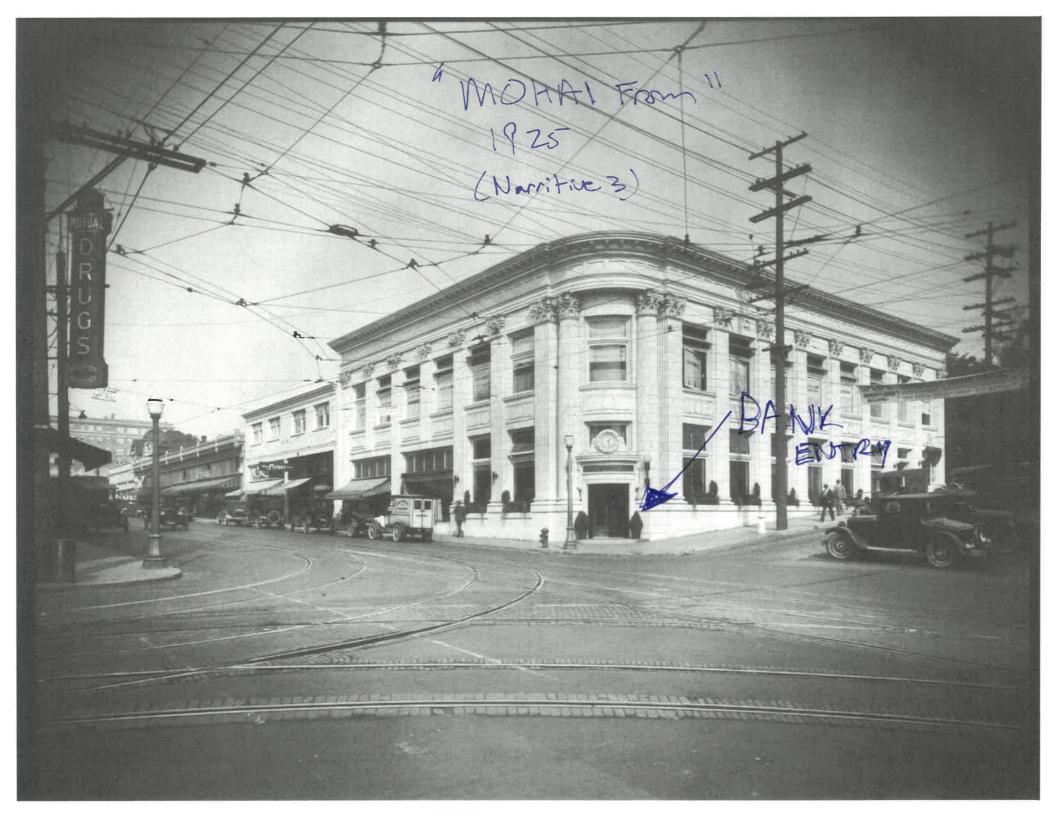

NAPLRATIVE #6

WALKING North along Sidewalk.



(NAPPLATIVE #6)
Walking South on Sidewalk



Signage Wose Up




New ATM Fit

Between Stone Columns.



"Cut any Brick under new ATM" (Norrithe #Z)

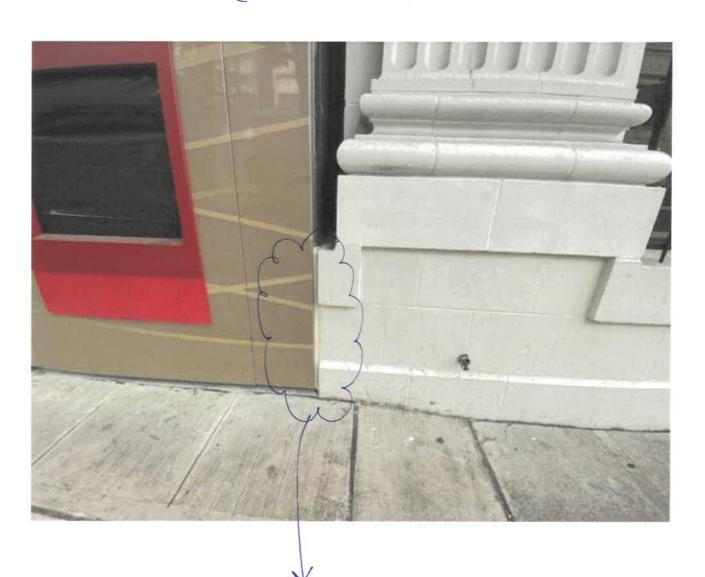

cost section on each side of ATM.

Overall ATM+ Sign on W Farada.



Extra #3 Head on SE Corner



Historical Retail Storefront Location Building prior to

Seattle Daily Times April 6, 1913

(Extra #4)


Page 28

-

◆ Page 28 of 70 ▶

Search Page

Search Issue

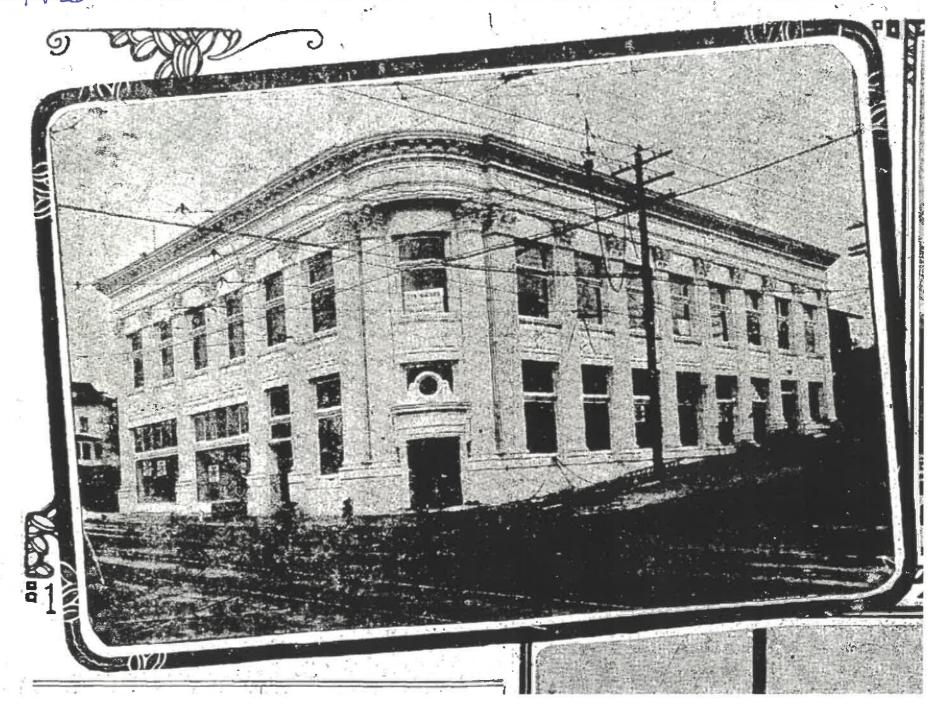

Future Corver Stocknut ALA 1926 - ATM



NARRATIVE #5

VICINITY MAP



REMOVAL AND ADDITION OF ATM 4500 UNIVERSITY WAY NE SEATTLE, WA 98105

BUILDING SECTION

DRAWING NUMBER

SHEET NUMBER

ROOM NAME

ROOM NUMBER

NORTH ARROW

DATUM POINT

WALL TYPE

DOOR NUMBER

RELITE TYPE

DETAIL

WALL MTD

SCHEDULE KEY

FIRE EXTINGUISHER

FIRE EXTINGUISHER

STRUCTURAL GRID LINE

EXTERIOR ELEVATION

WALL/DETAIL SECTION

4500	UNIVERSITY WAY	NE
Seattle, WA 98105		

EG EJ ELEC

ELEV

EMER ENCL

EQ EQP EST EXH

EXP EXT

FD FG

FE

FLSH FLX FLR FJ FTG FND FS FUR

GA GLV

GSKT GC GL GLB

GRD GF

HDW

HJ HDR

HVAC

HD HT

HEX HM HZ

HB HWT

INCL

INSI

INST

JT JST

KPL

existing grade

elevation elevator

equal

exhaust

existing

expansion joint electric, electrical

emergency enclosure, enclose

equipment estimate, estimated

expose, exposed exterior

floor drain Finished grade finish, finished fire extinguisher

fire resistant

flash, flashing

flexible

floor finish joint

footing foundation

full size

gasket

ground face

hardware hardwood

head joint header

heavy duty height

hollow metal

horizontal

hose bibb

interior

kickplate

knockout

HORIZ horizontal

fireproof, fireplace

gage, gauge galvanize, galvanized

general contractor

glass, glaze, glazing glass block grade

heating, ventilation &

hot water tank/heater

include, included

insulate, insulation

install, installed

inner diameter

air conditionina

gypsum wallboard

PROJECT SITE:

ABBREVIATIONS

above finish floo

air conditioning

adjust, adjustable

alternate, alternative

building setback line

continuous insulation

block, blocking both sides

cast in place

clear, clearance

CONTR contractor, contract

cold formed steel

cubic yards cubic feet per minute

dimension, dimensional

control joint

cubic feet

deck drain

concrete masonry units

both ways

bottom

building

cabinet

ceiling chamfer

column

CONST construction

CONT continuous

CORR corrugated

double

detail

down

diagonal

diameter

drain tile

drawer

divide, division

CONC concrete

centerline

CSMT casement

architect, architectural automated teller machine

acoustic tile

and

angle at

access

acoustic

ALLIM aluminum

ANOD anodized

BTWN between

BSMT

BS

BW BTM

CLG

CL CLR

DBL

DD DTL DIAG

APPR approximate



laminate, laminated

left hand left, long, length

lavatory

light lightweight

metal

maximum

medium

material

mirror

mount

natural

nominal

on center

opaque

opening opposite

overall

panel paralle

parking

pedestal

plate

outer diameter

overhead owner furnished

owner furnished -

contractor installed

pave, pavers, pavement

perforate, perforated

plastic laminate

poly vinyl chloride

prefabricated

property line

REINF reinforce, reinforcement

riser, risers

radius

reference

reflected

pounds per cubic foot pounds per linear foot

pounds per square foot pounds per square inch

north

minimum

miscellaneous

modify, modified

noise reduction

manufacturer

masonry opening

LH

L LT LW

MFR

MAS MO MTL MAX

MAX MECH MBR MAT MIN MIR MISC MOD MT

NAT

NI NRC

NOM

NMT N NIC NTS

OC OPQ OPG OPP OD OA

OFO

PNL PLL

PKG

PED PERF

PLAM

PL PLY PT

PVC PCF PLF PSF PSI PFB

PROP

REF RFL

DRAWING SYMBOLS

A-000

A-000

REINF reinforce, reinforcement

remove

return air

reverse right hand

right of way

square feet

setback

safety schedule

sealant

section

sheet

similar

solid core

slab on grade sound proof

south seismic joint

standard

structural

symmetric

system

telephone

thickness

tolerance

vapor barrier vertical

vertical grain

vent to outside

vinyl tile

wall to wall

water closet

washer/dryer

walk-in closel

water resistant

waterproof

wall hung

wood

window

without

unless noted otherwise

Underwriter's Laboratory

tvoical

steel

square stainless steel

store, storage

smoke detecto

rough opening

RMV

RA RVS

RH ROW RD RO RM RF

SF KY SECTOR SEC

TEL TV THK TOL T&G TYP

UNO

VJ VB VERT

VG VIN VCT VTO

WH WC W WD

W/D W

WIN WO WIC WP WR

DRAWING INDEX

GENERAL

G001

A101

A102

DPD COVER SHEET PROJECT INFORMATION SHEET

ARCHITECTURAL AS101 SITE PLAN A100

DEMO FLOOR PLANS FLOOR PLANS ASSEMBLY TYPES, DETAILS

PROJECT INFO.

PARCEL OWNER: HUNTERS CAPITAL LLC

PARCEL NO .: 881640-0105

BUILDING ADDRESS: 4500 UNIVERSITY WAY NE

ZONING NC3P-65

SITE AREA 8,116 SF

OCCUPANCY GROUP GROUP B

CONSTRUCTION TYPE

IIIB

AREA OF CONSTRUCTION 25 SF

NUMBER OF STORIES

2

SPRINKLER

APPLICABLE CODES

PARKING No Parking Required

DESCRIPTION OF WORK

REMOVAL OF ATM, NEW WALL INFILL REMOVAL OF WINDOW, NEW WALL

HUNTERS CAPITAL LLC 1620 BROADWAY, SUITE 200 SEATTLE, WA 98122 TEL: (206) 328-3333 CONTACT: MIKE OAKSMITH

ARCHITECT STUDIO MENG STRAZZARA 2001 WESTERN AVE, SUITE 200 SEATTLE, WA 98121 TEL: (206) 587-3797 (206) 587-0588 CHARLES STRAZZARA, PRINCIPAL PATRICK MAHONEY, DESIGN / MANAGER

CONTRACTOR TEL: (206) 660-6023 SIGNS:

SPRINKLER SYSTEMS

2015 SBC - WAC 50-51 2015 SMC - WAC 51-52 2017 SEC - WAC 296-46B 2015 SEC 2015 UPC -WAC 51-56, 51-5 2015 SFC - WAC 51-13 2009 IBC, 2003 ANSI A-117.1

HUNTERS CAPITAL LLC

1620 BROADWAY, SUITE 200 **SEATTLE, WA 98122**

studic_{MENG}

STRAZZARA

2001 Western Ave., Suffe 200-Seattle, WA USA 98121 206 587 3797 tel 206 587 0588 fax

TITLE

OWNER

4500 U WAY ATM

4500 UNIVERSITY WAY NE SEATTLE, WA 98105

SMS PROJECT #: 2020311

STAMP



SDCI PROJECT NUMBER

6809303-CN

ISSUED FOR: DATE: PERMIT SUBMITTAL 12/04/20

PLAN APPROVAL

DRAWN/CKD BY:

CITY STAMPS

SHEET CONTENTS

TITLE SHEET. GENERAL NOTES, SHEET INDEX

SHEET NUMBER

G001

PROJECT TEAM

JHC CONSTRUCTION CO. JOHN CALLAGHAN, PROJECT CONTACT ELECTRICAL / LIGHTING: BIDDER DESIGN

DEFERRED PERMITS

(1)

1A

(101A)

 $\langle R1 \rangle$

33 A--23

bF.E.

(A)


BIDDER DESIGN


ZONING/MUNICIPAL BUILDING AND STRUCTURAL ELECTRICAL. PLUMBING FIRE /LIFE SAFETY


SEATTLE MUNICIPAL CODE

AC197-11 (SEPA)

DIMI DIV DN DR DT DW DWR DWG

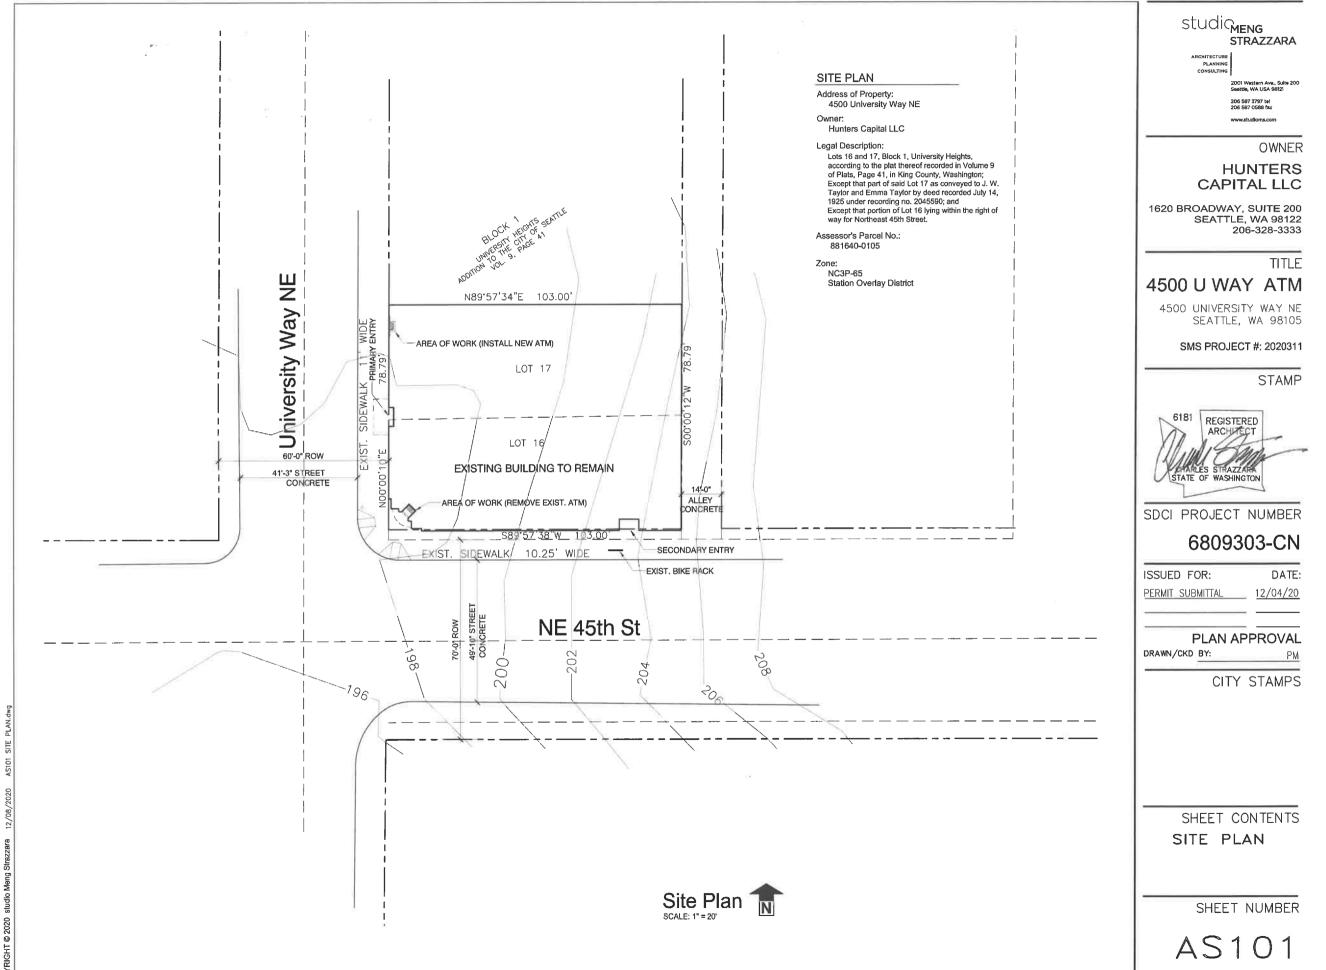

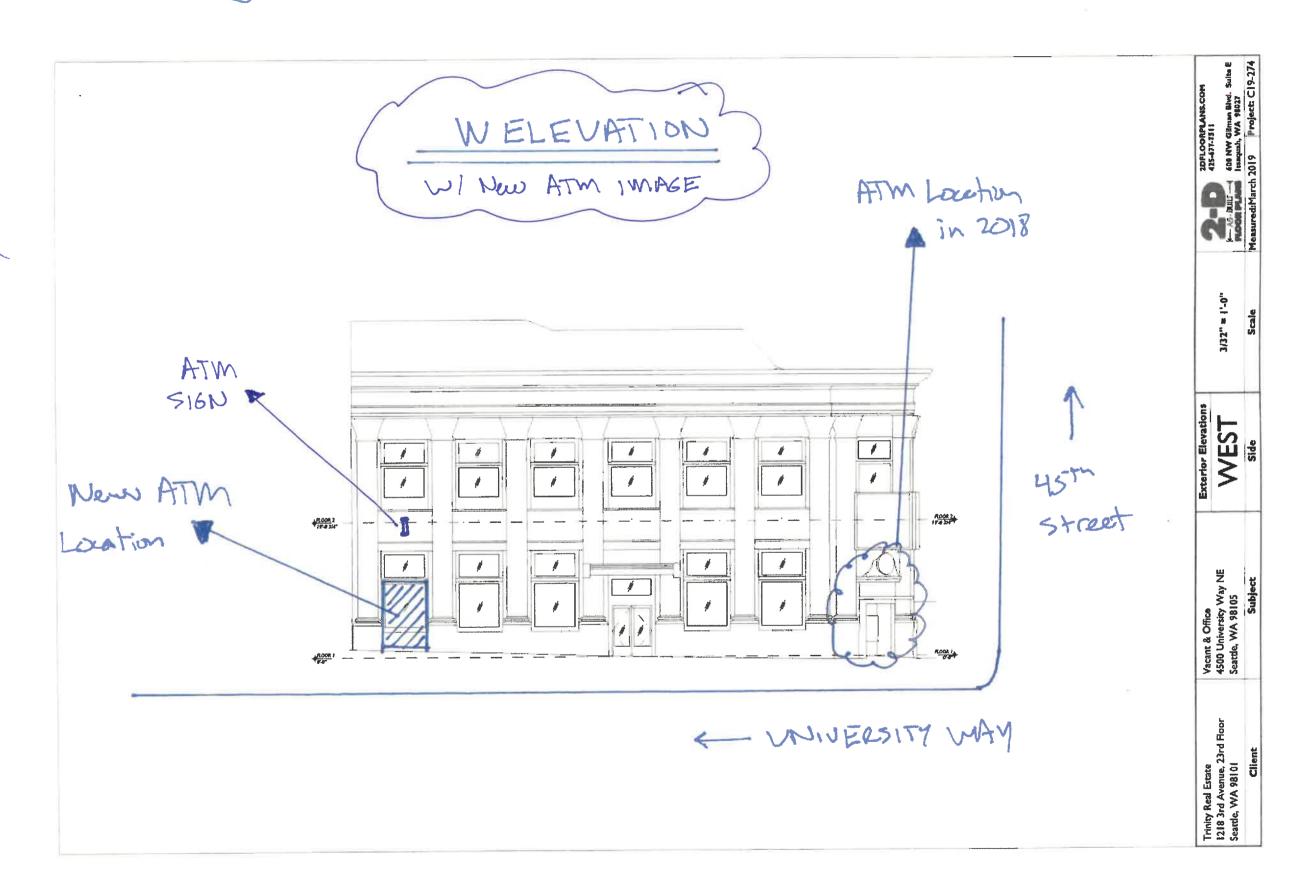


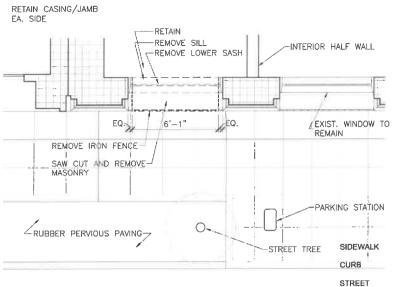


DEMO PLAN NW CORNER


SCALE: 1/4" = 1'- 0"

Key Plan

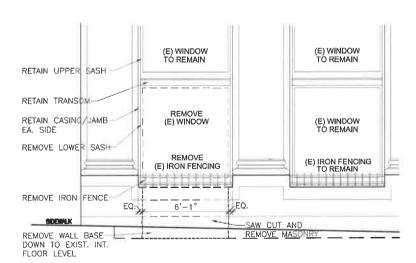


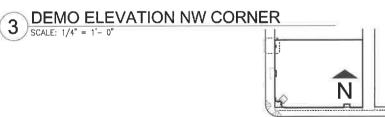

Key Plan

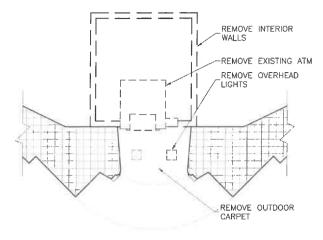

2 DEMO PLAN SW CORNER SCALE: 1/4" = 1'- 0"

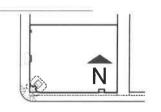

Key Plan

studiq_{meng} strazzara

PLANNING

2001 Western Ave., Suite 200 Seattle, WA USA 98121 206 587 3797 tol 206 587 0588 fax

OWNER

HUNTERS CAPITAL LLC

1620 BROADWAY, SUITE 200 SEATTLE, WA 98122 206-328-3333

TITLE

4500 U WAY ATM

4500 UNIVERSITY WAY NE SEATTLE, WA 98105

SMS PROJECT #: 2020311

STAMP



SDCI PROJECT NUMBER

6809303-CN

ISSUED FOR: DATE:
PERMIT SUBMITTAL 12/04/20

PLAN APPROVAL
DRAWN/CKD BY: PM


CITY STAMPS

SHEET CONTENTS
EXISTING,
DEMO PLANS

SHEET NUMBER

A100

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PLANNING

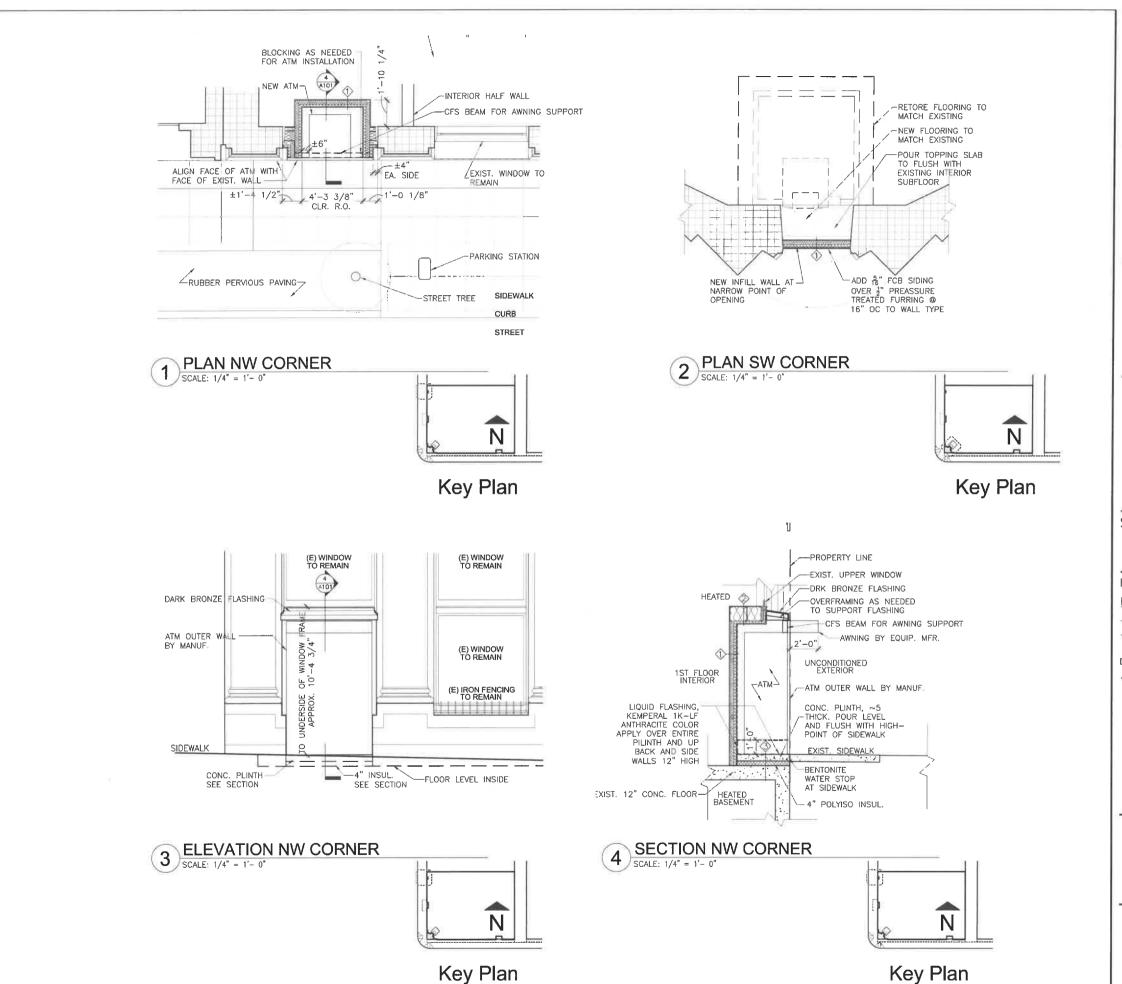2001 Western Ave., Suite 20 Seattle, WA USA 981Z1 206 587 3797 tel 206 587 0588 fax

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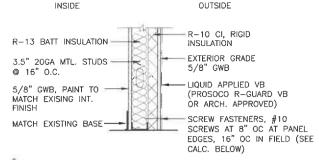
CITY STAMPS

SHEET CONTENTS

FLOOR PLANS ELEVATIONS SECTIONS

SHEET NUMBER

A101



WALL - NEW METAL STUD WITH C.I.

INSULATION CONFORMS TO PRESCRIPTIVE ENVELOPE REQUIREMENTS USING TABLE C402.1.3

SCREW FASTENER SPACING AND AREA

PER TYPICAL 4X8 SHEET, 8" OC AT PANEL EDGES, 16" OC

THIS EQUALS 46 FASTENERS PER 32 SQ FT 1.4375 FASTENERS PER SQ FT

#10 SCREW DIAMETER IS .130"


AREA PER SCREW IS $3.141 \times 0.065^2 = 0.0133$ SQ IN

AREA PER SQ FT IS 0.0133 x 1.4375 = 0.0191 SQ IN

AREA PER SQ FT IS $\frac{100}{144} = \frac{X}{0.0191}$ X = 0.0133%

PER TABLE C402.1.3(g), METAL PENETRATIONS ARE LESS THAN 0.04%, SO INSULATION VALUES IN TABLE C402.1.3 MAY

ASSEMBLY TYPES SCALE: 1" = 1'- 0"

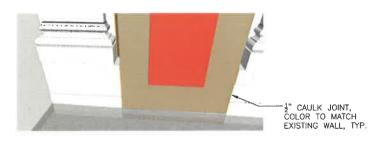

ATM BASE

5/8" GWB, PAINT TO

12" 20GA MTL. STUDS

INSULATION CONFORMS TO PRESCRIPTIVE

ENVELOPE REQUIREMENTS USING TABLE C402.1.3

OR ARCH. APPROVED)

SCREW FASTENER SPACING AND AREA

SEE CALCULATION FOR WALL TYPE 1:

OUTSIDE

FLOOR - NEW METAL FRAME WITH C.I.

MATCH EXISING INT.

@ 16" O.C.

INSULATION

5/8" GWB

R-10 CL RIGID

(CODE MIN. R-4)

EXTERIOR GRADE

-DARK BRONZE SHEET



METAL FLASHING, TYP.

R-38 BATT INSULATION

SCREW FASTENERS, #10


CALC. BELOW)

SCREWS AT 8" OC AT PANEL

EDGES, 16" OC IN FIELD (SEE

ATM UPPER FLASHING

TO RECEIVE UPPER

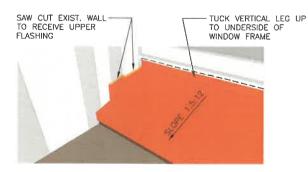

-DARK BRONZE SHEET

METAL FLASHING, TYP.

ATM UPPER FLASHING - CLOSE VIEW

OUTSIDE LIQUID FLASHING, KEMPERAL 1K-LF-ANTHRACITE COLOR NEW 5" CONC. SLAB. R-0.25, HC-9.6 NEW R-22 C.I. 4" = POLYISO, RIGID INSUL. EXIST. 12" CONC FLOOR, R-0.75, HC-28.8 (BECOMES ROOF WITH NEW CONFIGURATION) INSIDE

ROOF - NEW CONC. OVER EXIST. WITH C.I.

PER SECTION C503.3 OF THE SEATTLE ENERGY CODE, WE ARE INSULATING THIS PORTION OF THE ALTERED WALL WITH AN OVERALL HIGHER U-VALUE THAN THE EXISTING WALL.

AS ALLOWED FOR UNDER SECTION C102.2 OF THE SEATTLE ENERGY CODE, WE ARE INSULATING THIS ROOF ASSEMBLY TO THE MAXIMUM EXTENT POSSIBLE, WHILE MAINTAINING A REASONABLE LEVEL OF STRUCTURAL INTEGRITY, AND OVERALL THE MODIFICATION IMPROVES THE ENERGY EFFICIENCY OF THE BUILDING, AND THUS WE BELIEVE THIS ASSEMBLY MAY BE APPROVED DESPITE NOT FULLY MEETING THE PRESCRIPTIVE MIN. INSULATION REQUIREMENTS OF TABLE C402.1.3.

OWNER

STRAZZARA

HUNTERS CAPITAL LLC

206 587 3797 tel 206 587 0588 fax

1620 BROADWAY, SUITE 200 SEATTLE, WA 98122 206-328-3333

 $\mathsf{studic}_{\mathsf{MENG}}$

TITLE

4500 U WAY ATM

4500 UNIVERSITY WAY NE SEATTLE, WA 98105

SMS PROJECT #: 2020311

STAMP



SDCI PROJECT NUMBER

6809303-CN

ISSUED FOR: DATE: 11/09/20

PLAN APPROVAL DRAWN/CKD BY:

CITY STAMPS

SHEET CONTENTS ASSEMBLY TYPES AND DETAILS

SHEET NUMBER



ATM UPPER FLASHING

DETAILS 2 SCALE: NO SCALE

ATM BASE