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WELLER KING/FUJISADA CONDOS


510 6TH AVE S SEATTLE, WA 98104

RFDS: VER: 1 PROJECT: CELL SPLIT

SITE NUMBER: SE03494E

LATITUDE 47° 35′ 52.61″ N (47.597948)

LONGITUDE 122° 19' 32.80" W (-122.325779)

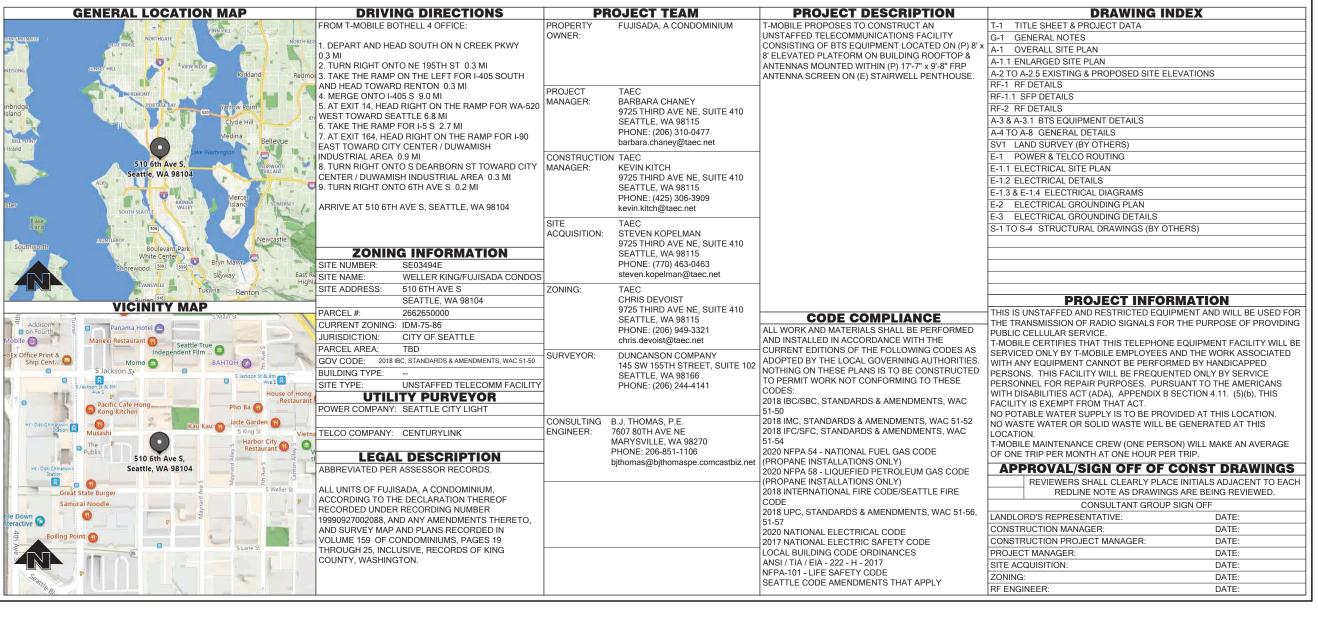

T - - Mobile-

=PROJECT INFORMATION:=

WELLER KING/FUJISADA CONDOS SE03494E

510 6TH AVE S SEATTLE, WA 98104

ISSUED FOR:

-REVISION HISTORY:-

BUILDING PERMIT

NO.	DATE:	DESCRIPTION:	CHK. BY:
19	5/31/2022	UPDATED STRUCTURAL SHEETS ADDED	BJT
18	5/29/2022	UPDATED STRUCTURAL SHEETS ADDED	BJT
17	5/25/2022	MINOR REV	BJT
16	5/24/2022	MINOR REV	BJT
15	5/18/2022	MINOR REV	BJT
14	5/17/2022	REVISED PER OWNER COMMENTS	BJT
13	5/9/2022	REVISED STRUCTURAL SHEETS ADDED	BJT
12	4/28/2022	MINOR REV	BJT
$\overline{\mathbb{A}}$	4/27/2022	MINOR REV	BJT
10	4/20/2022	REVISED PER REDLINES	BJT
9	4/8/2022	RELOCATED ANTENNAS, REVISED PER SITE WALK	BJT

=PLANS PREPARED BY:=

B. J. THOMAS, P.E. 7607 80TH AVE NE MARYSVILLE, WA 98270 206-851-1106

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=LICENSURE:=



JURISDICTIONAL APPROVAL:

DRAWING TITLE:

TITLE SHEET

DRAWING NUMBER:

T-1

GENERAL NOTES:

- 1. DRAWINGS ARE NOT TO BE SCALED, WRITTEN DIMENSIONS TAKE PRECEDENCE, THIS SET OF DOCUMENTS IS INTENDED TO BE USED FOR DIAGRAMMATIC PURPOSED ONLY. UNLESS NOTED OTHERWISE. THE GENERAL CONTRACTOR'S SCOPE OF WORK SHALL INCLUDE FURNISHING ALL MATERIALS, EQUIPMENT, LABOR AND ANY REQUIREMENTS DEEMED NECESSARY TO COMPLETE INSTALLATION AS DESCRIBED IN THE DRAWINGS AND OWNER'S PROJECT MANUAL
- 2. THE CONTRACTOR IS RESPONSIBLE FOR ALL DIMENSIONS AND STANDARDIZED DETAILS THAT REQUIRE MODIFICATIONS DUE TO ACTUAL FIELD CONDITIONS AND REQUIREMENTS MUST BE SUBMITTED TO AND APPROVED BY, T-MOBILE WIRELESS REPRESENTATIVE PRIOR TO START OF WORK.
- 3. PRIOR TO THE SUBMISSION OF BIDS, CONTRACTORS INVOLVED SHALL VISIT THE JOB SITE TO FAMILIARIZE THEMSELVES WITH ALL CONDITIONS AFFECTING THE PROPOSED PROJECT. CONTRACTORS SHALL VISIT THE CONSTRUCTION SITE WITH THE CONSTRUCTION/CONTRACT DOCUMENTS TO VERIEY FIELD CONDITIONS AND CONFIRM THAT THE PROJECT WILL BE ACCOMPLISHED AS SHOWN PRIOR TO PROCEEDING WITH CONSTRUCTION ANY ERRORS OMISSIONS OR DISCREPANCIES SHALL BE BROUGHT TO THE ATTENTION OF THE ARCHITECT/ENGINEER VERBALLY AND IN WRITING.
- 4. THE GENERAL CONTRACTOR SHALL RECEIVE WRITTEN AUTHORIZATION TO PROCEED WITH CONSTRUCTION PRIOR TO STARTING WORK ON ANY ITEM NOT CLEARLY DEFINED BY THE CONSTRUCTION DRAWINGS/CONTRACT DOCUMENTS
- 5. THE CONTRACTOR SHALL SUPERVISE AND DIRECT THE PROJECT DESCRIBED IN THE CONTRACT DOCUMENTS. THE CONTRACTOR SHALL BE SOLELY RESPONSIBLE FOR ALL CONSTRUCTION MEANS, METHODS, TECHNIQUES, SEQUENCES, SAFETY, AND PROCEDURES FOR COORDINATING ALL PORTIONS OF THE WORK UNDER THE CONTRACT.
- 6. THE CONTRACTOR SHALL INSTALL ALL EQUIPMENT AND MATERIALS ACCORDING TO MANUFACTURER'S/VENDOR'S SPECIFICATIONS UNLESS NOTED OTHERWISE OR WHERE LOCAL CODES OR ORDINANCES TAKE PRECEDENCE.
- 7. ALL WORK PERFORMED ON THE PROJECT AND MATERIALS INSTALLED SHALL BE IN STRICT ACCORDANCE WITH ALL APPLICABLE CODES, REGULATIONS, AND ORDINANCES. CONTRACTOR SHALL GIVE ALL NOTICES AND COMPLY WITH ALL LAWS, ORDINANCES, RULES, REGULATIONS AND LAWFUL ORDERS OF ANY PUBLIC AUTHORITY, MUNICIPAL AND UTILITY, COMPANY SPECIFICATIONS, AND LOCAL AND STATE JURISDICTIONAL CODES BEARING ON THE PERFORMANCE OF THE WORK
- 8. GENERAL CONTRACTOR SHALL PROVIDE, AT THE PROJECT SITE, A FULL SET OF CONSTRUCTION DOCUMENTS UPDATED WITH THE LATEST REVISIONS INVOLVED WITH THE PROJECT. THIS SET IS A VALID CONTRACT DOCUMENT ONLY IF THE TITLE SHEET IS STAMPED IN RED INK "FOR CONSTRUCTION" AND EACH SUCCESSIVE SHEET BEARS THE ARCHITECT'S/ENGINEER'S SIGNED WET STAMP
- 9. THE CONTRACTOR IS RESPONSIBLE FOR ADEQUATELY BRACING AND PROTECTING ALL WORK DURING CONSTRUCTION AGAINST DAMAGE, BREAKAGE, COLLAPSE, ETC. ACCORDING TO APPLICABLE CODES, STANDARDS, AND GOOD CONSTRUCTION PRACTICES
- 10. THE CONTRACTOR SHALL MEET ALL OSHA REQUIREMENTS FOR ALL INSTALLATIONS.
- 11. THE CONTRACTOR SHALL BE RESPONSIBLE FOR ALL DAMAGES TO THE EXISTING CONSTRUCTION AND REPAIR ALL DAMAGES TO BETTER THAN NEW CONSTRUCTION. THE CONTRACTOR SHALL NOTIFY THE CONSULTANT OF ANY DAMAGE TO THE BUILDING SITE OR ANY ADJACENT STRUCTURES AROUND THE PROJECT. THE T-MOBILE REPRESENTATIVE SHALL BE SOLE AND FINAL JUDGE AS TO THE QUALITY OF THE REPAIRED CONSTRUCTION. ANY ADDITIONAL MODIFICATIONS WHICH MUST BE MADE SHALL BE MADE AT THE CONTRACTOR'S EXPENSE
- 12. WHERE NEW PAVING, CONCRETE SIDEWALKS OR PATHS MEET EXISTING CONSTRUCTION, THE CONTRACTOR SHALL MATCH THE EXISTING PITCH, GRADE, AND ELEVATION SO THE ENTIRE STRUCTURE SHALL HAVE A SMOOTH TRANSITION.
- 13. THE CONTRACTOR SHALL MODIFY THE EXISTING FLOORS, WALL, CEILING, OR OTHER CONSTRUCTION AS REQUIRED TO GAIN ACCESS TO AREAS FOR ALL MECHANICAL, PLUMBING, ELECTRICAL, OR STRUCTURAL MODIFICATIONS. WHERE THE EXISTING CONSTRUCTION DOORS. PARTITIONS, CEILING, ETC., ARE TO BE REMOVED, MODIFIED, OR REARRANGED OR WHERE THE EXPOSED OR HIDDEN MECHANICAL, ELECTRICAL, SYSTEMS ARE ADDED OR MODIFIED, THE GENERAL CONTRACTOR SHALL REPAIR, PATCH AND MATCH ALL EXISTING CONSTRUCTION AND FINISHES OF ALL FLOORS WALLS AND CEILINGS. WHERE CONCRETE MASONRY CONSTRUCTION IS MODIFIED, THE CONTRACTOR SHALL TOOTH IN ALL NEW CONSTRUCTION TO MATCH THE EXISTING BOND. WHERE CONCRETE CONSTRUCTION IS MODIFIED, THE CONTRACTOR SHALL VERIFY THE EXACT DETAILS TO BE USED FOR CONSTRUCTION. ALL WORK SHALL BE COVERED UNDER THE GENERAL CONTRACT
- 14. IF CONTRACTOR OR SUBCONTRACTOR FIND IT NECESSARY TO DEVIATE FROM ORIGINAL APPROVED PLANS. THEN IT IS THE CONTRACTOR'S AND THE SUBCONTRACTOR'S RESPONSIBILITY TO PROVIDE THE CONSULTANT WITH 4 COPIES OF THE PROPOSED CHANGES FOR HIS APPROVAL BEFORE PROCEEDING WITH THE WORK. IN ADDITION THE CONTRACTOR AND SUBCONTRACTORS SHALL BE RESPONSIBLE FOR PROCURING ALL NECESSARY APPROVALS FROM THE BUILDING AUTHORITIES FOR THE PROPOSED CHANGES BEFORE PROCEEDING WITH THE WORK. THE CONTRACTOR AND SUBCONTRACTORS SHALL BE RESPONSIBLE FOR PROCURING ALL NECESSARY INSPECTIONS AND APPROVALS FROM BUILDING AUTHORITIES DURING THE EXECUTION OF THE WORK.
- 15. CONTRACTOR TO PROVIDE A PORTABLE FIRE EXTINGUISHER WITH A RATING OF NOT LESS THAN 2-A OR 2-A10BC WITHIN 75 FEET TRAVEL DISTANCE TO ALL PORTIONS OF PROJECT AREA DURING CONSTRUCTION
- 16. THE CONTRACTOR SHALL PERFORM WORK DURING OWNER'S PREFERRED HOURS TO AVOID DISTURBING NORMAL BUSINESS
- 17. SEAL ALL PENETRATIONS THROUGH FIRE-RATED AREAS WITH U.L. LISTED OR FIRE MARSHAL APPROVED MATERIALS AS APPLICABLE TO THIS FACILITY AND OR PROJECT SITE.
- 18. CONTRACTOR SHALL BE RESPONSIBLE FOR UTILITY LOCATES, SCHEDULING, COORDINATING SPECIAL AND BUILDING DEPARTMENT INSPECTIONS
- 19. CONTRACTOR SHALL BE RESPONSIBLE FOR CONTACTING AND UTILIZING ORIGINAL ROOFING CONTRACTOR AS REQUIRED TO MAINTAIN ANY EXISTING ROOFING WARRANTY.
- 20. ROUTING OF ALL CONDUITS, CABLES, CABLE TRAYS ETC ARE INDICATED AS PROPOSED LOCATION ONLY. CONFIRM THE EXACT LOCATION AND ROUTING WITH THE ON SITE T-MOBILE CONSTRUCTION MANAGER PRIOR TO STARTING WORK

ABBREVIATIONS

AC AF AF AL	F G S UM	AIR CONDITIONER ABOVE FINISHED FLOOR ABOVE FINISHED GRADE ABOVE FINISHED SLAB ALUMINUM ANCHOR BOLT	JT LAM LF MANUF MAX MECH MH	JOINT LAMINATED LINEAL FOOT MANUFACTURER MAXIMUM MECHANICAL MANHOLE
AR BT: BLI BM BO BO BO	ICH S DG I IT	ANGLE ARCHITECTURAL BASE TRANSMISSION SYSTEM BUILDING BEAM BOTTOM BOTTOM OF BOTTOM OF CONCRETE BOTTOM OF STEEL CONTROL JOINT CENTER LINE	MM MIN MISC MPH MTL NIC NOM NTS OC	MANTOLE MILLIMETER MINIMUM MISCELLANEOUS MILES PER HOUR METAL NOT IN CONTRACT NOMINAL NOT TO SCALE ON CENTER OUTSIDE DIAMETER
COCTAT A LI QWXXX INFILITAGAYBHOR IV	GRIULIONT BULINOST BU	CENTER LINE CEILING CLEAR CONCRETE MASONRY UNIT COLUMN CONCRETE CONSTRUCTION CONTINUOUS CENTER DIAMETER DETAIL EXISTING EACH EXPANSION JOINT ELECTRIC/ELECTRICAL ELEVATION EQUAL EACH WAY EXPANSION EXTERIOR FLOOR DRAIN FINISH FINISH FLOOR FLOOR FLOOR FLOOR GAUGE GALVANIZED GYPSUM GYPSUM GYPSUM GYPSUM HORIZONTAL HOUR HEIGHT HEATING VENTILATION AIR CONDITIONING INSULATION INTERIOR	ÖD OH OPNG OPPNG OPPP PRSI PRSI PRSI PRSI PRSI PRSI PRSI P	OUTSIDE DIJAME IER OVERHEAD OPENING OPPOSITE PROPOSED PERSONAL COMMUNICATION SYSTEM PLATE PAIR POUNDS PER SQUARE INCH POUNDS PER SQUARE FOOT PRESSURE TREATED RADIUS ROOF DRAIN REINFORCED/REINFORCING REQUIRED ROOM RIGHT OF WAY SCHEDULE SECTION SQUARE FOOT SIMILAR SQUARE FOOT SIMILAR SQUARE FOOT STAINLESS STEEL STANDARD STEEL STRUCTURAL TEMPORARY THICK TOP OF STEEL TOP OF CONCRETE TYPICAL UNLESS NOTED OTHERWISE VINYL COMPOSITION TILE VERTICAL WITH

LEGENDS & SYMBOLS

HAIN LINK FENCE	_ x x x x x x
EDAR FENCE	$-\Gamma$
OWER	- P — P — P — P — P — P — P
ELCO	$ \tau \tau \tau \tau \tau \tau \tau -$
OWER/TELCO	- P — T — P — T — P — T — P — T
OAX	- COAX — COAX — COAX — COAX
VERHEAD POWER	—-ОН——-ОН——-ОН——-ОН——-ОН——-
ENTERLINE	
EVISION BUG	1
	DETAIL NUMBER
LEVATION VIEW BUG	
	SHEET NUMBER
LEVATION VIEW BUG	TOP OF XXXXX
	XXX'-X" AGL
ETAIL BUG	DETAIL NUMBER
2.7.112.2003	SHEET NUMBER
	DETAIL NUMBER
ECTION BUG	
	SHEET NUMBER

SPECIAL INSPECTIONS:

SPECIAL INSPECTIONS IN ACCORDANCE WITH IBC 2018 SECTION 1704.

SOILS/GEOTECHNICAL:

- ☐ SHORING INSTALLATION AND MONITORING
 - ☐ OBSERVE AND MONITOR EXCAVATION
 - □ VERIFY SOIL BEARING psf BEARING
 - ☐ SUBSURFACE DRAINAGE PLACEMENT
 - □ VERIFY FILL MATERIAL AND COMPACTION
 - □ VERIFY CONDITIONS AS ANTICIPATED ☐ PILE PLACEMENT (AUGER CAST/DRIVEN PILE)
 - □ OTHER

REINFORCED CONCRETE:

- ☐ REINFORCING STEEL AND CONCRETE PLACEMENT
- ☐ PRESTRESSED/PRECAST CONCRETE FABRICATION AND ERECTION
- ☐ BATCH PLANT INSPECTION
- □ SHOTCRETE
- □ GROUTING □ OTHER

STRUCTURAL STEEL:

- ☐ FABRICATION AND SHOP WELDS
- ☐ ERECTION AND FIELD WELDS AND BOLTING
- □ OTHER:

STRUCTURAL ALUMINUM:

- ☐ FABRICATION AND SHOP WELDS
- ☐ ERECTION AND FIELD WELDS AND BOLTING
- □ OTHER:

STRUCTURAL MASONRY:

- □ CONTINUOUS
- □ PERIODIC
- □ OTHER:

MISCELLANEOUS

□ OTHER:

ANCHORING TO CONCRETE:

- ☐ BOLTS INSTALLED IN CONCRETE
- ☐ POST-INSTALLATION ADHESIVE ANCHORS

SAFETY PRECAUTION SHALL
BE IMPLEMENTED BY
CONTRACTOR(S) AT ALL
TRENCHING IN ACCORDANCE

WITH CURRENT OSHA STANDARDS

☐ POST-INSTALLATION MECHANICAL ANCHORS

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<u></u>	4/8/2022	RELOCATED ANTENNAS, REVISED PER SITE WALK	BJT
-DI A	NS DRFE	ARED BY:	

=PLANS PREPARED BY:==

B. J. THOMAS, P.E. **7607 80TH AVE NE MARYSVILLE, WA 98270** 206-851-1106

=DRAWN	BY:====	снк.	BY:

BJ

=LICENSURE:=



JURISDICTIONAL APPROVAL:

DRAWING TITLE:

GENERAL NOTES

=DRAWING NUMBER:=====

CALL TWO WORKING DAYS BEFORE YOU DIG

811

NATIONAL UTILITIES UNDERGROUND LOCATE

TEL/CATV - ORANGE

PROPOSED - WHITE


WATER - BLUE

ELECTRIC - RED

SEWER - GREEN

GAS/OIL - YELLOW

SURVEY - PINK

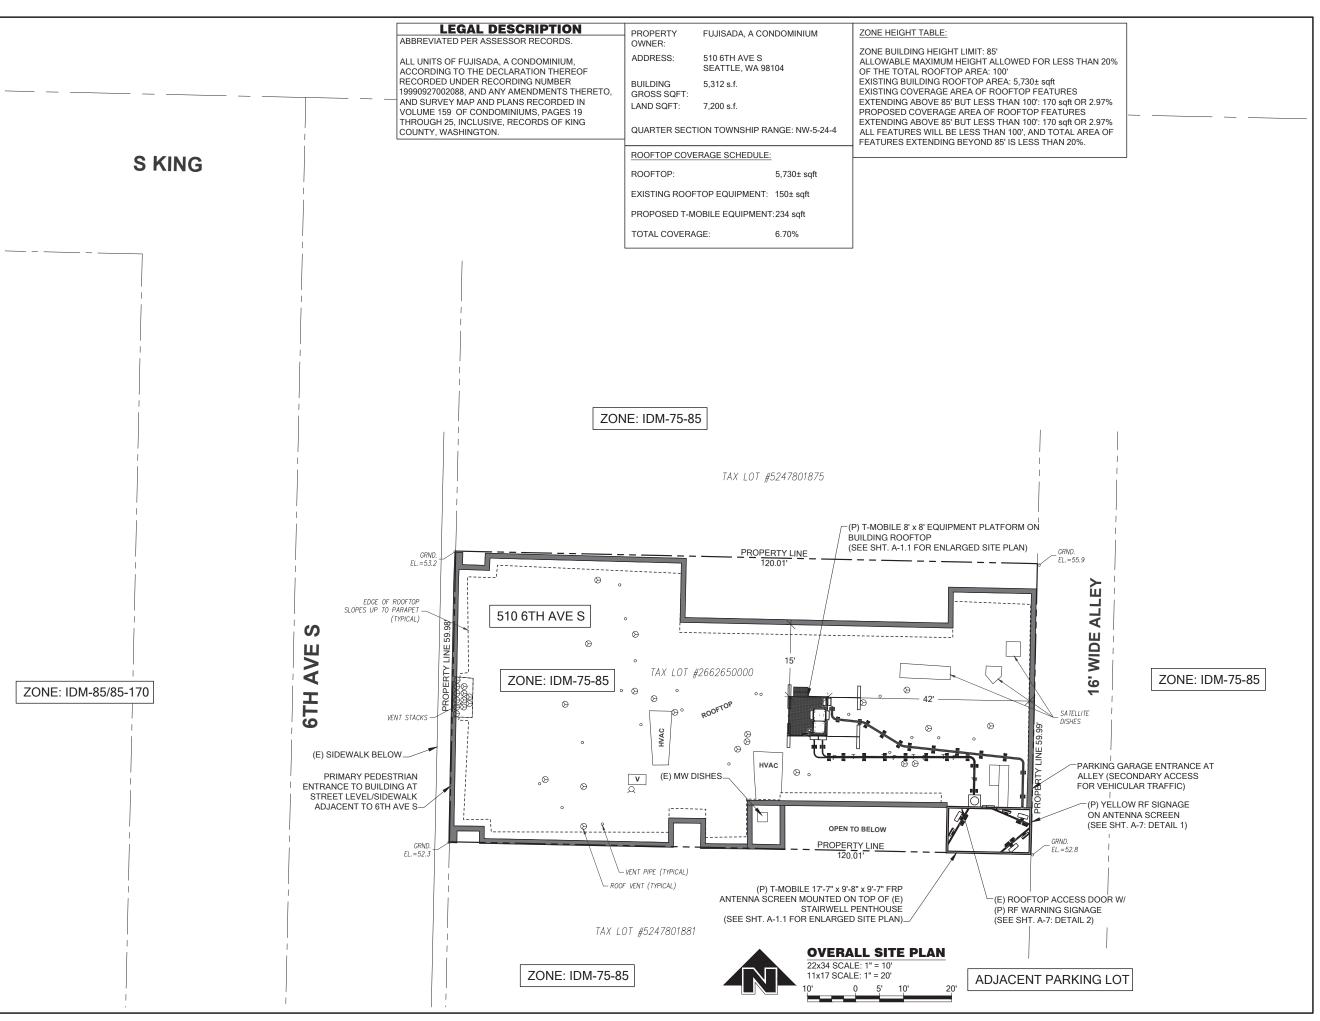

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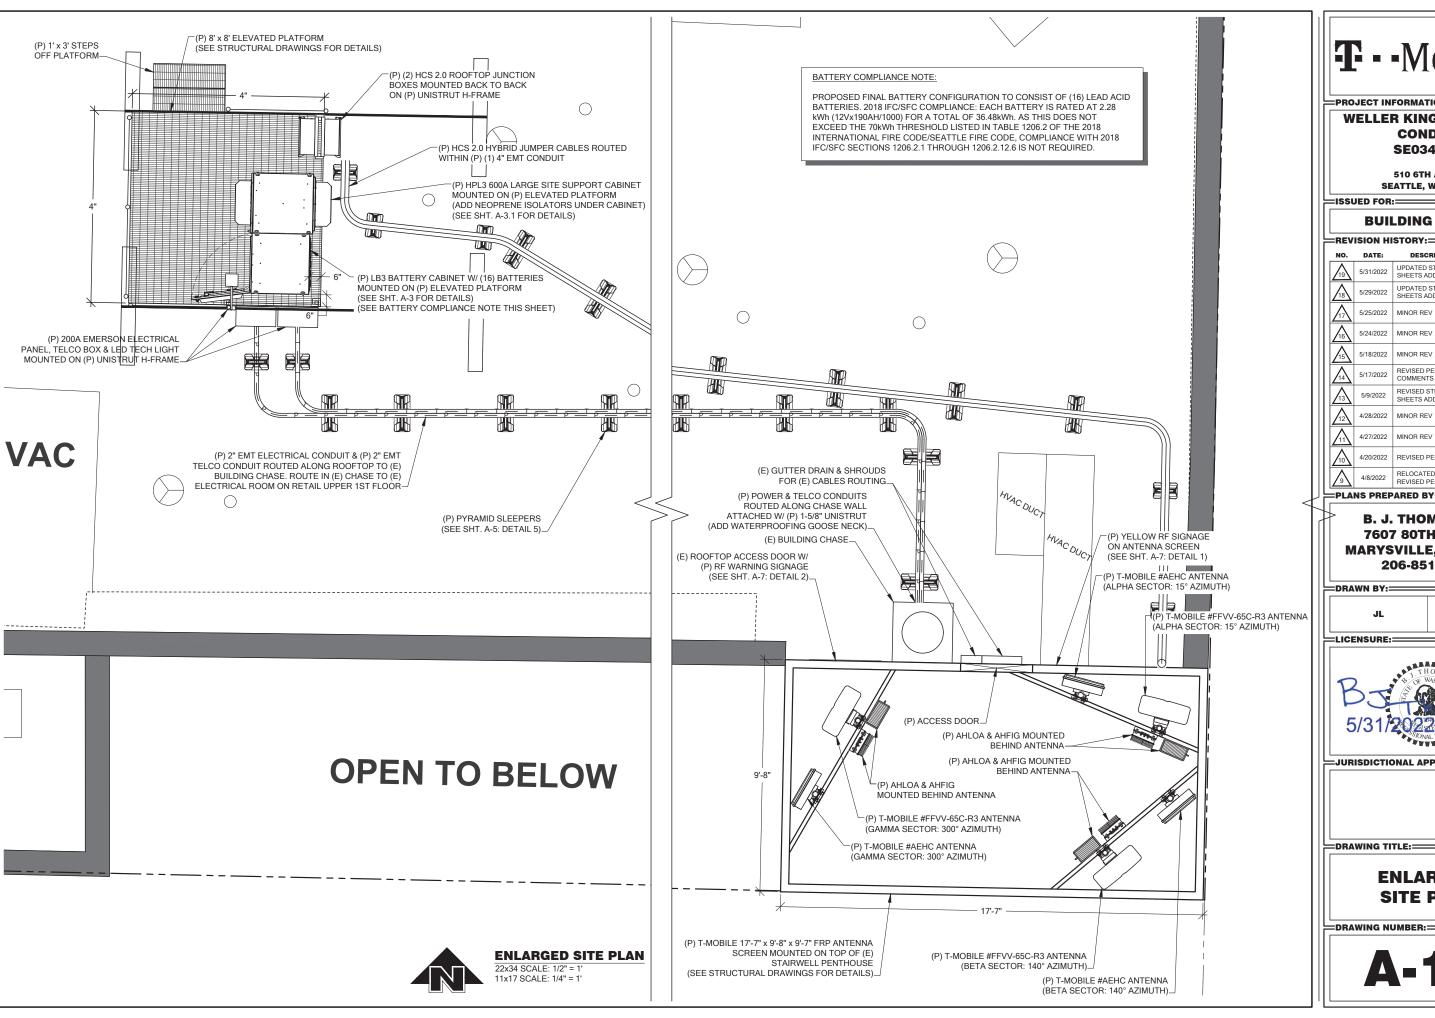
=JURISDICTIONAL APPROVAL: ==

DRAWING TITLE:

OVERALL SITE PLAN

DRAWING NUMBER:

A-1



PROJECT INFORMATION:

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B. J. THOMAS, P.E. **7607 80TH AVE NE MARYSVILLE, WA 98270** 206-851-1106

DRAWN BY: CHK. BY:

LICENSURE:



=JURISDICTIONAL APPROVAL: ==

DRAWING TITLE:

ENLARGED SITE PLAN

=DRAWING NUMBER:====

TOP OF PENTHOUSE 90°-5" (90.4") AGL (E) ROOF LEVEL 80°-1" (80.1") AGL €	SCREEN WALL ENCLOSURE DESIGN NOTE: PROPOSED SCREEN WALL WILL BE CONSTRUCTED WITH AN EXTERIOR FINISH OF RETRANSPARENT FIRP DESIGNED TO MATCH THE COLOR AND TEXTURE OF THE EXISTING HORIZONTAL LAP SIDING AND TEXTURE OF THE EXISTING HORIZONTAL SET OF THE EXISTING HORIZONTAL SET OF THE EXISTING HORIZONTAL WITH STAND AND TEXTURE OF THE EXISTING HORIZONTAL WITH STAND AND MATCH, GC TO CONFIRM PHYSICAL MATCH ON SITE AND VERIFY) WE (P) T-MOBILE ANTENNAS & RADIOS MOUNTED WITHIN (P) 17-7" x 9-8" x 9-7" FRP ANTENNA SCREEN MOUNTED ON (E) STARWELL PENTHOUSE (P) T-MOBILE ANTENNAS & RADIOS MOUNTED WITHIN (P) 17-7" x 9-8" x 9-7" FRP ANTENNA SCREEN MOUNTED ON (E) STARWELL PENTHOUSE (P) T-MOBILE ANTENNAS & RADIOS MOUNTED WITHIN (P) 17-7" x 9-8" x 9-7" FRP ANTENNA SCREEN MOUNTED ON (E) STARWELL PENTHOUSE (P) T-MOBILE ANTENNAS & RADIOS MOUNTED WITHIN (P) 17-7" x 9-8" x 9-7" FRP ANTENNA SCREEN MOUNTED ON (E) STARWELL PENTHOUSE (P) T-MOBILE ANTENNAS & RADIOS MOUNTED WITHIN (P) 17-7" x 9-8" x 9-7" FRP ANTENNA SCREEN MOUNTED ON (E) STARWELL PENTHOUSE (P) T-MOBILE ANTENNAS & RADIOS MOUNTED WITHIN (P) 17-7" x 9-8" x 9-7" FRP ANTENNA SCREEN MOUNTED ON (E) STARWELL PENTHOUSE (P) T-MOBILE ANTENNAS & RADIOS MOUNTED WITHIN (P) 17-7" x 9-8" x 9-7" FRP ANTENNA SCREEN MOUNTED ON (E) STARWELL PENTHOUSE (P) T-MOBILE ANTENNAS & RADIOS MOUNTED WITHIN (P) 17-7" x 9-8" x 9-7" FRP ANTENNA SCREEN MOUNTED ON (E) STARWELL PENTHOUSE (P) T-MOBILE ANTENNAS & RADIOS MOUNTED WITHIN (P) 17-7" x 9-8" x 9-7" FRP ANTENNA (P) T-MOBILE ANTENNAS & RADIOS MOUNTED WITHIN (P) 17-7" x 9-8" x 9-7" FRP ANTENNA (P) T-MOBILE ANTENNAS & RADIOS MOUNTED WITHIN (P) 17-7" x 9-8" x 9-7" FRP ANTENNA (P) T-MO
GROUND LEVEL 1 EXISTING WEST ELEVATION A2 SCALE: NTS	GROUND LEVEL PROPOSED WEST ELEVATION A2 SCALE: NTS PLAN: PLAN:

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PLANS PREPARED BY:

B. J. THOMAS, P.E. 7607 80TH AVE NE MARYSVILLE, WA 98270 206-851-1106

DRAWN BY:----CHK. BY:-

JL BJ

=LICENSURE:==



=JURISDICTIONAL APPROVAL: ===

DRAWING TITLE:

SITE ELEVATION

DRAWING NUMBER:

A-2

					TOD OF DENTHOUSE
					TOP OF PENTHOUSE 90'-5" (90.4') AGL
					TOP OF PARAPET
					TOP OF PARAPET 83'-1" (83.1') AGL (E) ROOF LEVEL 80'-1" (80.1') AGL
		<u>'</u>			
/					
	CPOLINID LEVEL				

1 EXISTING SOUTH ELEVATION

A-2.1 SCALE: NTS

T - - Mobile-

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PLANS PREPARED BY:

9 4/8/2022 RELOCATED ANTENNAS, REVISED PER SITE WALK

B. J. THOMAS, P.E. **7607 80TH AVE NE MARYSVILLE, WA 98270** 206-851-1106

DRAWN BY: CHK.	B
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BJ


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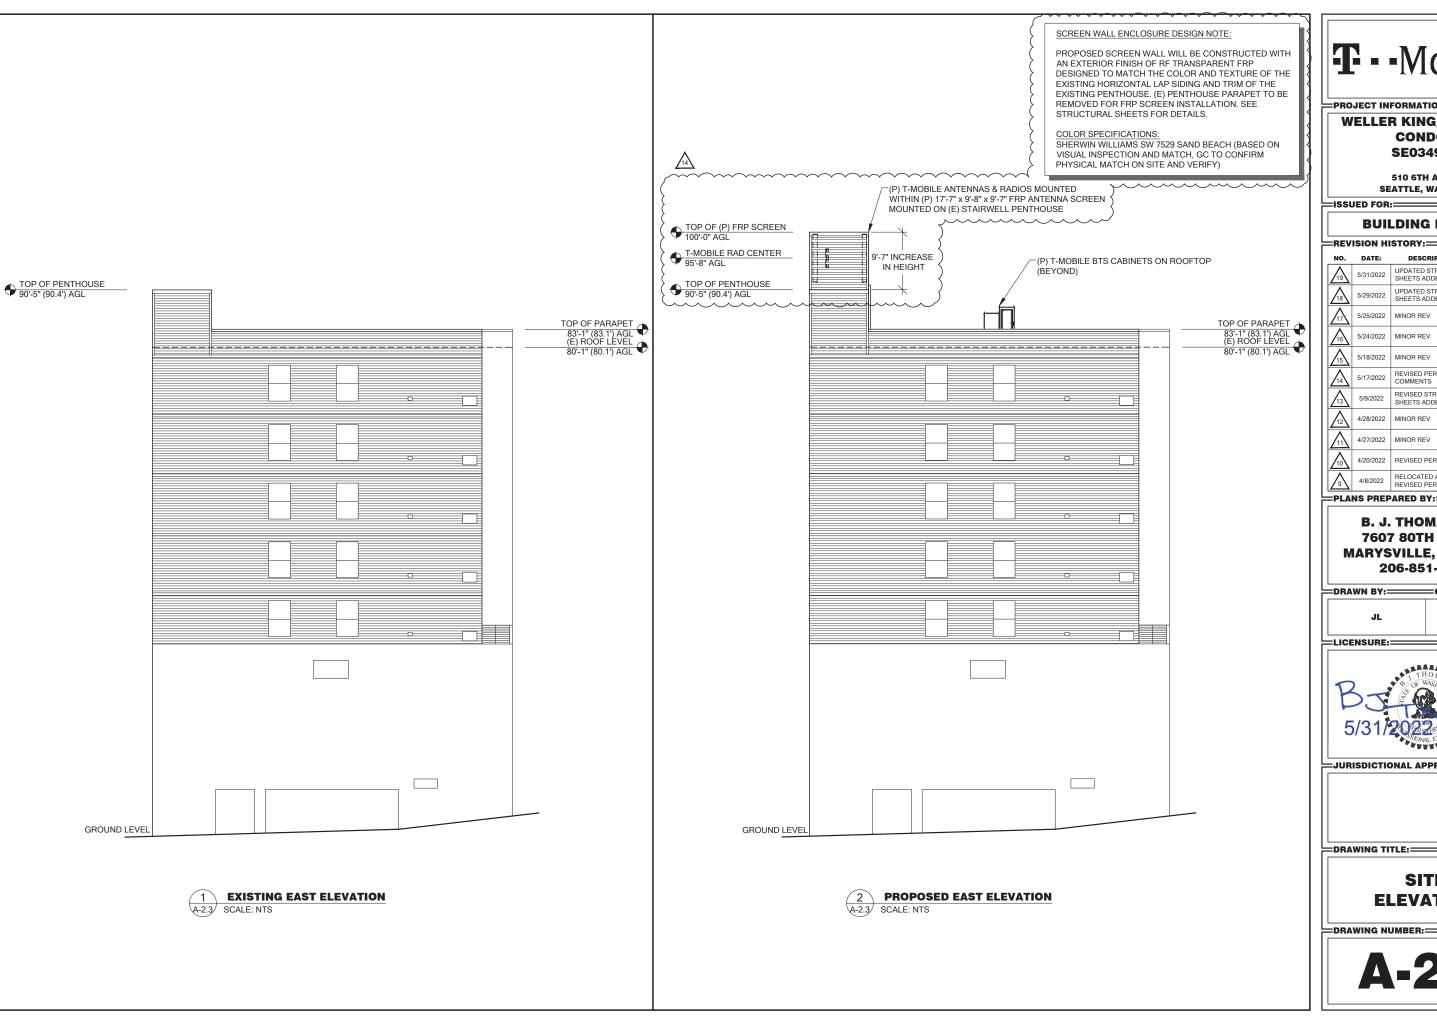
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9	4/8/2022	RELOCATED ANTENNAS, REVISED PER SITE WALK	BJT

PLANS PREPARED BY:

B. J. THOMAS, P.E. **7607 80TH AVE NE MARYSVILLE, WA 98270** 206-851-1106

DRAWN BY: CHK. BY:

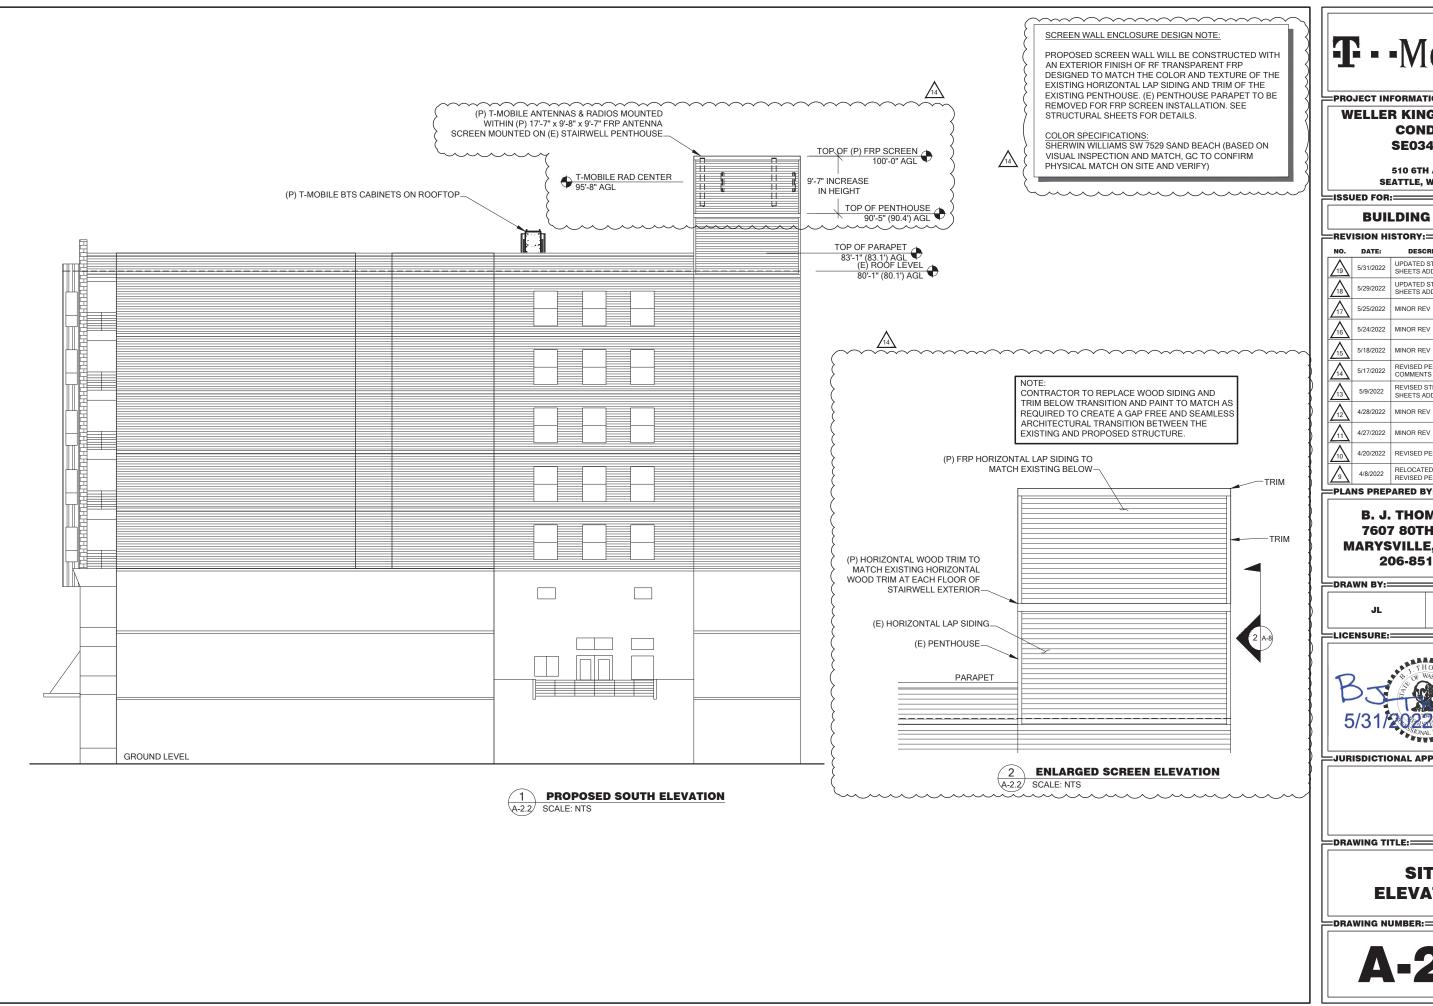

__JURISDICTIONAL APPROVAL: ___

DRAWING TITLE:

SITE **ELEVATION**

TOP OF PENTHOUSE 90'-5" (90.4') AGL TOP OF PARAPET 83'-1" (83.1') AGL (E) ROOF LEVEL 80'-1" (80.1') AGL -0-0-GROUND LEVEL

1 EXISTING NORTH ELEVATION
A-2.4 SCALE: NTS

T - Mobile-

PROJECT INFORMATION:

WELLER KING/FUJISADA CONDOS SE03494E

510 6TH AVE S SEATTLE, WA 98104

SSUED FOR:

BUILDING PERMIT

=RFV	ISION H	ISTORY:	
NO.	DATE:	DESCRIPTION:	CHK. BY:
19	5/31/2022	UPDATED STRUCTURAL SHEETS ADDED	BJT
18	5/29/2022	UPDATED STRUCTURAL SHEETS ADDED	BJT
17	5/25/2022	MINOR REV	BJT
16	5/24/2022	MINOR REV	ВЈТ
15	5/18/2022	MINOR REV	BJT
14	5/17/2022	REVISED PER OWNER COMMENTS	BJT
13	5/9/2022	REVISED STRUCTURAL SHEETS ADDED	ВЈТ
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10	4/20/2022	REVISED PER REDLINES	BJT
/9\	4/8/2022	RELOCATED ANTENNAS, REVISED PER SITE WALK	BJT

PLANS PREPARED BY:

B. J. THOMAS, P.E. 7607 80TH AVE NE MARYSVILLE, WA 98270 206-851-1106

DRAWN B	Y:	=снк.	BY:==

JL

LICENSURE:




JURISDICTIONAL APPROVAL:

DRAWING TITLE:

SITE ELEVATION

DRAWING NUMBER:

A-2.4

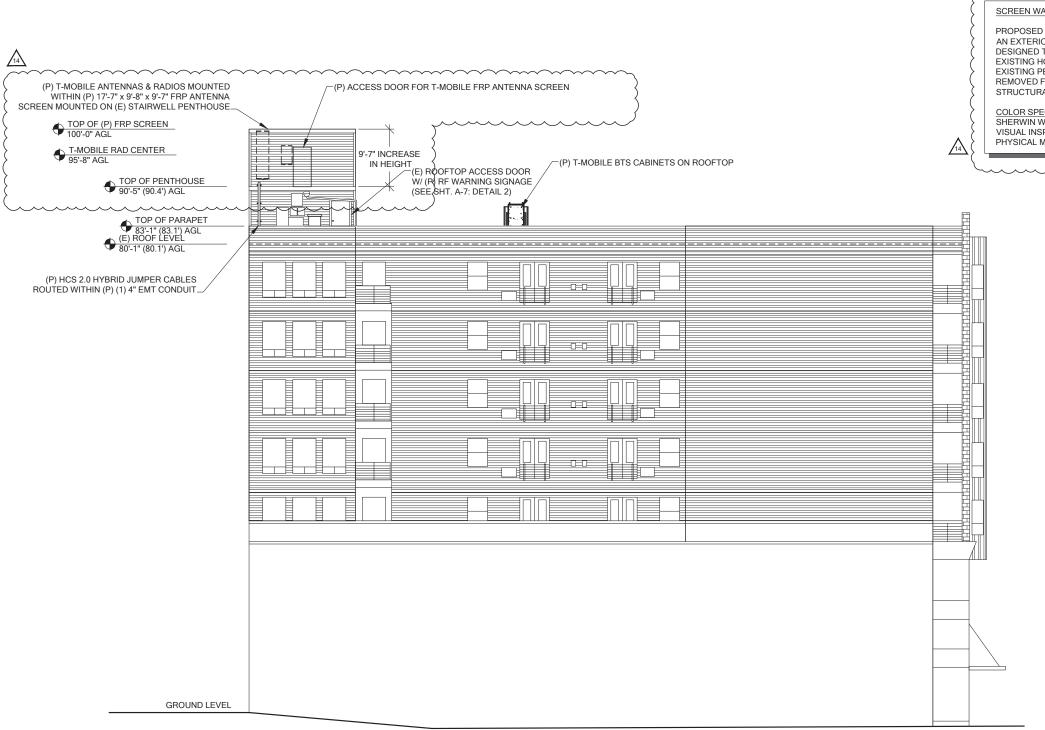

1 PROPOSED NORTH ELEVATION
A-2.5 SCALE: NTS

SCREEN WALL ENCLOSURE DESIGN NOTE:

PROPOSED SCREEN WALL WILL BE CONSTRUCTED WITH AN EXTERIOR FINISH OF RF TRANSPARENT FRP DESIGNED TO MATCH THE COLOR AND TEXTURE OF THE EXISTING HORIZONTAL LAP SIDING AND TRIM OF THE EXISTING PENTHOUSE. (E) PENTHOUSE PARAPET TO BE REMOVED FOR FRP SCREEN INSTALLATION. SEE STRUCTURAL SHEETS FOR DETAILS.

COLOR SPECIFICATIONS: SHERWIN WILLIAMS SW 7529 SAND BEACH (BASED ON VISUAL INSPECTION AND MATCH, GC TO CONFIRM PHYSICAL MATCH ON SITE AND VERIFY) **T** - - Mobile-

PROJECT INFORMATION:

WELLER KING/FUJISADA CONDOS SE03494E

510 6TH AVE S SEATTLE, WA 98104

SSUED FOR:=

BUILDING PERMIT

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PLANS PREPARED BY:

B. J. THOMAS, P.E. 7607 80TH AVE NE MARYSVILLE, WA 98270 206-851-1106

DRAWN BY: CHK. BY:

LICENSURE:



JURISDICTIONAL APPROVAL:

DRAWING TITLE:

SITE ELEVATION


DRAWING NUMBER:

A-2.5

"FINAL" SITE LOADING CHART


SECTOR	COLOR	POSITION	ANTENNA MODEL #	VENDOR	AZIMUTH (TN)	RADIATION CENTER	HYBRID CABLE LENGTH	COAX CABLES	ADDITIONAL EQUIPMENT
ALPHA	RED	1 2	FFVV-65C-R3-V1 AEHC	COMMSCOPE	15°	95'-8" AGL 95'-8" AGL			(1) AHLOA (1) AHFIG
ВЕТА	GREEN	1 2	FFVV-65C-R3-V1 AEHC	COMMSCOPE NOKIA	140°	95'-8" AGL 95'-8" AGL	HCS 2.0 HYBRID JUMPER CABLES	N/A	(1) AHLOA (1) AHFIG
GAMMA	BLUE	1 2	FFVV-65C-R3-V1 AEHC	COMMSCOPE NOKIA	300°	95'-8" AGL 95'-8" AGL			(1) AHLOA (1) AHFIG

	RFDS
PROJECT TYPE	CELL SPLIT
RFDS VERSION	1

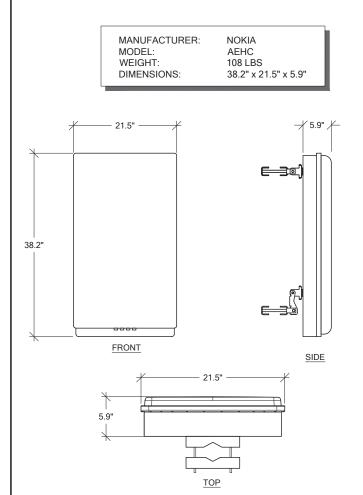


1 AEHC DETAIL

RF-1 SCALE: NTS

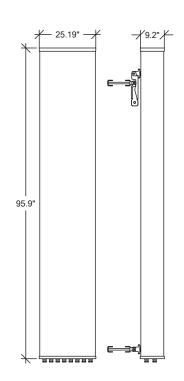

CON	MS	COPE	AN	ΓΕΝΝ	A DA	TA	\	
MECHANICAL SPECIFICATIONS								
PART NUMBER		HEIGHT	V	VIDTH	DEP	TH	WE	IGHT
FFVV-65C-R3-V	1	95.9 in	2	5.19 in	9.2 ii	า	124	l.5 lbs
CONNECTORS	STAN	IDARD MO	NTNUC	NG HARE	WARE			
(8) 7-16 DIN	INCL	UDED						
ELECTRICAL S	SPECI	FICATION	NS.					
FREQUENCY	POLA	RIZATION	GAIN		AZIMU [*]	ТН В	.W.	
617-2690 MHz	617-2690 MHz ±45° 16-18.6 dBi 57°- 68°							
	VSWR MAX INPUT POWER ELEVATION B.W.						1.	
	<1.5:1	250 W	ATTS		4.1° - 1	0.2°		

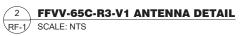

T - - Mobile-

PROJECT INFORMATION:

WELLER KING/FUJISADA CONDOS SE03494E

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PLANS PREPARED BY:

B. J. THOMAS, P.E. 7607 80TH AVE NE MARYSVILLE, WA 98270 206-851-1106

DRAWN BY: CHK. BY:

LICENSURE:




JURISDICTIONAL APPROVAL:

DRAWING TITLE:

RF DETAILS

DRAWING NUMBER:

RF-1

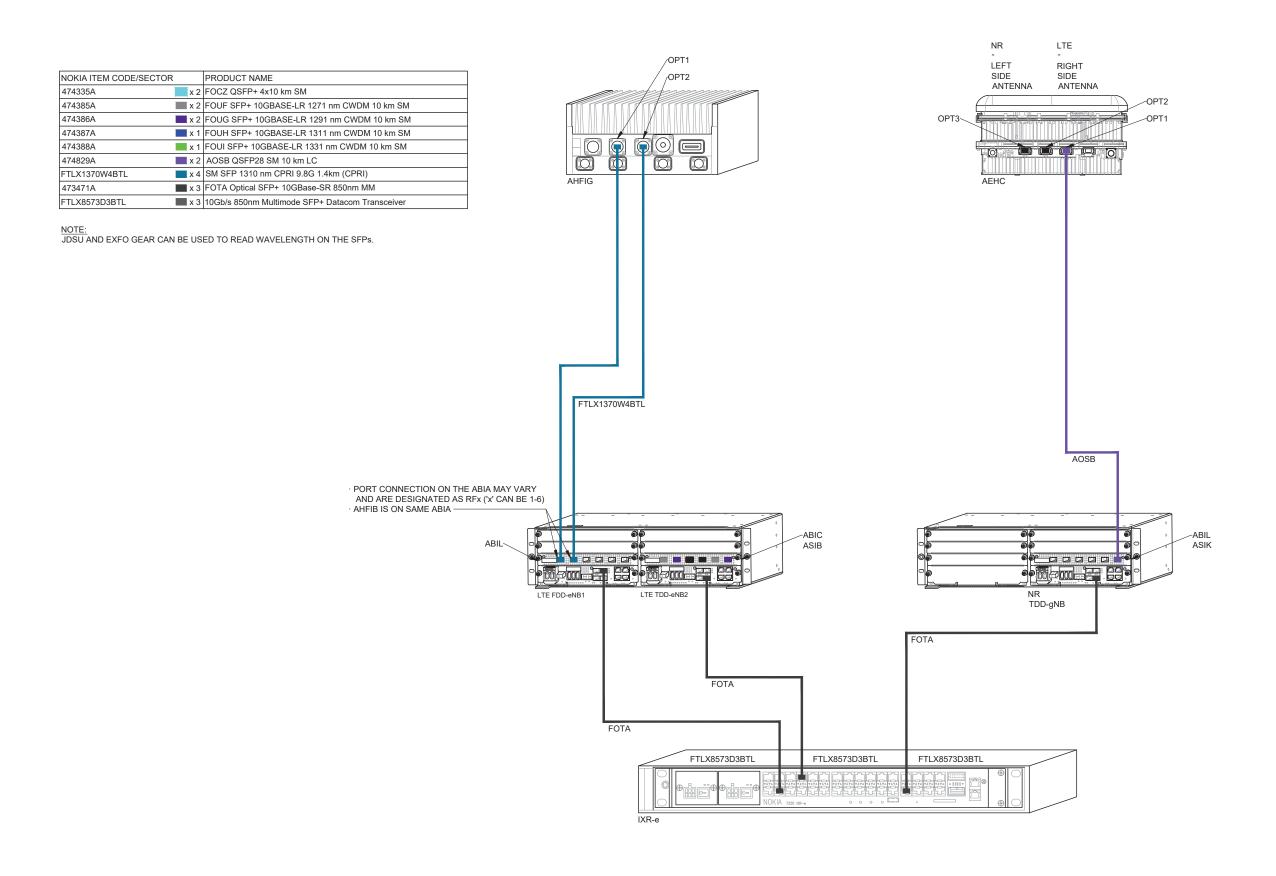

PROJECT INFORMATION:

WELLER KING/FUJISADA CONDOS SE03494E

510 6TH AVE S SEATTLE, WA 98104

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PLANS PREPARED BY:

B. J. THOMAS, P.E. **7607 80TH AVE NE MARYSVILLE, WA 98270** 206-851-1106


DRAWN BY: CHK. BY:



JURISDICTIONAL APPROVAL:

DRAWING TITLE:

SFP DETAILS

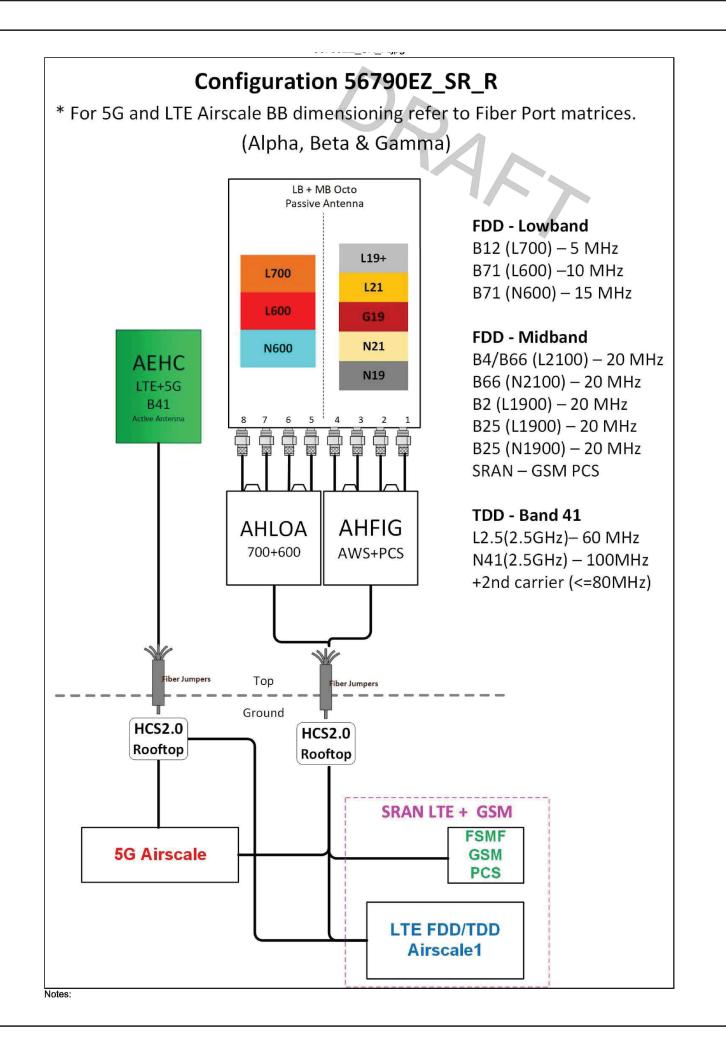

PROJECT INFORMATION:

WELLER KING/FUJISADA CONDOS SE03494E

510 6TH AVE S SEATTLE, WA 98104

ISSUED FOR:=

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<u></u>	4/8/2022	RELOCATED ANTENNAS, REVISED PER SITE WALK	BJT

PLANS PREPARED BY:=

B. J. THOMAS, P.E. 7607 80TH AVE NE MARYSVILLE, WA 98270 206-851-1106

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JW AA 14	DI:	۰

:-----СНК. ВҮ:--

__LICENSURE:=

5/31/2022 5/31/2022

JURISDICTIONAL APPROVAL:

DRAWING TITLE:

RF DETAILS

DRAWING NUMBER:

RF-2

PURCELL "HPL3" BATTERY CABINET

MANUFACTURER: PURCELL


HEIGHT: 60.4" DEPTH: 31.6" WIDTH: 30"


MAX WEIGHT: 2206 lbs


OPTIONAL: AIR CONDITIONER, AC POWER COMPARTMENT, AND REAR PANEL.

NOTE:

WIRES RUN THROUGH PROVIDED
KNOCKOUT FOLLOW PROPER INSTALLATION
OF GASKET BEFORE MATING THE 2

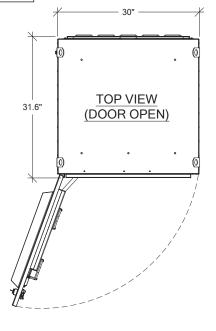

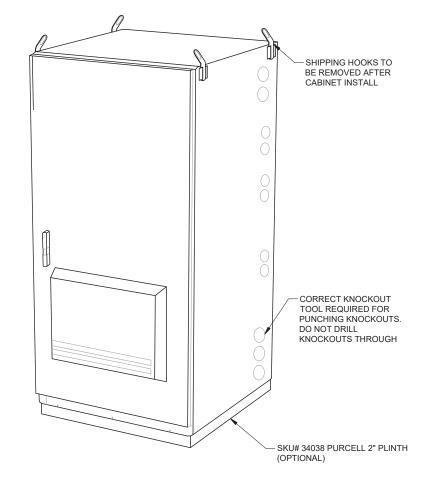

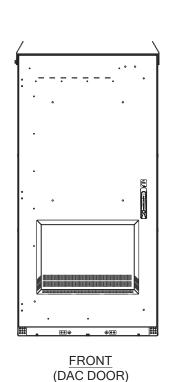



PROPOSED FINAL BATTERY CONFIGURATION TO CONSIST OF (16) LEAD ACID BATTERIES. 2018 IFC/SFC COMPLIANCE: EACH BATTERY IS RATED AT 2.28 kWh (12Vx190AH/1000) FOR A TOTAL OF 36.48kWh. AS THIS DOES NOT


EXCEED THE 70kWh THRESHOLD LISTED IN TABLE 1206.2 OF THE 2018

INTERNATIONAL FIRE CODE/SEATTLE FIRE CODE, COMPLIANCE WITH 2018 IFC/SFC SECTIONS 1206.2.1 THROUGH 1206.2.12.6 IS NOT REQUIRED.

BATTERY COMPLIANCE NOTE:

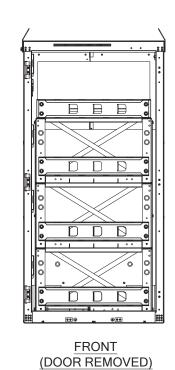

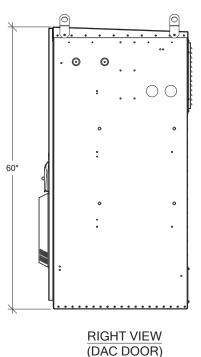

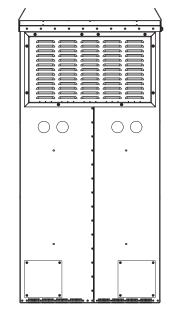

REAR VIEW

2 PURCELL "HPL3" BATTERY CABINET DETAILS
A-3 SCALE: NTS

BTS EQUIPMENT DETAILS

__JURISDICTIONAL APPROVAL: ___

T - - Mobile-

WELLER KING/FUJISADA

CONDOS

SE03494E

510 6TH AVE S SEATTLE, WA 98104

BUILDING PERMIT

UPDATED STRUCTURAL SHEETS ADDED

UPDATED STRUCTURAL SHEETS ADDED

REVISED PER OWNER

REVISED STRUCTURAL

MINOR REV

4/20/2022 REVISED PER REDLINES

4/8/2022 RELOCATED ANTENNAS, REVISED PER SITE WALK

B. J. THOMAS, P.E. 7607 80TH AVE NE MARYSVILLE, WA 98270 206-851-1106

—DRAWN BY:————CHK. BY:—

4/27/2022 | MINOR REV

PLANS PREPARED BY:

BJT

BJT

BJT

BJT

BJT

PROJECT INFORMATION:

ISSUED FOR:=

REVISION HISTORY:

5/31/2022

5/29/2022

5/17/2022

5/9/2022

4/28/2022


LICENSURE:

5/25/2022 MINOR REV

—DRAWING NUMBER:

DRAWING TITLE:

A-3

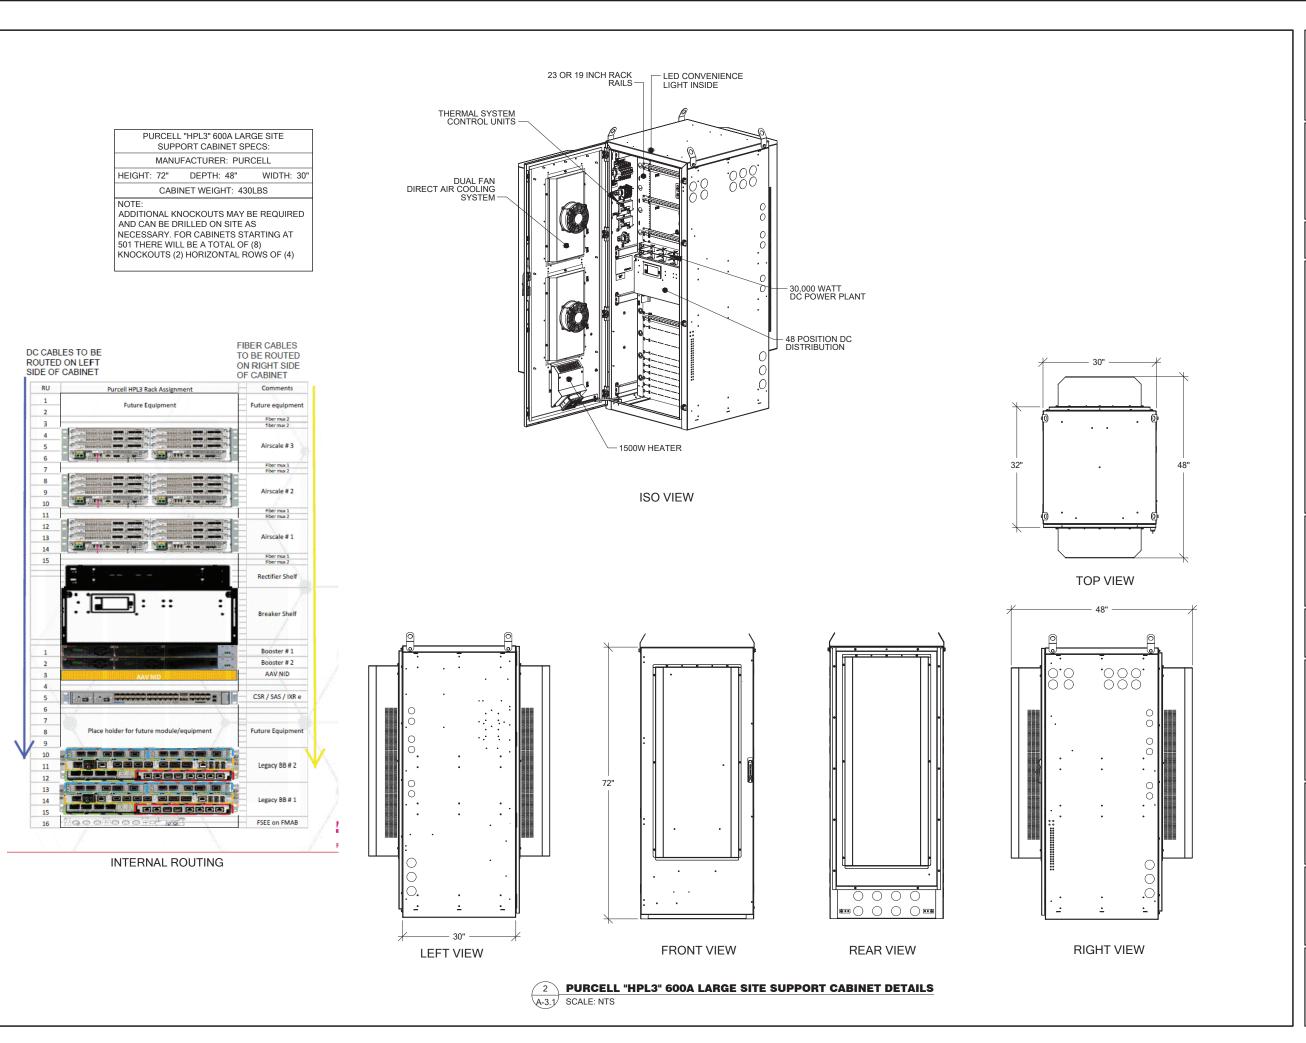

PROJECT INFORMATION:

WELLER KING/FUJISADA CONDOS SE03494E

510 6TH AVE S SEATTLE, WA 98104

ISSUED FOR:=

BUILDING PERMIT

=REVISION HISTORY:				
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PLANS PREPARED BY:

B. J. THOMAS, P.E. 7607 80TH AVE NE MARYSVILLE, WA 98270 206-851-1106

JL BJ

LICENSURE:




JURISDICTIONAL APPROVAL:

DRAWING TITLE:

BTS EQUIPMENT DETAILS

DRAWING NUMBER:

A-3.1

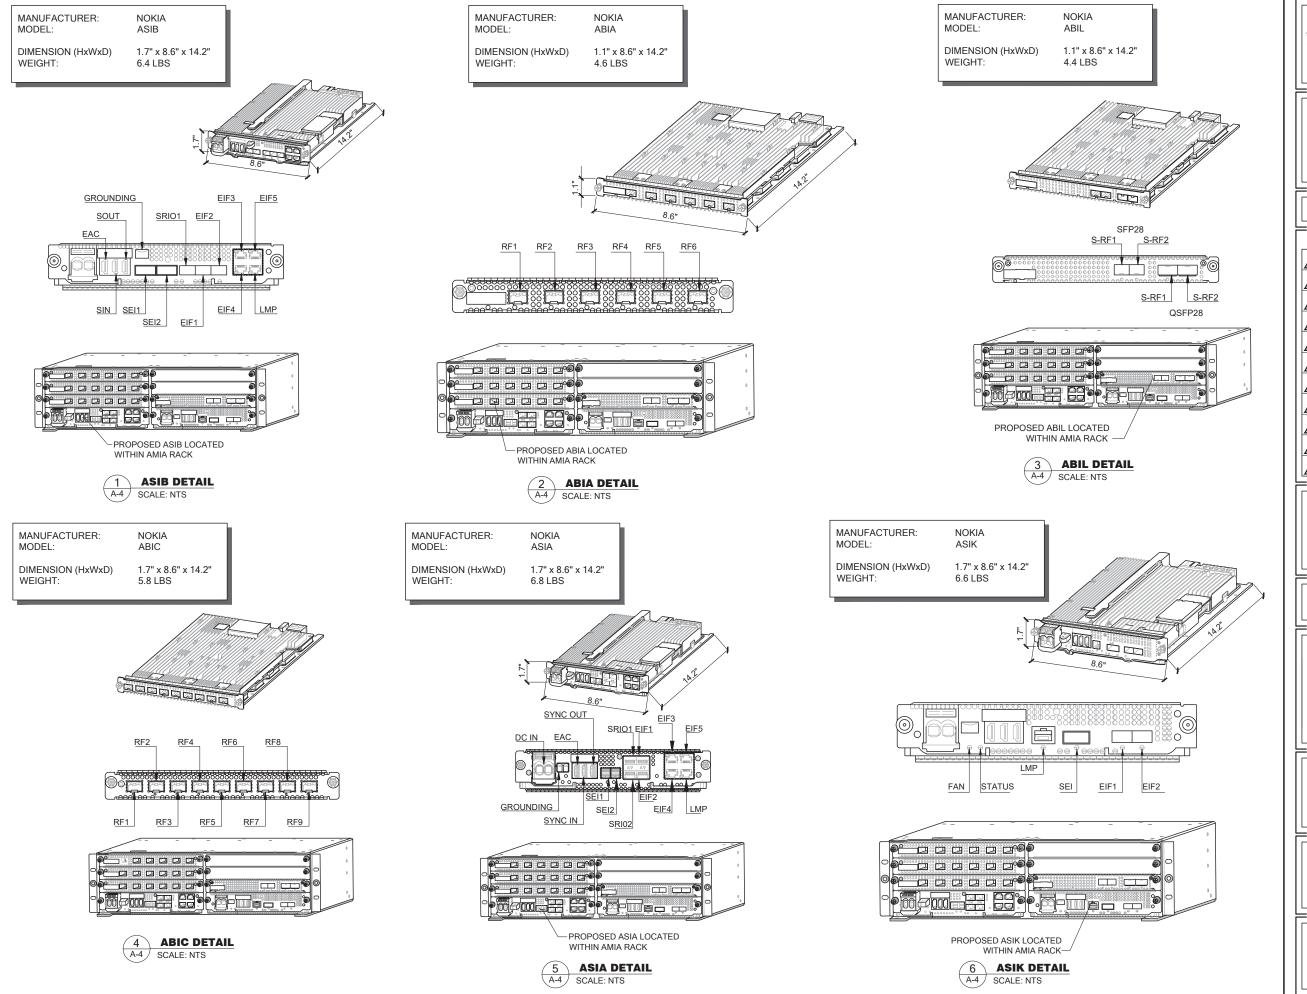

PROJECT INFORMATION:

WELLER KING/FUJISADA CONDOS SE03494E

510 6TH AVE S SEATTLE, WA 98104

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PLANS PREPARED BY:

B. J. THOMAS, P.E. 7607 80TH AVE NE MARYSVILLE, WA 98270 206-851-1106

DRAWN BY: CHK. BY:

BJ

LICENSURE:




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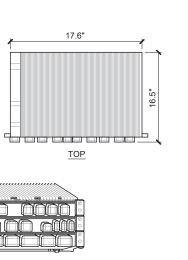
DRAWING TITLE:

GENERAL DETAILS

DRAWING NUMBER:

A-4



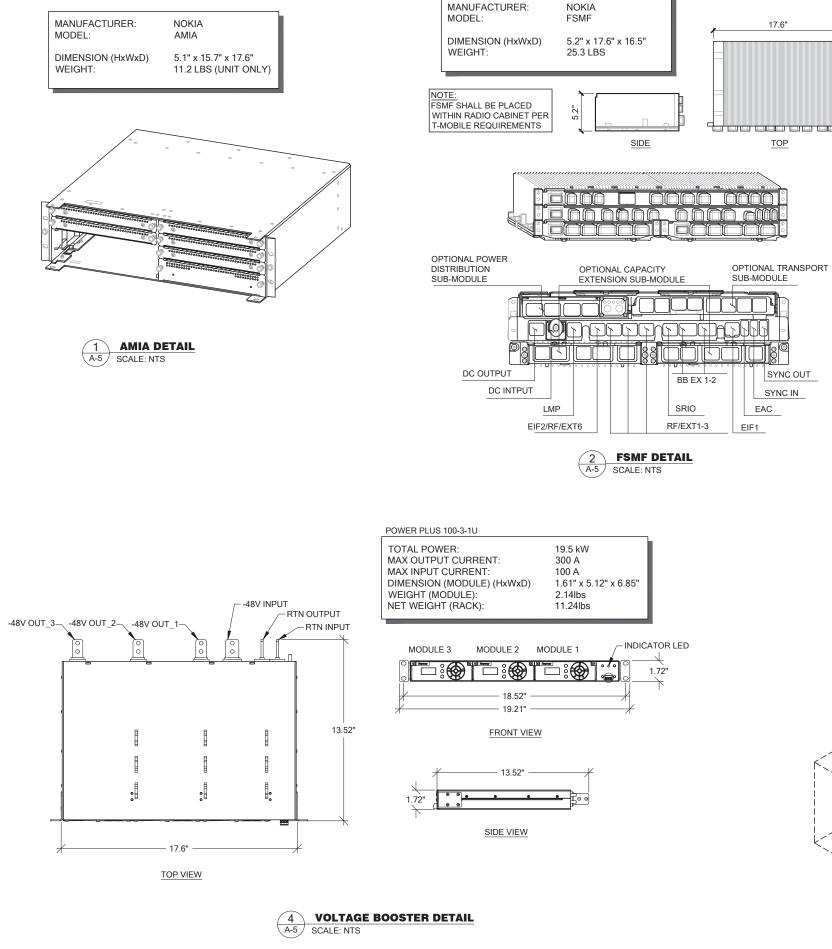

NOKIA

17.25" x 10.0" x 1.75"

IXR-e

MANUFACTURER:


DIMENSION (HxWxD)

MODEL:

WEIGHT:

IXR-e DETAIL SCALE: NTS

-PROPOSED RRUS TO BE MOUNTED VERTICALLY ONLY -MOUNTING PIPE NOT SHOWN FOR CLARITY

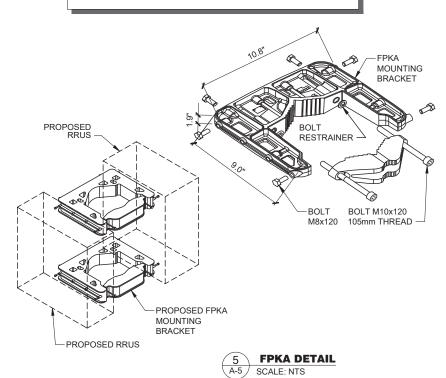

T - - Mobile-

PROJECT INFORMATION:

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PLANS PREPARED BY:

B. J. THOMAS, P.E. **7607 80TH AVE NE MARYSVILLE, WA 98270** 206-851-1106

4/8/2022 RELOCATED ANTENNAS, REVISED PER SITE WALK

DRAWN BY: CHK. BY:

BJ

LICENSURE:



=JURISDICTIONAL APPROVAL: ==


DRAWING TITLE:

GENERAL DETAILS

RADIO MODULE FOR 600/700MHz RRH

MANUFACTURER: NOKIA MODEL: AHLOA


NET WEIGHT: 83.78 LBS 22.05" x 12.13" x 7.44" DIMENSION (LxWxD)

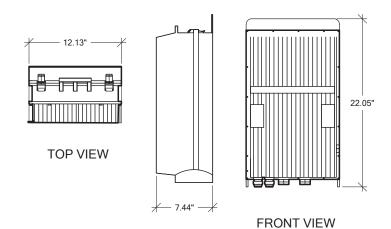

1 AHLOA DETAIL A-6 SCALE: NTS

SIDE VIEW

MANUFACTURER: NOKIA AHFIG MODEL: WEIGHT: 70.5 LBS 28.74" x 12.87" x 5.59" DIMENSION (LxWxD) w/ COVER

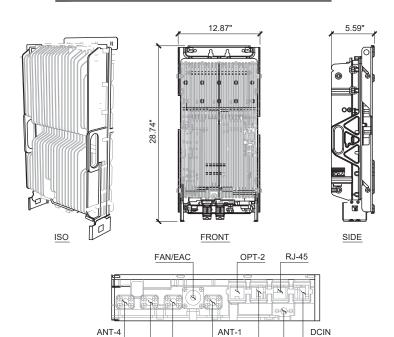

4 AHFIG DETAIL A-6 SCALE: NTS


OPT-1

GND

ANT-2

FIBER & POWER JUNCTION BOX W/ OVP


MANUFACTURER: COMMSCOPE MODEL: FE-16148-OVP-RT12 16" x 14" x 8" DIMENSION (HxWxD) WEIGHT: 23.5lbs

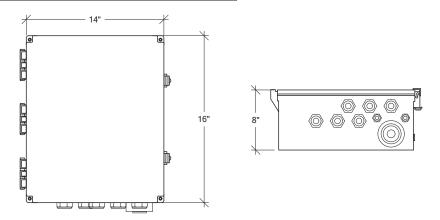




General Specifications

Cable Type	HFT410-4SNOK2-xx	HFT410-4SNOK3-xx (for FASB)
Brand	HELIAX® FiberFeed®	HELIAX® FiberFeed®
Total Fiber Quantity	4	4
Fiber Type	Bend insensitive single mode fiber (G.657.A2)	Bend insensitive single mode fiber (G.657.A2)
Jacket Color	Black	Black
Dimensions		
Cable Weight	456.1 kg/km 306.5 lb/kft	456.1 kg/km 306.5 lb/kff
Breakout Length Fiber, end 1	815 mm 32 in	1560 mm 61 in
Breakout Length Power, end 1	895 mm 35 in	457 mm 18 in
Breakout Length Fiber, end 2	600 mm 24 in	600 mm 24 in
Diameter Over Jacket	1831 mm 0.72 in	1831 mm 0.72 in
Physical Specifications		
Minimum Bend Radius, loaded	365.8 mm 14.4 in	365.8 mm 14.4 in
Minimum Bend Radius, unloaded	221.0 mm 8.7 in	221.0 mm 8.7 in
Tensile Load, long term, maximum	801 N 180 lbf	801 N 180 lbf
Tensile Load, short term, maximum	2669 N 600 lbf	2669 N 600 lbf

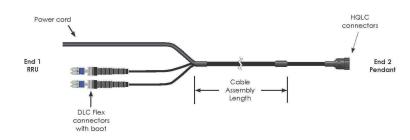



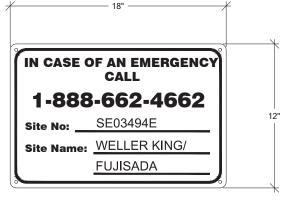

3 SITE SIG A-6 SCALE: NTS SITE SIGNAGE DETAIL

HELIAX FiberFeed Hybrid Jumpers

FiberFeed hybrid jumpers are constructed specifically for the conditions of the last few feet to the RRUs.

Features

- Smallest cable diameter for high flexibility
- Corrugated aluminum shield resists bird/animal damaç Exact fit to Pendant and RRU

Specifications

Hybrid Jumpers					
10 AVVG power conductor 4 Single mode fibers	rwire				
	r wire 4	4	35	32	24

Hybrid Jumpers for Nokia Radios

Ordering Information

Hybrid Jumpers for Nokia Radios	6	HFT410-4SNOK2-6
End 1: 4 fibers terminated DIC for Nokia RRUs with flush out power cord (red/black conductors).	10	HFT410-4\$NOK2-10
End 2: 4 fibers terminated LC and 4 X 10 AVVG	15	HFT410-4\$NOK2-15
conductors terminated at hybrid trunk connector (HQLC)	20	HFT4104\$NOK2-20
	25	HFT410-4SNOK2-25
	30	HFT4104\$NOK2-30
	40	HFT4104\$NOK2-40
	50	HFT4104\$NOK2-50
	60	HFT4104\$NOK2-60
	70	HFT4104SNOK2-70
	80	HFT410-4\$NOK2-80
	90	HFT4104\$NOK2-90
	100	HETATOASNOK2-10

Note: Longer lengths are available; contact your CommScope sales representative for details



T - - Mobile-

PROJECT INFORMATION:

WELLER KING/FUJISADA CONDOS SE03494E

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16	5/24/2022	MINOR REV	BJT
15	5/18/2022	MINOR REV	BJT
14	5/17/2022	REVISED PER OWNER COMMENTS	BJT
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12	4/28/2022	MINOR REV	BJT
11	4/27/2022	MINOR REV	BJT
10	4/20/2022	REVISED PER REDLINES	BJT
9	4/8/2022	RELOCATED ANTENNAS, REVISED PER SITE WALK	BJT
-DIA	NE DDEE	ARED BY:	

==PLANS PREPARED BY:=

B. J. THOMAS, P.E. **7607 80TH AVE NE** MARYSVILLE, WA 98270 206-851-1106

AWN	DV	CHK	DV.

JL	ВЈ
----	----


LICENSURE:



__JURISDICTIONAL APPROVAL: __

DRAWING TITLE:

GENERAL DETAILS

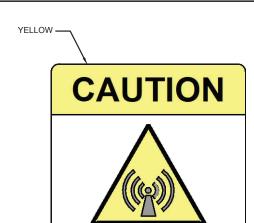

Beyond this pointyou are entering a controlled area where RF Emissions may exceed the FCC Occupational Exposure Limits

Obey all posted signs and site guidelines for working in an RF environment

RF CAUTION SIGNAGE DETAIL


NOTES:

- 1. 8" X 12" ALUMINUM.
- 2. POSTED AT EACH ANTENNA ARRAY ON ROOFTOP SITE.

RefFCC 47CFR 1.1307(b)

3. BUILDING OWNER MAY HAVE RESTRICTIONS ON WHERE SIGNS

SCALE: NTS

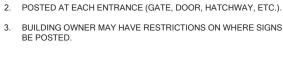

NOTES:

1. 8" X 12" ALUMINUM.

BLUE -



NOTE:



RF NOTICE SIGNAGE DETAIL

NOTICE

Beyond this point you are

Emissions may exceed the FCC

General Population Exposure Limits


Follow all posted signs and site guidelines

entering an area where RF


for working in an RF environment

SCALE: NTS


RefFCC 47CFR 1.1307(b)

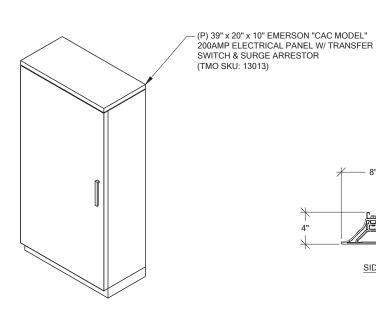

MANUFACTURER:	VERTIV
MODEL:	EMERSON CAC MODEL
DIMENSIONS:	39" x 20" x 10"
WEIGHT:	75LBS

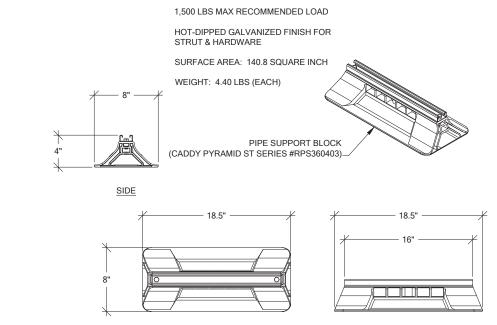


PLAN

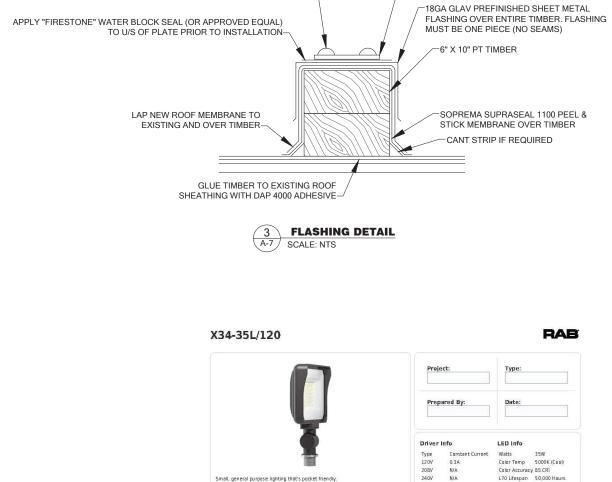

APPLY "FIRESTONE" ULTRAPLY TPO GENERAL PURPOSE SEALANT (OR APPROVED EQUAL)

TO LAG SCREW HEADS-

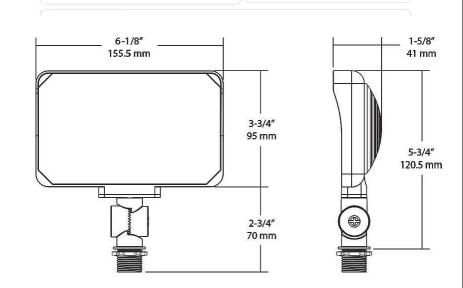

BASE PLATE (TYP)





FRONT

LED TECH LIGHT DETAIL SCALE: NTS

T - - Mobile-

PROJECT INFORMATION:

WELLER KING/FUJISADA CONDOS SE03494E

510 6TH AVE S SEATTLE, WA 98104

=ISSUED FOR:=

BUILDING PERMIT

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PLANS PREPARED BY:

RAB

3,501

B. J. THOMAS, P.E. **7607 80TH AVE NE MARYSVILLE, WA 98270** 206-851-1106

DRAWN BY: CHK. BY: BJ

=LICENSURE:=

=JURISDICTIONAL APPROVAL: ===

=DRAWING TITLE:===

GENERAL DETAILS





MASON INDUSTRIES, Inc. 350 Rabro Drive 2101 W. Crescent Ave., Sulte [
4auppauge, NY 11788 Anaheim, CA 92801 714/535-2727 714/535-5738

ALL DIRECTIONAL CAPTIVE MOBILE, MARINE, WALL HUNG and OVERSEAS APPLICATIONS

DATA SHEET DS-400-8.3A

OSHPD OPA-0201

BRD

880 1550 1800 3150 399 703 816 1429 HORIZONTAL

To use approved OSHPD rated load curves: 1) Calculate Vertical and Horizontal Forces on mounting including translations and overturning moments: 2) Plot Horizontal Load vs Vertical Load. The point must fall within the area below the CSHPD curve.

Specification

Captive Neoprene elements shall be arranged in opposition within a steel or ductile iron housing to provide positive mechanical restraint in all directions. Neoprene elements shall prevent metal to metal contact during normal operation. Bonded assemblies without mechanical interlocks are not acceptable. Neoprene elements shall be of bridge bearing quality as tabulated.

All mountings shall have minimum 1.0


All mountings shall have minimum 1.0 horizontal Gratings and anchorage preapproval "OPA" numbers from the Office of Statewide Health Planning and Development (OSHPD) in the state of California prior to 2010, attesting to the maximum horizontal and vertical load ratings. All mountings shall have botts for rigid attachment to the equipment and adequate base botting provision. Mountings shall have a minimum static deflection of 0.2" (5 mm).

In seismic zones, submittals shall include calculations showing that the intersection of the horizontal and vertical seismic loads fall below the OSHPD approved curves. Anchorages must be designed to meet the applicable building codes. All calculations must be signed by a professional engineer. Mountings shall be type BR as manufactured by Mason Industries, Inc.

5000 2268

BRB

BRA

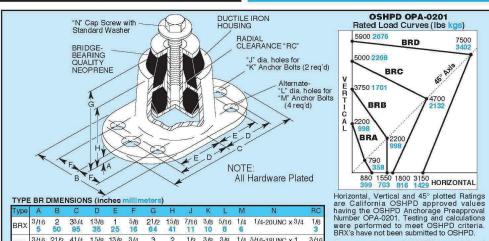



TYPE BR RATIN	G	
---------------	---	--

ITEL	BRRAII	IVGO										
Туре	Size (Color Mark)	Duro- meter	COM Ra Capa (lbs)	ted acity	Rated Defl (in) (mm)	Rat Capa	acity	ON Rated Defl (in)(mm)	Ra Cap	acity	AR Rated Defl (in)(mm)	Maximum Horizontal Static G Rating*
	X-Green X-Red X-White	40 50 60	30 45 70	14 20 32	0.12	30 45 70	14 20 32	0.12	20 35 45	9 16 20	0.08	12.0 8.0 6.0
	A-Green A-Red A-White A-Yellow	40 50 60 70	85 125 205 290	39 57 93 132	0.2 5	85 125 205 290	39 57 95 132	0.18	20 30 50 70	9 14 23 32	0.13	10.4 7.0 4.3 3.0
BR-	B-Red B-White B-Yellow	50 60 70	450 740 1040	204 336 472	0.2 5	500 750 1050	227 340 476	0.18	100 170 240	45 77 109	0.15	3.4 2.1 1.5
	C-Red C-White C-Yellow	50 60 70	650 1100 1540	295 499 699	0.3	750 1150 1610	340 522 730	0.25		172 227 318	0.50 13	2.8 1.6 1.2
	D-White D-Yellow	60 70	2390 3150		0.3	2450 3430		0.25		340 476	0.50 13	1.3 1.0

All Rated Capacities are based on proper neoprene loadings without metal to metal contact. Seismic Max. G Ratings are based on metal failure under static seismic loadings as defined in the building codes.

*Horizontal G Ratings are for quick reference only- Use OSHPD Rated Load Curves.

BRIDGE-BEARING NEOPRENE SPECIFICATIONS

	(a) Duro- meter	(min)	(b) Elongat. at Break (min)	OVEN Hard- ness	c) AGING(7 Tensile	at Break	(d)	212°F
í	50±5 60±5 70±5	2000 psi 2250 psi 2250 psi 2250 psi 4 D-676 (b	400% 350% 300%	+15% +15% +15%	±15% ±15% ±15% ±15%	-40% -40% -40%	No Cracks No Cracks No Cracks No Cracks TM D-1149 (e	35%(max) 35%(max) 35%(max)












NEOPRENE CABINET MOUNT DETAIL SCALE: NTS

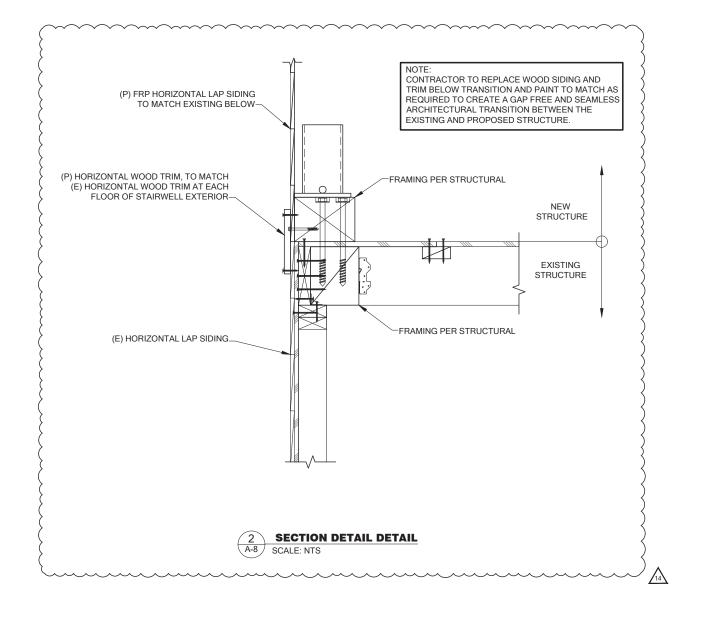

T - - Mobile-

=PROJECT INFORMATION:=

REVISION HISTORY:

WELLER KING/FUJISADA CONDOS SE03494E

510 6TH AVE S SEATTLE, WA 98104

=ISSUED FOR:=

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PLANS PREPARED BY:

B. J. THOMAS, P.E. **7607 80TH AVE NE MARYSVILLE, WA 98270** 206-851-1106

=DRAWN	I RV:	

_____CHK. BY:__

BJ


=LICENSURE:=



=JURISDICTIONAL APPROVAL: ==

=DRAWING TITLE:====

GENERAL DETAILS

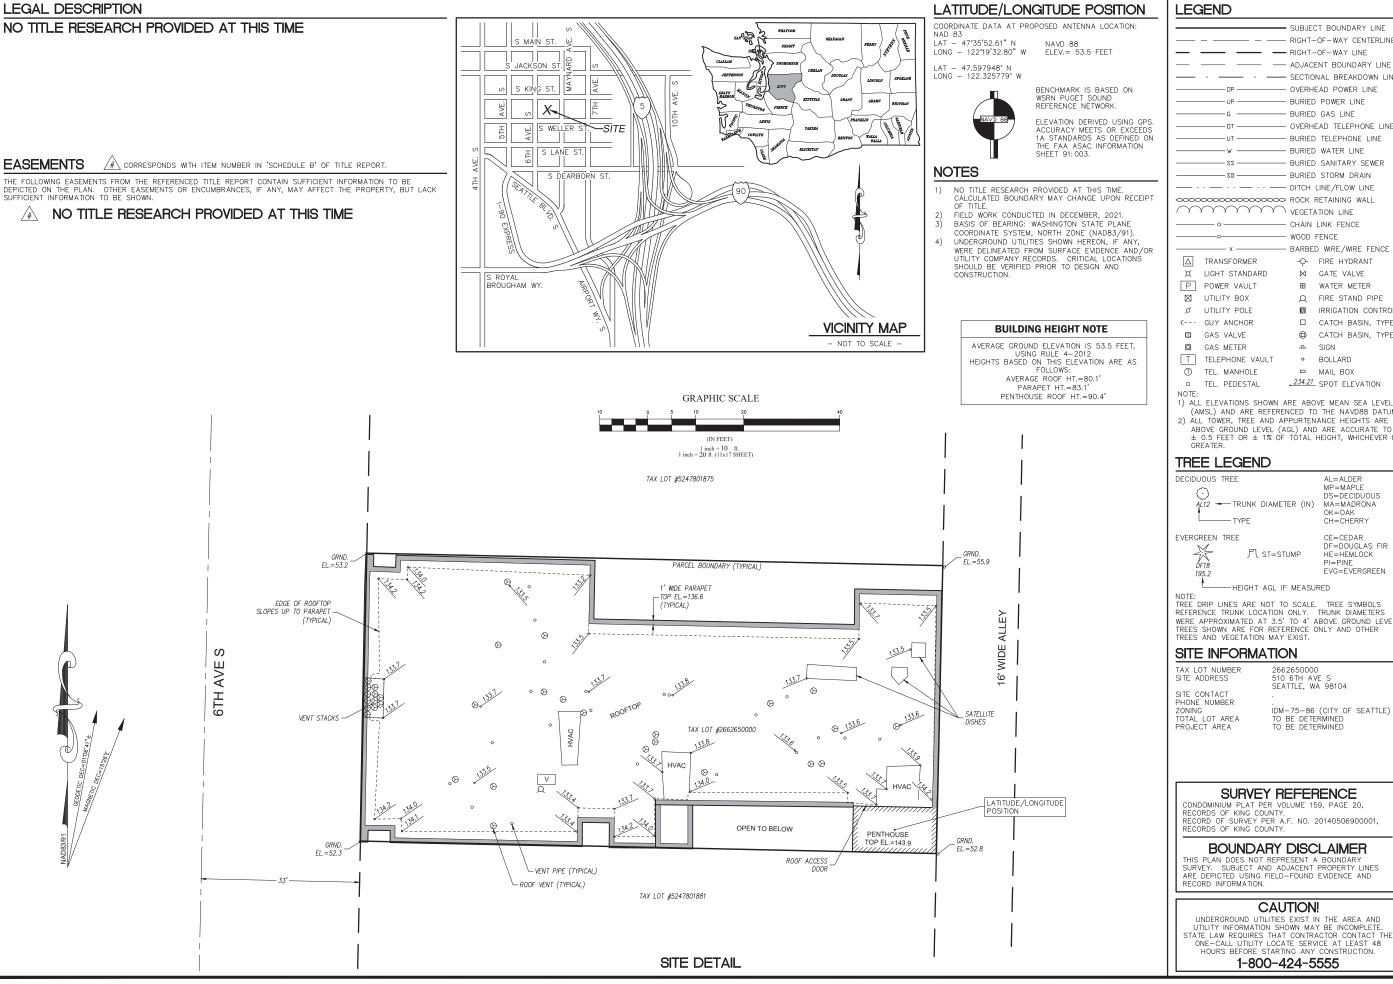

LATITUDE/LONGITUDE POSITION

LEGEND

LEGEND	
	- SUBJECT BOUNDARY LINE
	- RIGHT-OF-WAY CENTERLINE
	- RIGHT-OF-WAY LINE
	- ADJACENT BOUNDARY LINE
l — · — · —	- SECTIONAL BREAKDOWN LINE
OP	- OVERHEAD POWER LINE
UP	- BURIED POWER LINE
G	- BURIED GAS LINE
от	- OVERHEAD TELEPHONE LINE
UT	- BURIED TELEPHONE LINE
	- BURIED WATER LINE
	- BURIED SANITARY SEWER
sd	- BURIED STORM DRAIN
	- DITCH LINE/FLOW LINE
~~~~~~~~~~	
	VEGETATION LINE
	- CHAIN LINK FENCE
	- WOOD FENCE
x	- BARBED WIRE/WIRE FENCE
△ TRANSFORMER	-Q- FIRE HYDRANT
X LIGHT STANDARD	M GATE VALVE
P POWER VAULT	■ WATER METER
☑ UTILITY BOX	Q FIRE STAND PIPE
Ø UTILITY POLE	M IRRIGATION CONTROL
€ GUY ANCHOR	☐ CATCH BASIN, TYPE I
ICI GAS VALVE	CATCH BASIN, TYPE II
☐ GAS METER	Ф SIGN
T TELEPHONE VAULT	
TEL. MANHOLE	□ MAIL BOX
TEL. PEDESTAL	234.21 SPOT ELEVATION

(AMSL) AND ARE REFERENCED TO THE NAVD88 DATUM.

2) ALL TOWER, TREE AND APPURTENANCE HEIGHTS ARE ABOVE GROUND LEVEL (AGL) AND ARE ACCURATE TO ± 0.5 FEET OR ± 1% OF TOTAL HEIGHT, WHICHEVER IS

#### TREE LEGEND



NOTE:
TREE DRIP LINES ARE NOT TO SCALE. TREE SYMBOLS
REFERENCE TRUNK LOCATION ONLY. TRUNK DIAMETERS
WERE APPROXIMATED AT 3.5' TO 4' ABOVE GROUND LEVEL.
TREES SHOWN ARE FOR REFERENCE ONLY AND OTHER
TREES AND VEGETATION MAY EXIST.

HEIGHT AGL IF MEASURED

#### SITE INFORMATION

TAX LOT NUMBER 2662650000 510 6TH AVE S SEATTLE, WA 98104 SITE ADDRESS SITE CONTACT

PHONE NUMBER

ZONING TOTAL LOT AREA PROJECT AREA

. IDM-75-86 (CITY OF SEATTLE) TO BE DETERMINED TO BE DETERMINED

#### SURVEY REFERENCE

CONDOMINIUM PLAT PER VOLUME 159, PAGE 20, RECORDS OF KING COUNTY. RECORD OF SURVEY PER A.F. NO. 20140506900001,

### **BOUNDARY DISCLAIMER**

THIS PLAN DOES NOT REPRESENT A BOUNDARY SURVEY. SUBJECT AND ADJACENT PROPERTY LINES ARE DEPICTED USING FIELD—FOUND EVIDENCE AND RECORD INFORMATION.

UNDERGROUND UTILITIES EXIST IN THE AREA AND UTILITY INFORMATION SHOWN MAY BE INCOMPLETE.
TATE LAW REQUIRES THAT CONTRACTOR CONTACT TO
ONE-CALL UTILITY LOCATE SERVICE AT LEAST 48
HOURS BEFORE STARTING ANY CONSTRUCTION.

1-800-424-5555

### T - Mobile

Technology Associates



DUNCANSON

145 SW 155th Street. Suite 102 Seattle Washington 98166 Phone 206.244.4141 Fax 206.244.4455

SITE

### SE03949E **WELLER** KING/FUJISADA

510 6TH AVE S SEATTLE, WA 98104 KING COUNTY

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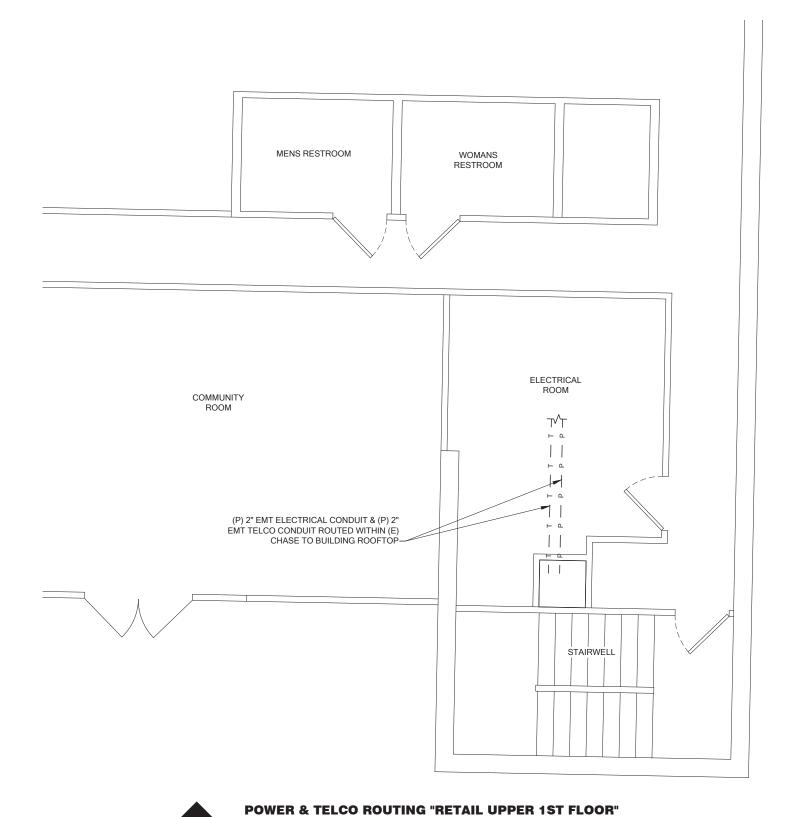
LD. CREW: PN/A FLD. BOOK: 581/5 DRAWN BY: LAC 01808.1815 JOB #: DATE: 12/03/2

RI	EVISIONS	
DATE	DESCRIPTION	BY



SHEET TITLE EXISTING SITE SURVEY SEC 5, TWP 24 N, RNG 4 E, WM

> SHEET NUMBER SV



22x34 SCALE: 3/8" = 1' 11x17 SCALE: 3/16" = 1'



PROJECT INFORMATION:

#### WELLER KING/FUJISADA CONDOS SE03494E

510 6TH AVE S SEATTLE, WA 98104

ISSUED FOR:

#### **BUILDING PERMIT**

=RFV	ISION H	ISTORY:	
NO.	DATE:	DESCRIPTION:	CHK. BY:
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10	4/20/2022	REVISED PER REDLINES	BJT
/9\	4/8/2022	RELOCATED ANTENNAS, REVISED PER SITE WALK	ВЈТ

PLANS PREPARED BY:

B. J. THOMAS, P.E. 7607 80TH AVE NE MARYSVILLE, WA 98270 206-851-1106

BJ

LICENSURE:



JURISDICTIONAL APPROVAL:

DRAWING TITLE:


### POWER & TELCO ROUTING

DRAWING NUMBER:

**E-1** 

#### **ELECTRICAL NOTES:**

- 1. ALL ELECTRICAL WORK SHALL BE COMPLETED IN ACCORDANCE WITH THE LATEST EDITION OF THE NATIONAL ELECTRICAL CODE AND ANY LOCAL, CITY, OR COUNTY CODES THAT MAY APPLY.
- 2. GROUNDING SHALL COMPLY WITH ARTICLE 250 OF THE NATIONAL ELECTRICAL CODE.
- 3. CONTRACTOR SHALL BE RESPONSIBLE FOR PERMITTING, FILINGS, INSPECTIONS, AND TESTING AS REQUIRED BY THE PERMITTING AUTHORITY AND T-MOBILE.
- 4. UNDERGROUND CONDUIT SHALL BE RIGID POLYVINYL CHLORIDE CONDUIT, SCHEDULE 40, TYPE 1, CONFORMING TO UL ARTICLE 651; MANUFACTURED BY WESTERN PLASTICS, CARLON, OR EQUAL. ALL BENDS SHALL BE 30" MINIMUM RADIUS.
- 5. CONTRACTOR SHALL CONTACT ALL UTILITIES FOR LOCATION OF UNDERGROUND SERVICES. SERVICE LOCATIONS TO BE CONFIRMED PRIOR TO CONSTRUCTION.
- 6. ALL EQUIPMENT, WIRING, AND MATERIALS MUST HAVE A UL LABEL.
- 7. CONDUIT USED INDOORS SHALL BE EMT. CONDUIT USED OUTDOORS SHALL BE RMC. COUPLINGS SHALL BE RIGID STEEL AND COMPRESSION TYPE FOR EMT (SET SCREW FITTINGS ARE NOT PERMITTED). RMC TO BE USED FOR ALL CONDUIT STUB-UPS.
- 8. WIRES AND CABLES SHALL BE CONTINUOUS FROM TERMINATION TO TERMINATION WITH NO SPLICES ALLOWED.
- 9. ALL JUNCTION AND OUTLET BOXES SHALL BE LABELED WITH KROY TAPE OR EQUAL. CONTRACTOR TO DESIGNATE ALL CIRCUIT NUMBERS CONTAINED IN EACH BOX.
- 10. THE DISTRIBUTION PANEL SHALL HAVE A TYPED LEGEND IDENTIFYING THE LOADS OF ALL CIRCUIT BREAKERS.
- 11. CONTRACTOR SHALL INSTALL CONDUIT SEALING COMPOUND (BLACKBURN DX DUCT SEAL OR EQUAL) AFTER WIRING IS

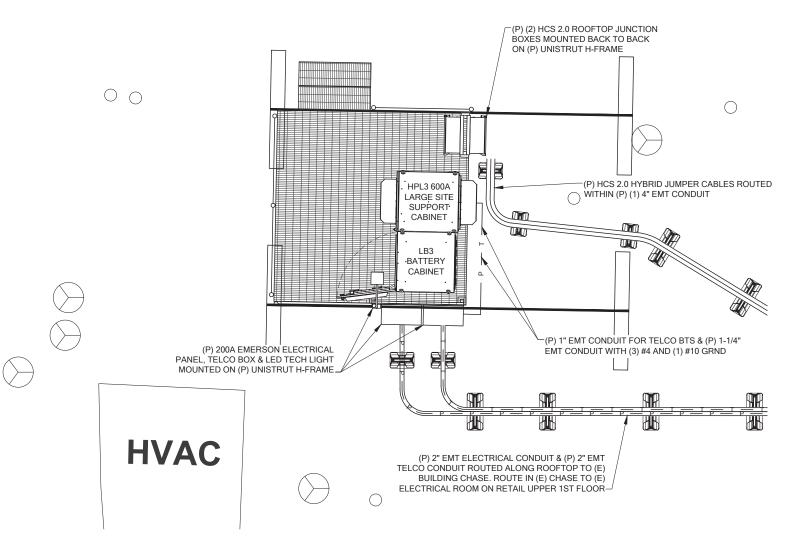



T - - Mobile-

==PROJECT INFORMATION:==

#### **WELLER KING/FUJISADA** CONDOS SE03494E

510 6TH AVE S SEATTLE, WA 98104

=ISSUED FOR:=

#### **BUILDING PERMIT**

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l	19	5/31/2022	UPDATED STRUCTURAL SHEETS ADDED	В
l	18	5/29/2022	UPDATED STRUCTURAL SHEETS ADDED	В
l	17	5/25/2022	MINOR REV	В
ı	$\overline{}$			Τ_

REVISED PER OWNER REVISED STRUCTURAL 5/9/2022 BJT BJT 4/28/2022 BJT 4/27/2022 MINOR REV REVISED PER REDLINES 4/20/2022

PLANS PREPARED BY:

B. J. THOMAS, P.E. **7607 80TH AVE NE MARYSVILLE, WA 98270** 206-851-1106

4/8/2022 RELOCATED ANTENNAS, REVISED PER SITE WALK

—DRAWN BY:————CHK. BY:—

LICENSURE:




=JURISDICTIONAL APPROVAL: ==

DRAWING TITLE:

**ELECTRICAL SITE PLAN** 

NEMA 3R - PANELBOARD FURNISHED BY T-MOBILE WIRELESS, INSTALLED BY CONTRACTOR.

SURFACE MOUNTING 65,000 AIC PANEL SCHEDULE										
NO. A LOCATION: ROOFTOP SERVING: T-MOBILE									20/208 VOLTS 1PHASE 3V MPS WITH 200 MAIN BREA	
CKT NO.	L	OAD DESCRIPTION	KVA	TRIP AMPS		<b>X</b> S	TRIP AMPS	KVA	LOAD DESCRIPTION	CKT NO.
1	TV	SS	-	30	~	_	20	.2	GFCI RECPT & LIGHT	2
3	TV	SS	-	"	$\overline{}$	<b>→</b>				4
5	HP	L3	24	200	·~	+~				6
7	HP	L3	"	"		<b>◆</b> ~				8
9	HP	L3	"	"	·~	+~				10
11	HP	L3	"	"	$\sim$	<b>◆</b> ~				12
13					_	+~				14
15					$\overline{}$	<b>~</b>				16
17						+~				18
19					$\overline{}$	<b>→</b>				20
21					`~\	+				22
23					$\sim$	<b>→</b>				24
REMA	REMARKS:						NNECT	ED LO	AD: 24.2 KVA 116.3 A	MPS
						DEN	//AND L	OAD:	24.2 KVA 116.3 A	MPS

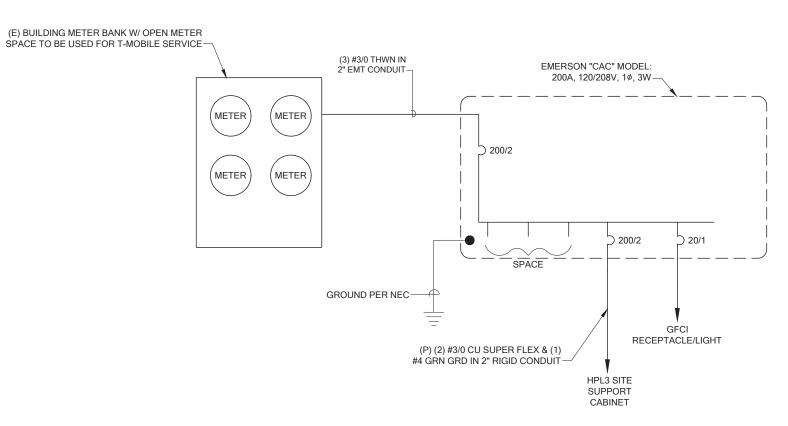

### **ELECTRICAL ONE LINE**

**T** - - Mobile-

PROJECT INFORMATION:

#### WELLER KING/FUJISADA CONDOS SE03494E

510 6TH AVE S SEATTLE, WA 98104

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PLANS PREPARED BY:

B. J. THOMAS, P.E. 7607 80TH AVE NE MARYSVILLE, WA 98270 206-851-1106

RAWN	BV.	•
JW AA 14	DI:	۰

JL

LICENSURE:




_JURISDICTIONAL APPROVAL:

DRAWING TITLE:

ELECTRICAL DETAILS

DRAWING NUMBER:


E-1.2

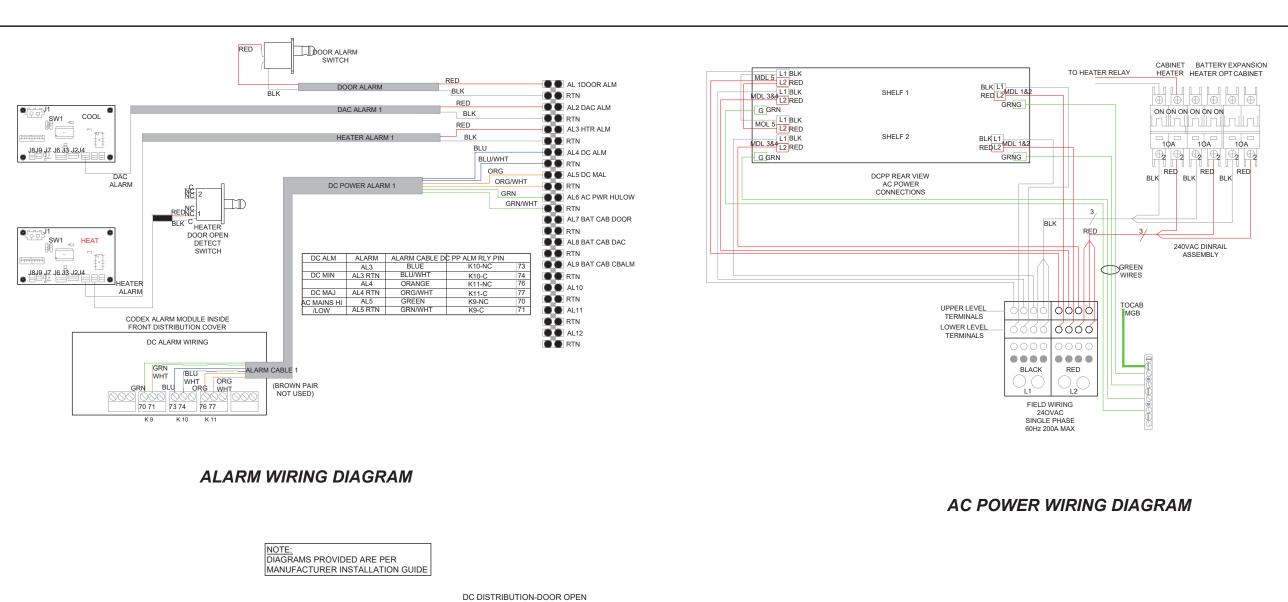

THERMAL SYSREM DAC AND HEATER

FUTURE USE

FUTURE USE

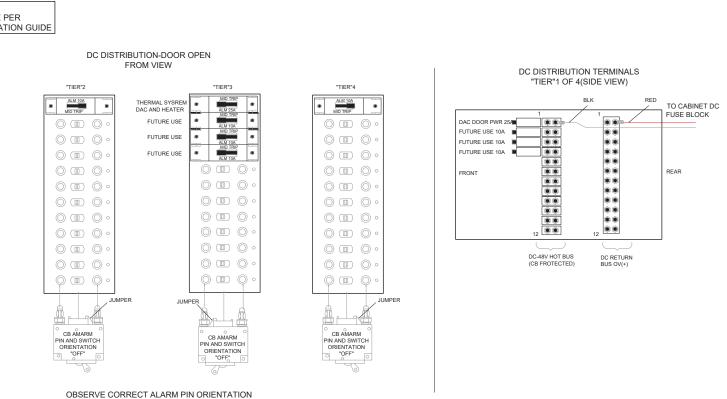

DC POWER WIRING DIAGRAM

T - Mobile-

PROJECT INFORMATION:

#### WELLER KING/FUJISADA CONDOS SE03494E

510 6TH AVE S SEATTLE, WA 98104

#### SSUED FOR:=

#### **BUILDING PERMIT**

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PLANS PREPARED BY:

B. J. THOMAS, P.E. 7607 80TH AVE NE MARYSVILLE, WA 98270 206-851-1106

4/8/2022 RELOCATED ANTENNAS, REVISED PER SITE WALK

DRAWN BY: CHK. BY:

JL BJ

=LICENSURE:=




__JURISDICTIONAL APPROVAL: __

DRAWING TITLE:

ELECTRICAL DIAGRAMS

DRAWING NUMBER:

E-1.3

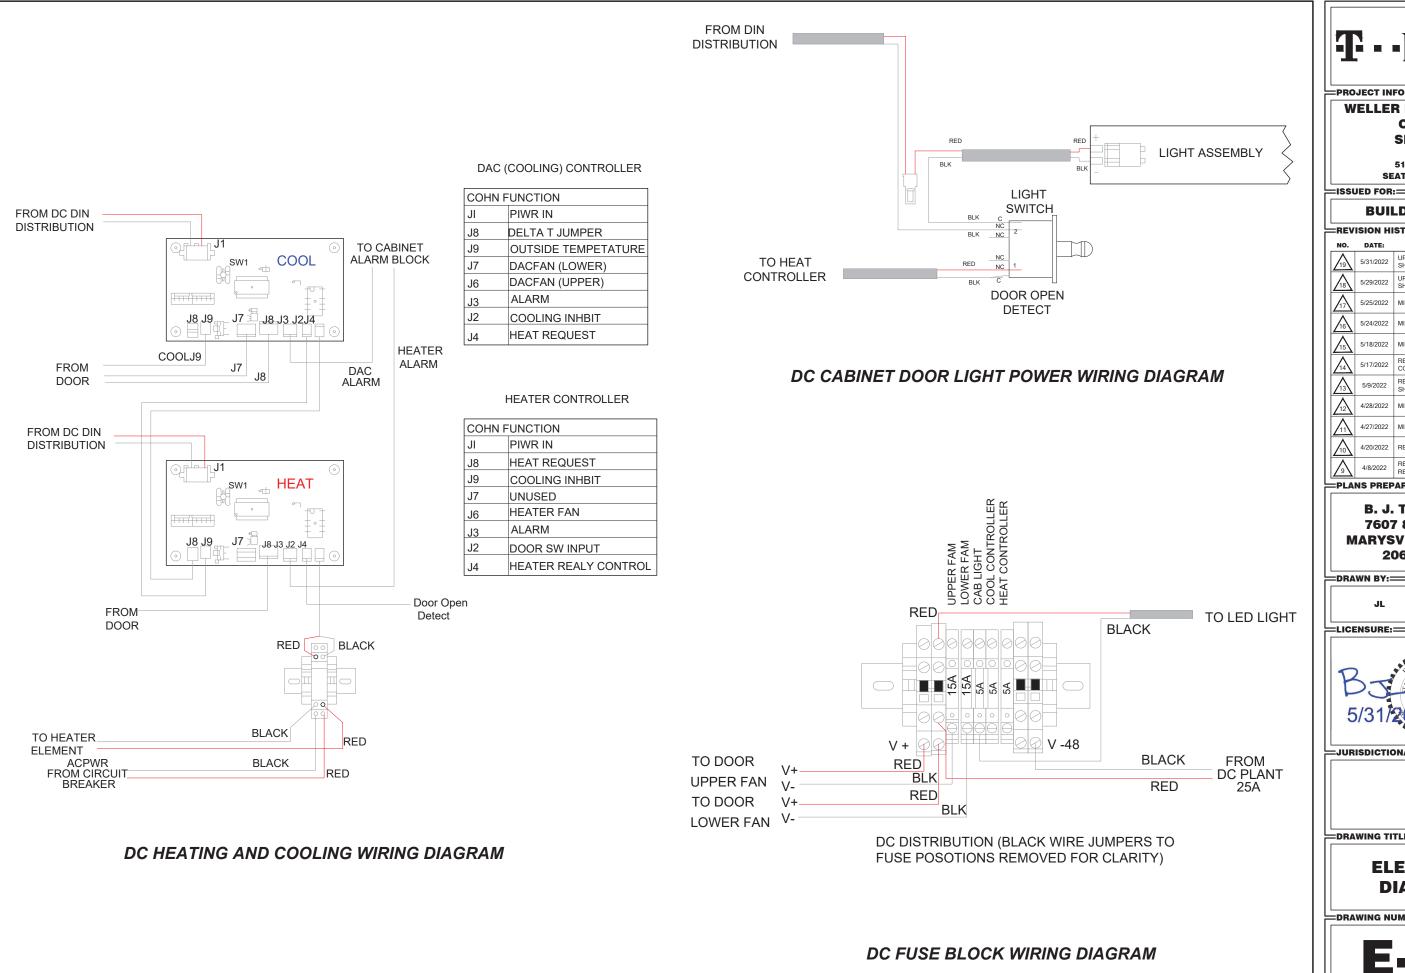

PROJECT INFORMATION:

#### **WELLER KING/FUJISADA** CONDOS SE03494E

510 6TH AVE S SEATTLE, WA 98104

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<u></u>	4/8/2022	RELOCATED ANTENNAS, REVISED PER SITE WALK	BJT		

#### PLANS PREPARED BY:

B. J. THOMAS, P.E. **7607 80TH AVE NE MARYSVILLE, WA 98270** 206-851-1106

DRAWN BY: CHK. BY:

LICENSURE:=



=JURISDICTIONAL APPROVAL: ==

DRAWING TITLE:

**ELECTRICAL DIAGRAMS** 

#### **SYMBOL LEGEND:**

T

MASTER GROUND BAR 1/4"x4"x24"

TT

ACCESSORY GROUND BAR 1/4"x4"x12" OR 1/4"x4"x20" COPPER

**EXPOSED WIRING** 

UNDERGROUND WIRING

CADWELD

MECHANICAL CONNECTION

5/8"x8' COPPER CLAD STEEL GROUND ROD


INSPECTION PORT

EXOTHERMIC (CADWELD) BELOW GROUND

GROUND

#### **GROUNDING NOTES:**

- GROUNDING SHALL COMPLY WITH LATEST EDITION OF THE NATIONAL ELECTRICAL CODE.
- 2. MINIMUM BENDING RADIUS FOR GROUND CONDUCTOR IS 8".
- 3. NO SPLICES PERMITTED IN GROUND CONDUCTORS.
- 4. ALL GROUNDING CONNECTORS TO BE CLEAN AND FREE OF PAINT AT THEIR MATING SURFACES AND INSTALLED PER MANUFACTURER'S RECOMMENDATIONS. USE PENETROX OR EQUIVALENT ANTIOXIDANT GREASE.
- 5. ALL GROUND BAR CONNECTIONS ARE TO BE 2 HOLE LUG COMPRESSION TYPE. STACKED CONNECTIONS ARE NOT ACCEPTABLE. BACK TO BACK CONNECTIONS ON OPPOSITE SIDES OF THE GROUND BAR WILL BE PERMITTED.
- 6. ENSURE ALL MECHANICAL CONNECTORS ARE TORQUED TO THE MANUFACTURER'S SPECIFIED VALUES.
- 7. MAXIMUM RESISTANCE OF THE COMPLETED GROUND SYSTEM SHALL NOT EXCEED A RESISTANCE OF 5 OHMS TO EARTH.
- 8. GROUND WIRES SHALL NOT BE INSTALLED THROUGH HOLES IN ANY METAL OBJECTS OR SUPPORTS; TO PRECLUDE ESTABLISHING A "CHOKE" POINT.
- 9. GROUND BARS SHALL NOT BE FIELD MODIFIED.
- 10. A CERTIFIED CONTRACTOR WILL MAKE ALL MEASUREMENTS REQUIRED TO TEST THE GROUNDING SYSTEM USING A MEGGER OR EQUIVALENT. THE ACCEPTABLE RESISTANCE MEASURED FOR THE GROUNDING SYSTEM WILL NOT EXCEED 5 OHMS RESISTANCE.
  THREE DISTANCES SHALL BE USED: 1 AT 100 FEET, 1 AT 70 FEET, AND 1 AT 35 FEET. THESE DISTANCES ARE SUBJECT TO A SITE BY SITE BASIS. T-MOBILE-WTS SHALL BE GIVEN 24 HOURS NOTICE. ALL COSTS ASSOCIATED WITH GROUND TESTING WILL BE AT THE

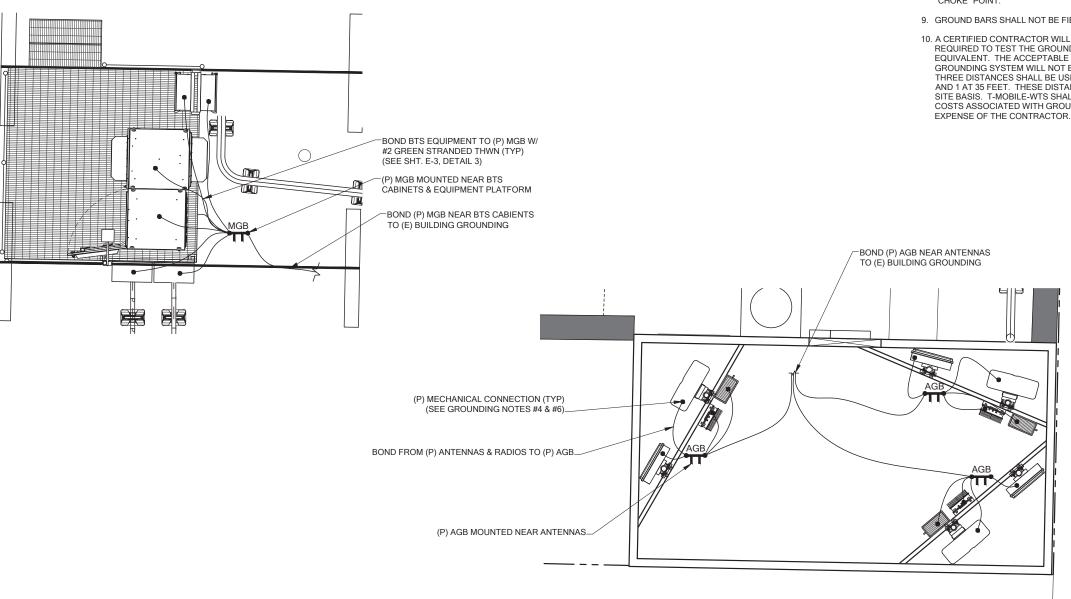

**ELECTRICAL GROUNDING PLAN** 

22x34 SCALE: 1/2" = 1' 11x17 SCALE: 1/4" = 1'

**T** - - Mobile-

=PROJECT INFORMATION:=

#### **WELLER KING/FUJISADA** CONDOS SE03494E

510 6TH AVE S SEATTLE, WA 98104

=ISSUED FOR:=

#### **BUILDING PERMIT**

=REVISION HISTORY:					
NO.	DATE:	DESCRIPTION:	BY:		
19	5/31/2022	UPDATED STRUCTURAL SHEETS ADDED	BJT		
18	5/29/2022	UPDATED STRUCTURAL SHEETS ADDED	BJT		
17	5/25/2022	MINOR REV	BJT		
16	5/24/2022	MINOR REV	BJT		
15	5/18/2022	MINOR REV	BJT		
14	5/17/2022	REVISED PER OWNER COMMENTS	BJT		
13	5/9/2022	REVISED STRUCTURAL SHEETS ADDED	BJT		
12	4/28/2022	MINOR REV	BJT		
11	4/27/2022	MINOR REV	BJT		
10	4/20/2022	REVISED PER REDLINES	BJT		
<u>_9</u>	4/8/2022	RELOCATED ANTENNAS, REVISED PER SITE WALK	BJT		

PLANS PREPARED BY:

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BJ


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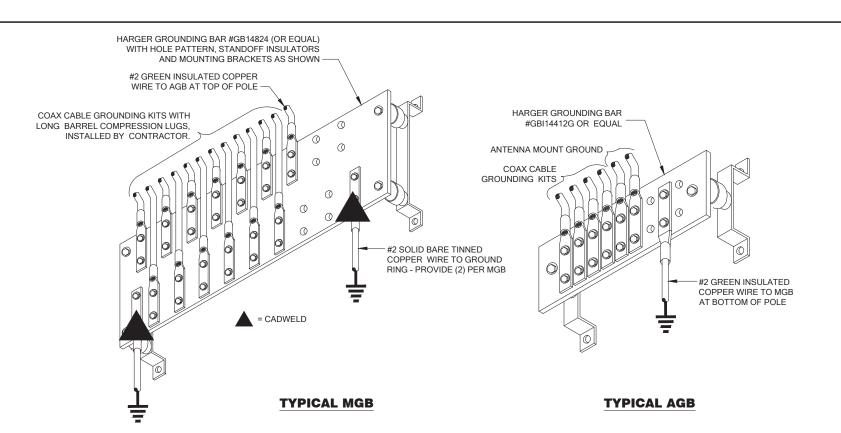
=JURISDICTIONAL APPROVAL: ===

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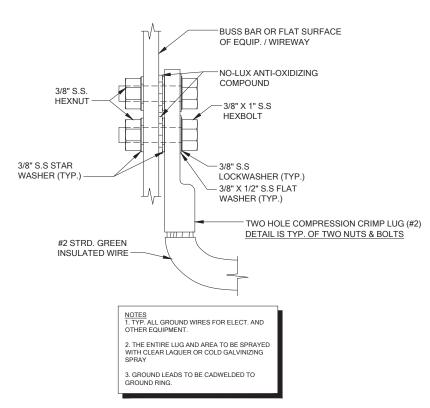
**ELECTRICAL GROUNDING PLAN** 



1 TYPICAL CADWELD CONNECTIONS B.T.S.



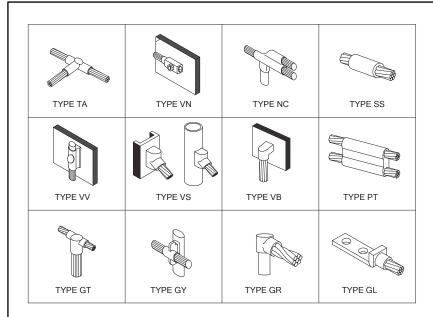



TYPICAL CABINET GROUNDING DETAIL

83 N.T.S.

T - - Mobile-

PROJECT INFORMATION:

#### WELLER KING/FUJISADA CONDOS SE03494E

510 6TH AVE S SEATTLE, WA 98104

ISSUED FOR:=

#### **BUILDING PERMIT**

EV	ICION HI	STORY-				
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DRAWN BY: CHK. BY:

JL BJ

LICENSURE:



__JURISDICTIONAL APPROVAL: ___

DRAWING TITLE:

ELECTRICAL GROUNDING DETAILS

DRAWING NUMBER:

**E-3** 

### STRUCTURAL NOTES

ALL MATERIALS, WORKMANSHIP, DESIGN, AND CONSTRUCTION SHALL CONFORM TO THE DRAWINGS. SPECIFICATIONS, AND THE INTERNATIONAL BUILDING CODE (IBC), 2018 EDITION, SPECIFICATIONS AND STANDARDS WHERE REFERENCED ON THE DRAWINGS ARE TO BE THE LATEST EDITION.

#### DESIGN LOADS

DEAD LOADS: ROOF 15 PSF 17 PSF FLOOR EXTERIOR WALL

RESIDENTIAL

(LIVE LOADS ARE REDUCED WHERE PERMISSIBLE PER IBC SECTION 1607.11).

EQUIVALENT LATERAL FORCE PROCEDURE PER ASCE 7-16 SECTION 12.8.

SITE CLASS (ASSUMED) SHORT PERIOD SPECTRAL RESPONSE ACCEL (S_S)
ONE SECOND SPECTRAL RESPONSE ACCEL (S₎
SHORT PERIOD DESIGN SPECTRAL RESPONSE ACCEL (S_{DS}) 1.413 0.493 0.942 ONE SECOND DESIGN SPECTRAL RESPONSE ACCEL (SDI) 0.594 RISK CATEGORY RISK CATEGORY
SEISMIC IMPORTANCE FACTOR (I_E)
SEISMIC DESIGN CATEGORY
BASIC SEISMIC FORCE-RESISTING-SYSTEM WOOD SHEAR WALLS RESPONSE MODIFICATION FACTOR, (R) REDUNDANCY FACTOR (n) SEISMIC RESPONSE COEFFICIENT (C_s)

W = TOTAL SEISMIC DEAD LOAD AS DEFINED PER ASCE 7-16 SECTION 12.7.2.

BASE SHEAR (V),  $V = C_S W = \frac{S_{DS}}{R/I} W$ 

BASIC WIND SPEED (3 SECOND GUST) 97 MPH **EXPOSURE** 

SEE PLANS FOR ADDITIONAL DESIGN LOADS.

#### DESIGN LOADS

EQUIPMENT PLATFORM DEAD LOAD: 5,000 LBS

SCREENWALL DEAD LOAD: 5,800 LBS (INCLUDE APPURTENANCES)

#### ROOFTOP SCREENWALL

#### WIND LOAD: 97 MPH EXPOSURE B

qz x (GCr) x Af = 37.3 PSF = 22.4 PSF (ASD) 19.62 PSF (Kz = 0.96, Kzt = 1.00, Kd = 0.85) RISK CATEGORY

#### SEISMIC LOAD: SEISMIC DESIGN CATEGORY D, SOIL TYPE Sd

 $\frac{0.4apSdslp}{Rp}$  [1+2z/h] Wp = 0.337 Wp (ASD)

1.0 (SCREENWALL)

2.5 (SCREENWALL) 0.942 (Ss = 1.413 & Fa = 1.0 BASED ON LAT/LONG)

1.5 (COMM EQUIPMENT)

z/h =

#### STATEMENT OF SPECIAL INSPECTIONS

SPECIAL INSPECTIONS ARE REQUIRED AS INDICATED IN THE FOLLOWING TABLE. THE CONTRACTOR SHALL SUBMIT A WRITTEN STATEMENT OF RESPONSIBILITY TO THE BUILDING OFFICIAL AND OWNER PRIOR TO COMMENCEMENT OF WORK IN ACCORDANCE WITH SECTION 1704.4 OF THE IBC

STEEL CONSTRUCTION - SPECIAL INSPECTION IS REQUIRED IN CONFORMANCE WITH IBC SECTION 1705.2.

STRUCTURAL OBSERVATION OF THE STRUCTURAL SYSTEM BY THE ENGINEER IS NOT REQUIRED.

FREQUENCY AND DISTRIBUTION OF REPORTS - INSPECTION REPORTS SHALL BE PROVIDED FOR EACH PREQUENCY AND DISTRIBUTION OF REPORTS - INSPECTION REPORTS SHALL BE PROVIDED OF EACH DAY ON SITE BY SPECIAL INSPECTOR. STRUCTURAL OBSERVATION REPORTS SHALL BE PROVIDED AFTER EACH OBSERVATION. REPORTS SHALL BE DISTRIBUTED TO THE CONTRACTOR, ARCHITECT, ENGINEER AND BUILDING OFFICIAL.

#### SPECIAL INSPECTION

CONT	PERIODIC	REMARKS
	Х	
	х	
Х		
	CONT	CONT PERIODIC  X  X  X

ALL ITEMS MARKED WITH AN "X" SHALL BE INSPECTED IN ACCORDANCE WITH IBC CHAPTER 17. PRICTIES MAKKED WITH AMA. A SHALL BE INSPECIED IN ACCORDANCE WITH BIG CHAPTER 17.

SPECIAL INSPECTION SHALL BE PERFORMED BY A QUALIFIED TESTING AGENCY DESIGNATED BY THE OWNIER. THE ARCHITECT, STRUCTURAL ENGINEER, AND BUILDING OFFICIAL SHALL BE FURNISHED WITH COPIES OF ALL RESULTS. ANY INSPECTION FAILING TO MEET THE PROJECT SPECIFICATIONS SHALL BE IMMEDIATELY BROUGHT TO THE ATTENTION OF THE DESIGN TEAM.

SHOP DRAWINGS FOR THE FOLLOWING ITEMS SHALL BE SUBMITTED TO THE ARCHITECT AND STRUCTURAL ENGINEER FOR REVIEW PRIOR TO FABRICATION

1. STRUCTURAL STEEL 2. STEEL GRATING

3. FRP SCREENWALLS

SHOP DRAWINGS SHALL BE REVIEWED, REVISED AS REQUIRED FOR FIELD CONDITIONS, AND DATE STAMPED BY THE CONTRACTOR PRIOR TO REVIEW BY THE ENGINEER. CONTRACTOR SHALL PROVIDE (3) SETS OF SHOP DRAWINGS FOR ENGINEER'S REVIEW. ALLOW TWO WEEKS FOR SHOP DRAWING APPROVAL BY ENGINEER.

ENGINEER'S SHOP DRAWING REVIEW IS FOR GENERAL CONFORMANCE WITH THE DESIGN CONCEPT AND CONTRACT DOCUMENTS. MARKINGS OR COMMENTS SHALL NOT BE CONSTRUED AS RELIEVING THE CONTRACTOR FROM COMPULANCE WITH THE PROJECT PLANS AND SPECIFICATIONS. THE CONTRACTOR REMAINS RESPONSIBLE FOR DETAILS AND ACCURACY, FOR CONFORMING AND CORRELATING ALL QUANTITIES AND DIMENSIONS, FOR SELECTING FABRICATION PROCESSES, FOR TECHNIQUES OF ASSEMBLY, AND FOR PERFORMING THE WORK IN A SAFE MANNER.

ENGINEER'S SHOP DRAWING REVIEW OF STRUCTURAL COMPONENTS DESIGNED BY OTHERS IS FOR ENDINEER'S SHOP DAWNING REVIEW OF STRUCTURE. THE COMPONENT DESIGNER IS RESPONSIBLE FOR CODE COMPONENT DESIGNER IS RESPONSIBLE FOR CODE CONFORMANCE AND ALL CONNECTIONS TO THE BASIC STRUCTURE. SHOP DRAWNINGS SHALL INDICATE MAGNITUDE AND DIRECTION OF THE LOADS IMPOSED ON THE BASIC STRUCTURE AND SHALL BE STAMPED & SIGNED BY A PROFESSIONAL ENGINEER REGISTERED IN THE SAME STATE AS THE PROJECT.

FARRICATION SHALL REGIN ONLY AFTER SHOP DRAWINGS REARING THE STAMP AND SIGNATURE OF THE PROJECT ARCHITECT, ENGINEER OF RECORD, AND CONTRACTOR HAVE BEEN RECEIVED

STRUCTURAL STEEL DESIGN, FABRICATION AND ERECTION SHALL BE IN ACCORDANCE WITH THE AISC "SPECIFICATION FOR THE DESIGN, FABRICATION, AND ERECTION OF STRUCTURAL STEEL FOR BUILDINGS", LATEST EDITION.

WIDE FLANGE SHAPES SHALL CONFORM TO ASTM A992, Fy = 50 KSI

PLATES, ANGLES, CHANNELS, AND RODS SHALL CONFORM TO ASTM A36, Fy = 36 KSI.

STRUCTURAL TUBING SHALL CONFORM TO ASTM A500 GRADE B, Fy = 46 KSI.

STEEL PIPE SHALL CONFORM TO ASTM A53 GRADE B, Fy = 35 KSI

BOLTS CONNECTING STEEL MEMBERS SHALL CONFORM TO ASTM A325-N. BOLTS SHALL BE 3/4" MINIMUM, UNO ANCHOR BOLTS SHALL CONFORM TO ASTM A307.

CONTRACTOR SHALL PROVIDE CONNECTION ADJUSTMENT TOLERANCES TO SATISFY THE REQUIREMENTS OF AISC MANUAL OF STEEL CONSTRUCTION

UNLESS SPECIFIED AS STAINLESS STEEL, ALL STEEL MEMBERS, SHAPES, BOLTS, AND ACCESSORIES EXPOSED TO WEATHER SHALL BE HOT DIP GALVANIZED.

WELDING SHALL CONFORM TO AWS "STRUCTURAL WELDING CODE", LATEST EDITION. ALL WELDING SHALL BE DONE WITH 70 KSI LOW HYDROGEN ELECTRODES. WHERE NOT CALLED OUT, MINIMUM FILLET WELD SIZE SHALL BE PER TABLE 5.8 IN AWS D1.1, LATEST EDITION.

WELDING OF REINFORCING BARS SHALL NOT BE PERMITTED LINESS SPECIFICALLY CALLED OUT ON WELDING OF REINFURCING BARS SHALL NOT BE FERMIN TED UNLESS SPECIFICALLY CALLED OUT ON DRAWINGS OR APPROVED BY STRUCTURAL ENGINEER. WELDING OF GRADE 60 REINFORCING BARS SHALL BE PERFORMED USING LOW HYDROGEN ELECTRODES. WELDING OF GRADE 40 REINFORCING BARS SHALL BE PERFORMED USING FOXY. SLECTRODES. SE REINFORCING NOTES FOR MATERIAL REQUIREMENTS OF WELDED BARS. WELDING WITHIN 4" OF COLD BENDS IN REINFORCING BARS IS NOT

ALL WELDING SHALL BE DONE BY WASHINGTON ASSOCIATION OF BUILDING OFFICIALS (WABO)

#### LUMBER

ALL GRADES SPECIFIED ARE MINIMUM GRADES REQUIRED. ALL LUMBER SHALL BE IN ACCORDANCE WITH WWPA GRADING RULES, KILN-DRIED TO MC 19 AND OF THE FOLLOWING MINIMUM STANDARDS:

SIZE CLASSIFICATION	SPECIES	GRADE	Fb (PSI)	Fc (PSI)
SLEEPERS	DOUG-FIR	#2	875	-

REFER TO PLAN NOTES, SCHEDULES, AND DETAILS FOR MORE SPECIFIC LUMBER SIZE AND GRADE

LINLESS NOTED OTHERWISE IN THE PLANS ALL WOOD AND WOOD-BASED MEMBERS EXPOSED TO WEATHER OR IN CONTACT WITH CONCRETE, MASONRY, OR WITHIN 8" OF SOIL SHALL BE PRESERVATIVE-TREATED BY VACUUM-PRESSURE IMPREGNATION IN ACCORDANCE WITH AWPA

#### NAILS, BOLTS, AND METAL CONNECTORS FOR WOOD

ALL NAILS SHALL CONFORM TO THE STANDARDS SET FORTH BY THE NATIONAL DESIGN STANDARDS (NDS) FOR WOOD CONSTRUCTION, LATEST EDITION. NAILING NOT SPECIFIED SHALL BE FER IBC TABLE 2304.10.1

NAILING SCHEDULE. ALL NAILS CALLED OUT ON PLANS SHALL BE COMMON NAILS UNLESS NOTED

OTHERWISE AND SHALL MEET OR EXCEED THE FOLLOWING MINIMUM GUIDELINES:

NAIL	SHANK Ø	MIN LENGTH
8d COMMON	0.131Ø	2 1/2" SHANK
10d COMMON	0.148Ø	3" SHANK
12d COMMON	0.148Ø	3 1/4" SHANK
16d COMMON	0.162Ø	3 1/2" SHANK

10d BOX NAILS MAY BE SUBSTITUTED FOR 8d COMMON NAILS WITH NO CHANGE IN NAIL SPACING FRAMING MEMBERS MAY BE NAILED WITH 16d SINKERS (0.148"Ø x 3 1/4"), BUT ONLY 16d COMMON NAILS SHALL BE USED WHERE 16d NAILS ARE INDICATED IN THIS DRAWING SET. ENGINEER MAY APPROVE OTHER NAILS IF NAIL LABELS ARE SUBMITTED TO ENGINEER PRIOR TO START OF CONSTRUCTION.

ALL BOLTS IN WOOD MEMBERS SHALL CONFORM TO ASTM A307. PROVIDE WASHERS UNDER THE HEADS AND NUTS OF ALL BOLTS AND LAG SCREWS BEARING ON WOOD. LEAD HOLES FOR LAG BOLTS SHALL BE BORED FOR THE SHANK AND THREADED PORTIONS PER NDS 12.1.4.2.

CONNECTORS CALLED OUT BY LETTERS AND NUMBERS SHALL BE "STRONG-TIE" BY SIMPSON COMPANY, CATALOG TO BE THE LATEST EDITION, OR ENGINEER APPROVED EQUAL. CONNECTORS SHALL BE INSTALLED IN ACCORDANCE WITH THE MANUFACTURER'S RECOMMENDATIONS AND WITH THE NUMBER AND SIZE OF FASTENERS AS SPECIFIED BY THE MANUFACTURER. WHERE CONNECTOR STRAPS CONNECT TWO MEMBERS, PLACE ONE-HALF OF THE NAILS, SCREWS, OR BOLTS IN EACH MEMBER.

INSTALL SOLID BLOCKING AT ALL BEARING POINTS. ALL SHIMS SHALL BE SEASONED, DRIED, AND THE SAME GRADE (MINIMUM) AS MEMBERS CONNECTED.

#### GALVANIZATION

UNLESS NOTED OTHERWISE, STEEL CONNECTORS IN CONTACT WITH TREATED WOOD SHALL BE GALVANIZED ACCORDING TO THE FOLLOWING TABLE:

GALVANIZATION	UNTREATED WOOD	CCA-C	SBX	ACQ-C ACQ-D	CBA-A CA-B	OTHER BORATE	ACZA	OTHER PT WOOD
G90	Х	Х	Х					
G185	Х	х	Х	х	х	х		
HDG	Х	Х	Х	Х	Х	Х		
STT300	Х	Х	Х	Х	Х	Х	Х	Х

G90 = 0.90 OZ. OF ZINC PER SQUARE FOOT OF AREA G185 = 1.85 OZ. OF ZINC PER SQUARE FOOT OF AREA HDG = HOT DIP GALVANIZED SST300 = TYPE 316L STAINLESS STEEL

#### RATED SHEATHING

RATED SHEATHING SHALL BE GRADE C-D INT-APA WITH EXTERIOR GLUE OR OSB SHEATHING WITH EXTERIOR GLUE IN CONFORMANCE WITH IBC STANDARD 2303.1.5.

#### FIBER REINFORCED POLYMER (FRP) SHAPES AND FASTENERS

ALL FRP STRUCTURAL SHAPES SHALL BE 1625 SERIES PULTEX STANDARD PROFILES BY CREATIVE PULTRUSIONS, INC OR APPROVED EQUAL.

ALL FRP FLAT PANELS SHALL BE 1500/1525 OR 1625 SERIES PULTEX STANDARD PROFILES BY CREATIVE

BOLTS AND NUTS SHALL BE SUPERSTUD FIBER REINFORCED POLYMER FASTENER SYSTEM BY CREATIVE PULTRUSIONS, INC OR APPROVED EQUAL.

ALL FRP PRODUCTS EXPOSED TO WEATHER SHALL CONTAIN AN ULTRAVIOLET INHIBITOR.

ALL FIELD CUT, DRILLED EDGES AND HOLES SHALL BE SEALED WITH CATALYZED RESIN AS

FIBER REINFORCED POLYMER PRODUCTS SHALL BE DESIGNED AND PROVIDED BY HI-TECH COMPOSITE STRUCTURES OR ENGINEER-APPROVED EQUIVALENT MANUFACTURES. SHOP DRAWINGS ARE REQUIRED PER THE STRUCTURAL NOTES AND SHALL BE DESIGNED AND STAMPED BY THE MANUFACTURER'S PROFESSIONAL ENGINEER LICENSED IN THE SAME STATE AS THE PROJECT. REFER TO THE DESIGN LOADS SECTION OF THE STRUCTURAL NOTES FOR MAXIMUM WEIGHT OF SCREENWALL AS WELL AS LATERAL FORCE REQUIREMENTS.

#### STEEL GRATING

PROVIDE GALVANIZED STEEL FLOOR GRATING BY GRATING PACIFIC OR APPROVED EQUAL. BAND ALL GRATING EDGES.

TYPE OF GRATING: 19-W-4

SIZE OF BEARING BARS: 1 1/2" x 1/8" @ 1 3/16" OC MAX SPAN: 7'-0"

MANUFACTURER/SUPPLIER TO PROVIDE CONNECTION OF GRATING TO STRUCTURAL STEEL WITH "G" CLIPS. SUBMIT SHOP DRAWINGS FOR APPROVAL. PROVIDE MIN. OF (1) "G" CLIP CONNECTOR BETWEEN GRATING & STRUCTURAL STEEL ADJACENT TO EACH LOCATION WHERE EQUIPMENT IS ATTACKED TO THE CRETTER OF THE CONTROL OF T ATTACHED TO THE GRATING

MOUNT EQUIPMENT TO GRATING USING GM SERIES CLIPS WITH 1/2"Ø THREADED STUDS MANUFACTURED BY G-CLIPS GRATING FASTENERS

CONTRACTOR SHALL VERIFY ALL DIMENSIONS, MEMBER SIZES AND CONDITIONS OF THE EXISTING BUILDING DEPICTED IN THE DRAWINGS, AND NOTIFY THE STRUCTURAL ENGINEER OF ANY DISCREPANCIES FOR POSSIBLE REDESIGN.

#### GENERAL

STRUCTURAL DRAWINGS SHALL BE USED IN CONJUNCTION WITH ARCHITECTURAL, CIVIL, ELECTRICAL, AND MECHANICAL DRAWINGS FOR BIDDING AND CONSTRUCTION, CONTRACTOR SHALL VERIEY ALL DIMENSIONS AND CONDITIONS FOR COMPATIBILITY BEFORE PROCEEDING. ANY DISCREPANCIES SHALL BE BROUGHT TO THE ATTENTION OF THE ARCHITECT BEFORE PROCEED

CONTRACTOR TO SEE ARCHITECTURAL, CIVIL, ELECTRICAL AND MECHANICAL DRAWINGS FOR SIZE AND LOCATION OF PIPE, VENT, DUCT AND OTHER OPENINGS AND DETAILS NOT SHOWN ON THESE

CONTRACTOR SHALL BE RESPONSIBLE FOR ERECTION STABILITY AND TEMPORARY SHORING AS

CONTRACTOR-INITIATED CHANGES SHALL BE SUBMITTED IN WRITING TO THE ARCHITECT AND STRUCTURAL ENGINEER FOR APPROVAL PRIOR TO FABRICATION OR CONSTRUCTION. CHANGES SHOWN ON SHOP DRAWINGS ONLY WILL NOT SATISFY THIS REQUIREMENT.

DRAWINGS INDICATE GENERAL AND TYPICAL DETAILS OF CONSTRUCTION. WHERE CONDITIONS ARE NOT SPECIFICALLY INDICATED BUT ARE OF A SIMILAR CHARACTER TO DETAILS SHOWN, SIMILAR DETAILS OF CONSTRUCTION SHALL BE USED, SUBJECT TO REVIEW AND APPROVAL BY THE ARCHITECT AND THE STRUCTURAL ENGINEER.


	LEGI	END	
DEFINITION	SYMBOL	DEFINITION	SYMBOL
DIRECTION OF FRAMING	4	NATIVE SOIL	
EXTENT OF FRAMING	$\longleftrightarrow$	GRANULAR FILL	
COLUMNS	Z e	STRUCTURAL STEEL	\(\frac{1}{2}\)\(\text{11}\)\(\text{11}\)\(\text{12}\)\(\text{12}\)\(\text{12}\)\(\text{12}\)\(\text{12}\)\(\text{12}\)\(\text{12}\)\(\text{12}\)\(\text{12}\)\(\text{12}\)\(\text{12}\)\(\text{12}\)\(\text{12}\)\(\text{12}\)\(\text{12}\)\(\text{12}\)\(\text{12}\)\(\text{12}\)\(\text{12}\)\(\text{12}\)\(\text{12}\)\(\text{12}\)\(\text{12}\)\(\text{12}\)\(\text{12}\)\(\text{12}\)\(\text{12}\)\(\text{12}\)\(\text{12}\)\(\text{12}\)\(\text{12}\)\(\text{12}\)\(\text{12}\)\(\text{12}\)\(\text{12}\)\(\text{12}\)\(\text{12}\)\(\text{12}\)\(\text{12}\)\(\text{12}\)\(\text{12}\)\(\text{12}\)\(\text{12}\)\(\text{12}\)\(\text{12}\)\(\text{12}\)\(\text{12}\)\(\text{12}\)\(\text{12}\)\(\text{12}\)\(\text{12}\)\(\text{12}\)\(\text{12}\)\(\text{12}\)\(\text{12}\)\(\text{12}\)\(\text{12}\)\(\text{12}\)\(\text{12}\)\(\text{12}\)\(\text{12}\)\(\text{12}\)\(\text{12}\)\(\text{12}\)\(\text{12}\)\(\text{12}\)\(\text{12}\)\(\text{12}\)\(\text{12}\)\(\text{12}\)\(\text{12}\)\(\text{12}\)\(\text{12}\)\(\text{12}\)\(\text{12}\)\(\text{12}\)\(\text{12}\)\(\text{12}\)\(\text{12}\)\(\text{12}\)\(\text{12}\)\(\text{12}\)\(\text{12}\)\(\text{12}\)\(\text{12}\)\(\text{12}\)\(\text{12}\)\(\text{12}\)\(\text{12}\)\(\text{12}\)\(\text{12}\)\(\text{12}\)\(\text{12}\)\(\text{12}\)\(\text{12}\)\(\text{12}\)\(\text{12}\)\(\text{12}\)\(\text{12}\)\(\text{12}\)\(\text{12}\)\(\text{12}\)\(\text{12}\)\(\text{12}\)\(\text{12}\)\(\text{12}\)\(\text{12}\)\(\text{12}\)\(\text{12}\)\(\text{12}\)\(\text{12}\)\(\text{12}\)\(\text{12}\)\(\text{12}\)\(\text{12}\)\(\text{12}\)\(\text{12}\)\(\text{12}\)\(\text{12}\)\(\text{12}\)\(\text{12}\)\(\text{12}\)\(\text{12}\)\(\text{12}\)\(\text{12}\)\(\text{12}\)\(\text{12}\)\(\text{12}\)\(\text{12}\)\(\text{12}\)\(\text{12}\)\(\text{12}\)\(\text{12}\)\(\text{12}\)\(\text{12}\)\(\text{12}\)\(\text{12}\)\(\text{12}\)\(\text{12}\)\(\text{12}\)\(\text{12}\)\(\text{12}\)\(\text{12}\)\(\text{12}\)\(\text{12}\)\(\text{12}\)\(\text{12}\)\(\text{12}\)\(\text{12}\)\(\text{12}\)\(\text{12}\}\(\text{12}\)\(\text{12}\)\(\text{12}\}\(\
COLUMN BEARING ON BEAM		RATED SHEATHING	
BEAM CONTINUOUS OVER SUPPORT		SHEAR WALL (SEE SCHEDULE)	SWX
CONCRETE WALL	5	COLUMN MARK (SEE SCHEDULE)	Ø
BEARING STUD WALL	5	FOOTING MARK (SEE SCHEDULE)	(FX)
NON-BEARING STUD WALL	5	HOLDOWN MARK (SEE SCHEDULE)	♦
BEARING STUD SHEAR WALL	(MANANA)	HANGER MARK (SEE SCHEDULE)	(8)
NON-BEARING	4////	FLAG NOTE	$\boxtimes$

MU WALL

STEEL MOMENT

**-**

ABBREVIATIONS				
(A)	ABOVE	GLB	GLUE-LAMINATED BEAM	
AB	ANCHOR BOLT	HORIZ	HORIZONTAL	
ALT	ALTERNATE	KP	KING POST	
ARCH	ARCHITECT	KSI	KIPS PER SQUARE INCH	
(B)	BELOW	L	ANGLE	
BD	BAR DIAMETER	MECH	MECHANICAL	
BLKG	BLOCKING	MF	MOMENT FRAME	
BM	BEAM	MTL	METAL	
ВОТ	воттом	NS	NEAR SIDE	
BRNG	BEARING	ОС	ON CENTER	
BTWN	BETWEEN	OPP	OPPOSITE	
CJP	COMPLETE JOINT PENETRATION	PL	PLATE	
CLR	CLEAR	PLCS	PLACES	
CMU	CONCRETE MASONRY UNIT	PSI	POUNDS PER SQUARE INCH	
COL	COLUMN	PSF	POUNDS PER SQUARE FOOT	
CONC	CONCRETE	P/T	POST TENSIONED	
CONN	CONNECTION	PT	PRESSURE TREATED	
CONT	CONTINUOUS	REINF	REINFORCING	
COORD	COORDINATE	REQ'D	REQUIRED	
DBL	DOUBLE	SCHED	SCHEDULE	
DET	DETAIL	SIM	SIMILAR	
DIA	DIAMETER	SOG	SLAB ON GRADE	
DIM	DIMENSION	STD	STANDARD	
DIR	DIRECTION	STIFF	STIFFENER	
EA	EACH	STL	STEEL	
ELEV	ELEVATION	SYMM	SYMMETRICAL	
ES	EACH SIDE	SW	SHEARWALL	
EX	EXISTING	TOC	TOP OF CONCRETE	
EXP	EXPANSION	TOS	TOP OF STEEL	
FLR	FLOOR	TOW	TOP OF WALL	
FDN	FOUNDATION	TYP	TYPICAL	
FTG	FOOTING	UNO	UNLESS NOTED OTHERWISE	
FS	FAR SIDE	VERT	VERTICAL	
GC	GENERAL CONTRACTOR	WF	WIDE FLANGE	

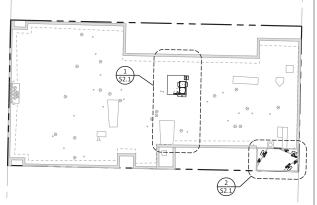

# **OVERALL ROOF PLAN**

## **T** - Mobile-

=PROJECT INFORMATION:=


#### **WELLER KING/FUJISADA** CONDOS SE03494E

510 6TH AVE S **SEATTLE, WA 98104** 

=ISSUED FOR:=

==REVISION HISTORY:=

#### **BUILDING PERMIT**

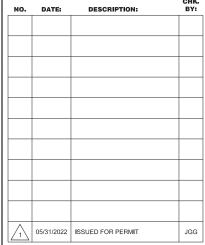

PLANS PREPARED BY:

B. J. THOMAS, P.E. **7607 80TH AVE NE MARYSVILLE, WA 98270** 206-851-1106

DRAWN BY: CHK. BY:

JEG JGG
---------

=LICENSURE:=




CG# 22070 603 DRAWING INFORMATION:

DO NOT SCALE DRAWINGS. CONTRACTOR MUST VERIEY DO NOT SCALE DRAWINGS. CONTINACTOR MUST VERHIT ALL DIMENSIONS AND ADVISE CONSULTANTS OF ANY ERRORS AND OMISSIONS. ALL PREVIOUS ISSUES OF THIS DRAWING ARE SUPERSEDED BY THE LATEST REVISION. THE INFORMATION CONTAINED IN THIS SET OF DOCUMENTS IS PROPRIETARY BY NATURE. ANY USE OR DISCLOSURE OTHER THAN WHICH IS RELATED TO NAMED CLIENT IS STRICTLY PROHIBITED

DRAWING TITLE:

### STRUCTURAL NOTES **AND ROOF PLAN**

=DRAWING NUMBER:====

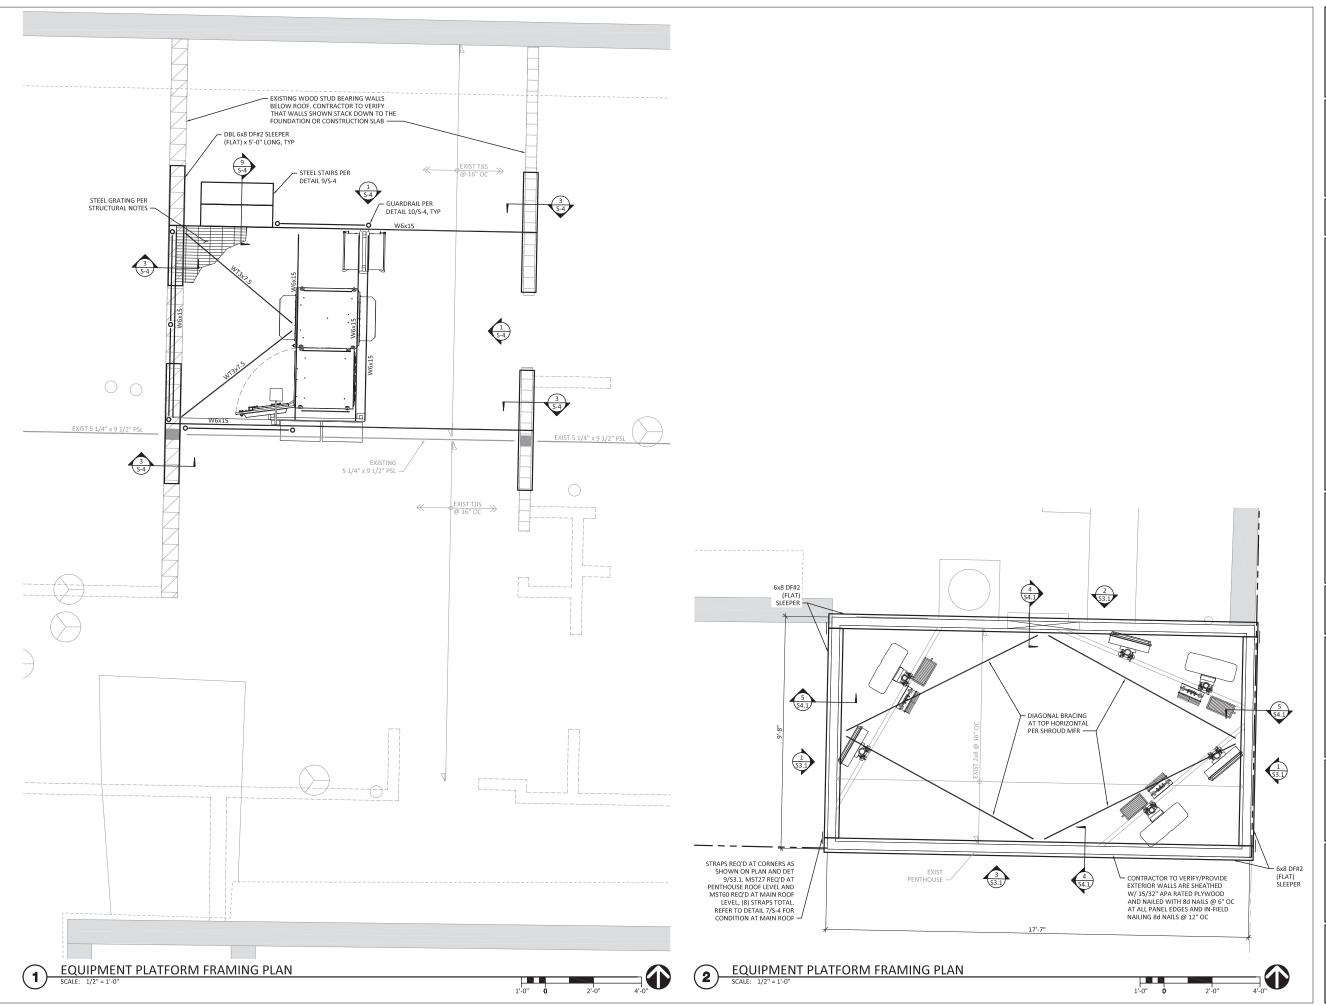

PROJECT INFORMATION:

#### WELLER KING/FUJISADA CONDOS SE03494E

510 6TH AVE S SEATTLE, WA 98104

ISSUED FOR:=

#### **BUILDING PERMIT**



PLANS PREPARED BY:

B. J. THOMAS, P.E. 7607 80TH AVE NE MARYSVILLE, WA 98270 206-851-1106

DRAWN BY: CHK. BY:

JEG JGG

LICENSURE:



CG# 22070.603

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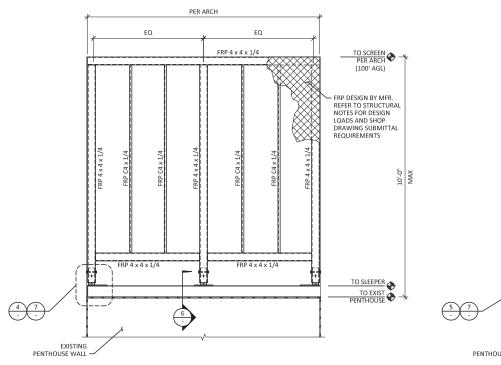
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DRAWING TITLE:

ENLARGED PLANS

DRAWING NUMBER:


**S-2** 




PER ARCH EQ EQ DOOR OPENING FRP 4 x 4 x 1/4 TO SCREEN PER ARCH (100' AGL) FRP DESIGN BY MFR. FRP DESIGN BY MFR.
 REFER TO STRUCTUREN
 NOTES FOR DESIGN
 LOADS AND SHOP
 DRAWING SUBMITTAL
 REQUIREMENTS FRP 4 x 4 x 1/4 TO SLEEPER TO EXIST PENTHOUSE — 4" GAP WHERE REQ'D FOR DRAINAGE (LOCATE BETWEEN SCREENWALL POSTS) PENTHOUSE WALL


**SCREEN WALL ELEVATION** 

**SCREEN WALL ELEVATION (2**)

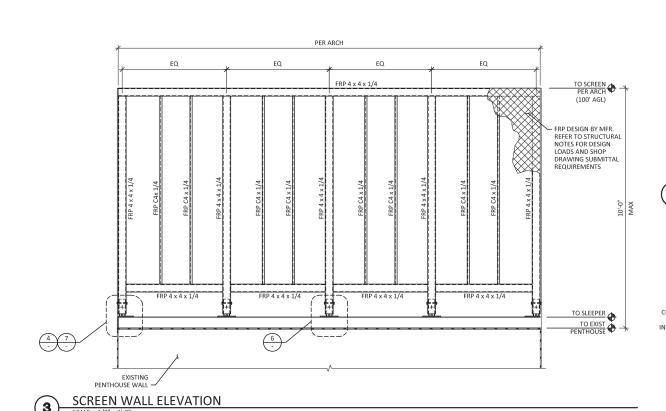

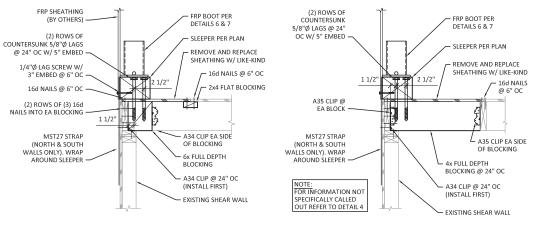


7

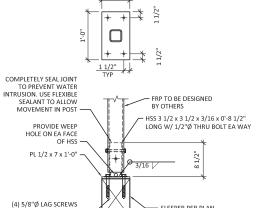

SLEEPER PER PLAN

FRP SCREEN CONN (PERPENDICULAR)

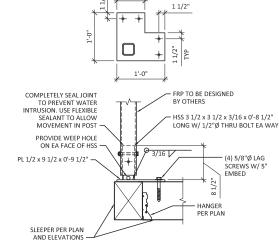

FRP BOOT CORNER CONN

FRP SCREEN CONN (PARALLEL)

**T** - - Mobile -

PROJECT INFORMATION:

#### **WELLER KING/FUJISADA** CONDOS SE03494E

510 6TH AVE S SEATTLE, WA 98104

ISSUED FOR:=

#### **BUILDING PERMIT**



PLANS PREPARED BY:

B. J. THOMAS, P.E. **7607 80TH AVE NE MARYSVILLE, WA 98270** 206-851-1106

DRAWN BY: CHK. BY: JGG

LICENSURE:



CG# 22070 603 =DRAWING INFORMATION:=


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DRAWING TITLE:

### **ELEVATIONS AND DETAILS**

DRAWING NUMBER:

FRP BOOT CONN

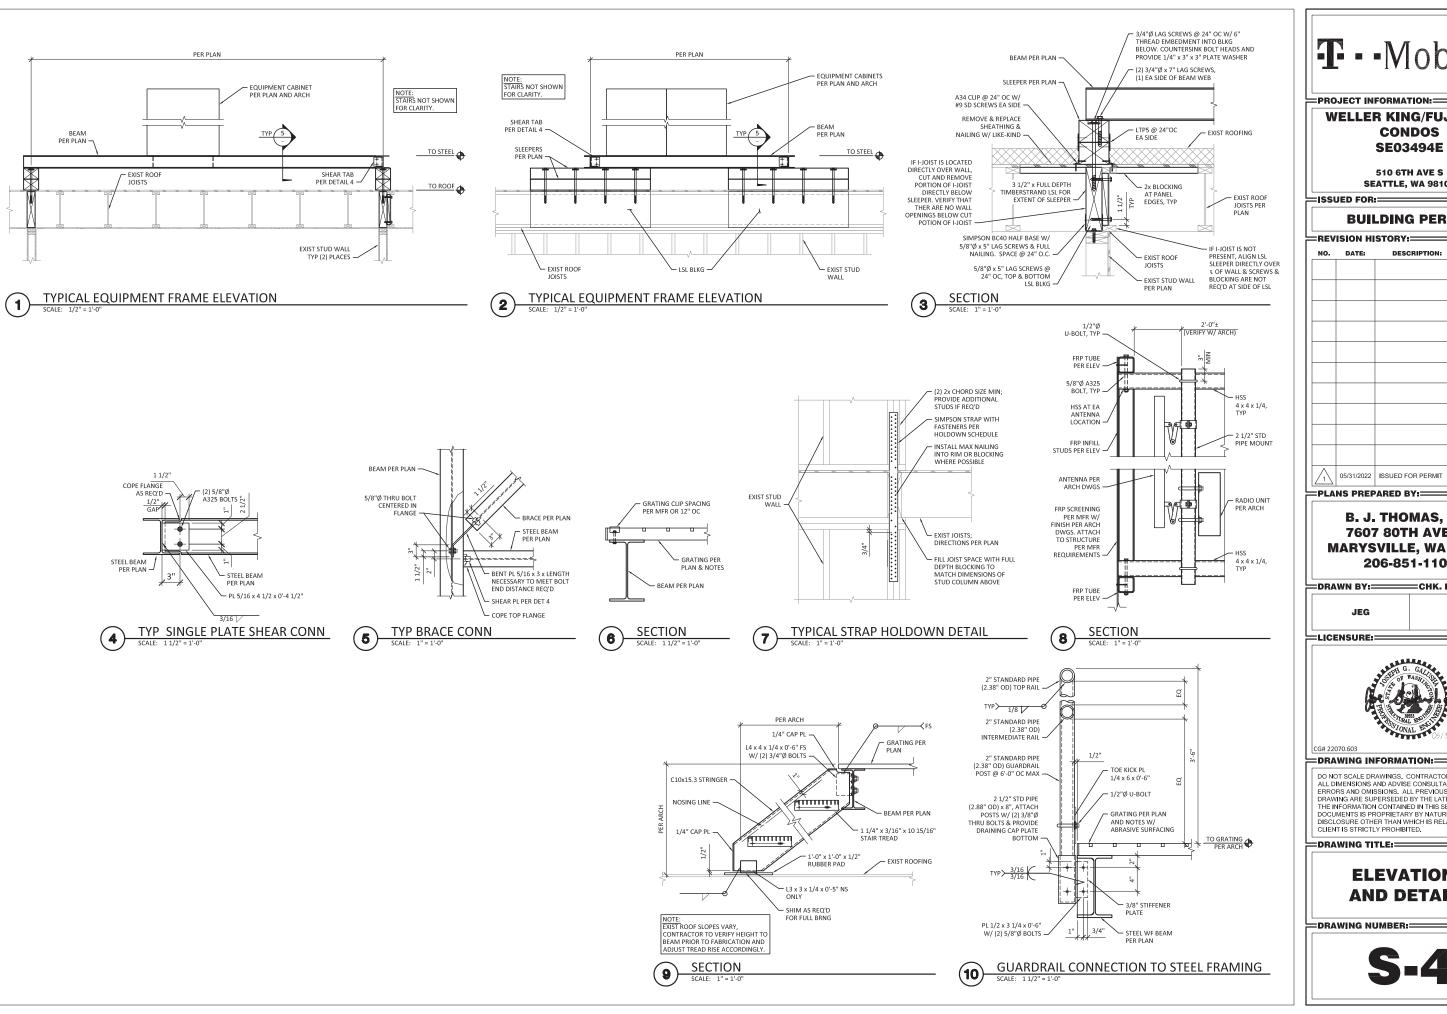


PROJECT INFORMATION:

#### **WELLER KING/FUJISADA** CONDOS SE03494E

510 6TH AVE S SEATTLE, WA 98104

ISSUED FOR:=

#### **BUILDING PERMIT**

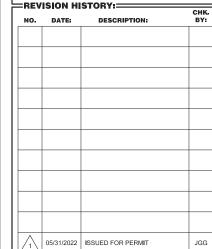

B. J. THOMAS, P.E. **7607 80TH AVE NE MARYSVILLE, WA 98270** 206-851-1106

DRAWN BY:----CHK. BY:-

JGG

LICENSURE:



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DRAWING TITLE:

### **ELEVATIONS AND DETAILS**