

Date: September 24, 2025

To: City of Seattle Landmarks Preservation Board
CC: Erin Doherty, Landmarks Preservation Program Staff

From: David Graves, AICP, Strategic Advisor

Subject: Gas Works Park Cracking Towers - Pedestrian Access Elements Removal

**Certificate of Approval Application** 

In response to questions from the Landmarks Preservation Board at a briefing on September 17<sup>th</sup>, Seattle Parks and Recreation (SPR) is providing the following information. I've included Board questions, as I heard them and after consulting with Erin Doherty, and SPR's response.

- Has a condition survey been conducted of the steel elements that are proposed for removal? No formal survey has been done but we have done visual assessments. The steel elements are difficult to assess for a number of reasons; the steel is painted so it is difficult to undertake a complete assessment; the consultants we are working with feel that it is too risky to get on the towers to undertake any assessment; there is significant evidence of deterioration including oxidation on steel elements, pieces of the pedestrian access elements on the ground that have fallen off the towers is evidence of failure; the gas plant ceased operations in the mid-1950s which make the towers at least 70+ years old towers, lack of use, limited ongoing maintenance and continued exposure to the elements for seventy plus years has likely left the exposed pedestrian elements in varying states of stability.
- Would it be possible to leave more of the built features near the top of the tanks? Yes; additional response is provided below
- Could the work crew start selective removal from the bottom and make a determination to leave certain elements intact as they worked their way up? Work will likely start from the top because the upper features are supported by lower elements which extend down to the ground. It may be possible to retain upper appurtenances that don't provide access to the towers. As an example, the upper segments of ladder cage(s) could be retained so long as the actual ladders are removed. SPR would commit to consider saving elements; actual elements saved would have to be field verified during the demolition based on the condition of element(s) to be retained and is ability to remain self-supporting without becoming a safety hazard to SPR staff as they continue to maintain the grounds around the towers. Public safety is paramount, and we will not save anything that could compromise public safety.
- Is it possible to reconfigure the perimeter fence to enclose the elevated pipe on the west side, rather than remove it? We could expand the fence to include the pipe, but that removes open space and adds more fencing around the towers which would end up blocking views of that pipe. Due to the similarity of heights, that pipe would not be visible if the fence is extended around it and the pipe remains a potential safety hazard to SPR crews doing maintenance inside the fence. If left in place, the pipe continues to present a potential safety hazard. It could be extremely

compromised from the inside with no visible evidence on the exterior. Another option would be to remove the middle section of the pipe between the yellow bars on the following graphic. SPR could commit to saving portions of the pipe that are within the Cracking Tower fence, pending field verification by SPR's Consultant, staff and selected contractor that the remnants and supports are safe and structurally sound and don't contain any hazardous materials.



- Has SPR spoken with SPD about ways to address the issues? SPR has had discussions with SPD about the cracking towers. Those discussions are part of the rationale for the ongoing vegetation management inside the fence. SPR staff keeps the grass mowed and invasive species under control to keep sight lines open to the towers. SPR hires contractor(s) to remove vegetation and trees that grow up under and through the towers; SPR staff won't work under the towers due to safety concerns. SPD does drive through the park on occasion and keeping the vegetation down enables better visual access.
- Can SPR clarify a potential timeline for implementing Richard Haag's vision to have no fence around the cracking towers? SPR does not have a timeline for removal of the fence and allowing public access to the area around the towers; SPR currently has no budget identified to do any work associated with the towers beyond the proposed removal and subsequent lighting. The broader City focus is finalizing the design of the sediment remedy and implementing the remediation project in partnership with Puget Sound Energy (PSE). PSE owns the majority share of the liability, but the City's share is not insignificant; total project costs are currently estimated to be \$60-80M.

• The following graphic provides details on the ages of the Cracking Towers.



Gas Works Park - Cracking Tower Work/Repairs

September 9, 2025

#### Introduction

As requested by Landmarks Board staff, below is a brief overview describing work by SPR on the fence surrounding the Cracking Towers at Gas Works Park and other actions to deter climbing of the towers. This is cursory and not intended to be a thorough history of the site. The timelines are approximate and based off memory.

#### **Background**

The fence around the Cracking Towers is considered an Institutional Control as part of the Consent Decree for the upland cleanup work and maintenance and improvement, if necessary, of the fence is required. Pursuant to the Consent Decree, Seattle Parks & Recreation (SPR) Staff inspect the soil cover and fence on a regular (approximately weekly) basis, needed repairs are typically handled through SPR's work order system, minor work that can be done by the grounds crew in the regular course of their activities at the park may not generate a work order. In addition, the Northeast District maintenance staff are at the park on a daily basis and also call-in work orders if they see issues with the fence or gates.

#### Timeline (approximate)

June 26, 2015 – Landmarks Preservation Board (LPB) – Architectural Review Committee (ARC) briefing to discuss removing some or all of the stairs and landings to deter climbing of the south towers. ARC suggested starting with more focused removals of obvious access points.

2016 - SPR hires PSM Consulting Engineers to undertake a Climbing and Safety Evaluation of Towers 1 & 2 (southerly large towers).

August 7, 2019 – LPB issues Certificate of Approval (CoA) to allow SPR to perform selective removal of climbable features and undertake limited alterations to Towers 1 & 2 to deter climbing.

2019-2023 – SPR Metal Shop Crew undertakes approved work on Towers 1 & 2. Ongoing repairs were also being made to the fence and gates intermittently, as it was cut or otherwise manipulated/vandalized, ostensibly to gain access into the restricted area.

2023 – SPR hired All City Fence to do a complete restoration of the chain-link fence, restore the barbed wire on top of the fence, add steel mesh panels over the chain-link and reconstruct the gates with the steel mesh to resist cutting and strengthen the gates.

2023 – SPR hired a landscape contractor to remove all vegetation and trees that were growing around and amongst the towers to make the area more open and remove potential access point(s) to the towers. Note that SPR crews have been and continue to remove blackberries and mow the lawn areas around the towers within the Cracking Tower fenced area. They generally avoid working directly under the towers due to safety concerns/potential falling metal.

2024 – A leaning support element within the Cracking Tower area, between the North and South Towers, was removed with a CoA from LPB issued on June 26, 2024

2023-2025 – SPR facilities continues to address access points; 3 of the 4 gates have been welded shut; area(s) under the gates have been paved to strengthen the gates and limit the possibility of digging under a gate.

#### Incidents

The following is a list of incidents at the Cracking Towers since 2008. This list is based on aid calls that Seattle Fire Department (SFD) responded to and has been provided by SFD:

Date and	Victim Details	Description	Outcome
Time			
10/11/2008	Male, age 22	Climbed fenced-off structure; catwalk gave way, fell onto another catwalk.	Non-life-threatening (possible dislocated shoulder)
0400 hours			·
12/13/2009	Female	Fell off structure.	Life-threatening
0023 hours	(age 25)		injuries; survived
5/25/2012	Male, age 19	Fell off towers. Was visiting Seattle from Massachusetts.	Death
0010 hours			
3/29/2013	Male	Fell off structure; unconscious with liver and head injuries.	Life-threatening injuries; survived
0517 hours	(age 19)		
7/19/2014	Female, 19	Fell 35 feet while writing graffiti.	Multiple broken bones; survived
0322 hours		0.2	33

Date and Time	Victim Details	Description	Outcome
1/25/2015	Male	Fell off structure.	Life-threatening head and internal injuries;
0033 hours	(age 21)		survived
2/1/2015	Male	Fell off structure but remained	Injuries; transported to
2210 hours	(age 19)	conscious.	HMC
12/11/2016	Male	Fell off structure while intoxicated after he missed a hole in catwalk; rescued by	Open femur fracture, possible pelvic fracture, etc.; survived
2213 hours	(age 23)	SFD.	,,
1/1/2019	Male	Climbed while intoxicated; fell.	Significant injuries;
2213 hours	(age 40)		survived
2/21/2022	Male	Fell off structure; rescued by	Broken leg, head
0117 hours	(age 26)	SFD.	laceration; survived
9/17/2022	Female	Fell through an opening in the walkway while climbing with friends on the south towers.  They had all been drinking.	Death
0242 hours	(age 20 )		
	Only known female victim.		
11/23/2023	Male	Fell off refinery; unconscious,	Survived with brain
0030 hours	(age 16)	no pulse.	damage.
3/29/2024	Male	Fell 60 feet; walking and	Injuries; treated at
2318 hours	(age 19)	talking.	HMC
7/10/2025	Male	Fell off towers after a classical music concert in the park.	Death
2230 hours	(age 15)		

# Gas Works Park Cracking Towers Tower Photographs

David Graves, Strategic Advisor







SITE PLAN FROM SOUTH



















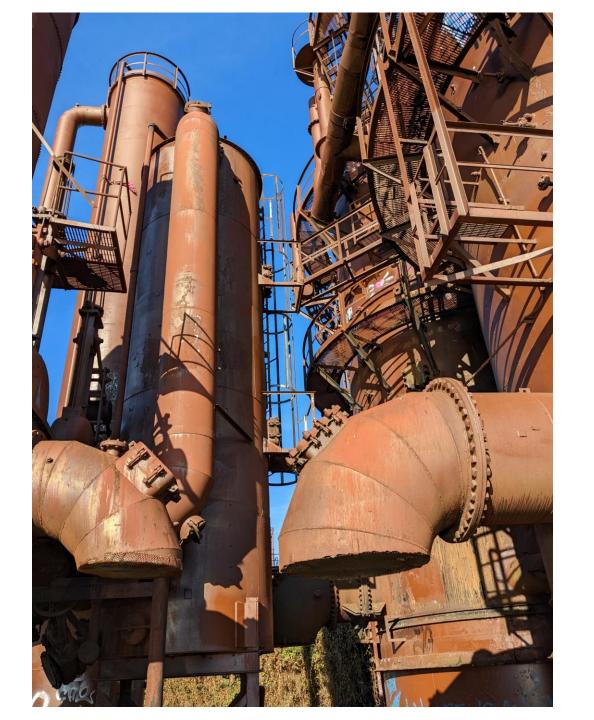

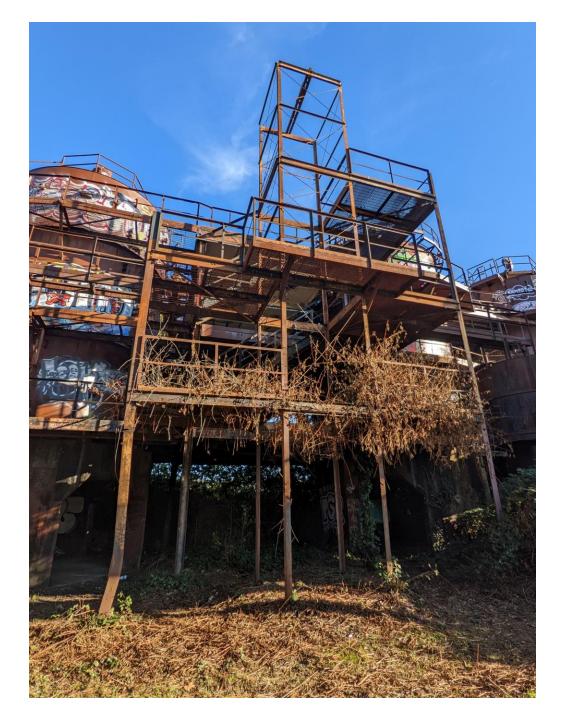









# GAS WORKS PARK "CRACKING TOWERS": EMERGENCY SELECTIVE DECONSTRUCTION

1901 N NORTHLAKE WAY 98103



VICINITY MAP

GAS WORKS PARK - NOT TO SCALE

#### **PROJECT TEAM**

#### **OWNER**

SEATTLE PARKS AND RECREATIONS 100 DEXTER AVE N, SEATTLE, WA, 98109

**CONTACT:** MIKE SCHWINDELLER

**PHONE**: 206.615.1165

**EMAIL:** 

MIKE.SCHWINDELLER@SEATTLE.GOV

#### **ARCHITECT**

OSBORN ARCHITECTS INC., PS (OAI) 1001 SW KLICKITAT WAY, STE 204 SEATTLE, WA 98134 CONTACT: JERRY OSBORN

PHONE: 206.920.6348

EMAIL: JOSBORN@OAIPS.COM

### HAZMAT CONSULTANT

CONTACT: RYAN HUNTER

**PHONE:** 484.269.2138

**EMAIL:** RYAN.HUNTER@PBSUSA.COM

#### **SITE INFORMATION**

**PROPERTY ADDRESS: 1901 N NORTHLAKE** 

WAY 98103

**OWNER:** SEATTLE PARKS AND RECREATION

**ZONING:** UI U/45

**PARCEL NUMBER:**124970-0005

#### **SCOPE OF WORK**

SELECTIVE REMOVAL OF PIPING, CATWALKS, LADDERS AND SUPPORT SYSTEMS FROM TOWER STRUCTURES LOCATED WITHIN GAS WORKS PARK. EMERGENCY SECURITY LIGHTING SYSTEMS.

#### **SHEET LIST**

G1.00	COVER SHEET
D1.01	DECONSTRUCTION PERSPECTIVE RENDERINGS
D1.02	SELECTIVE DECONSTRUCTION PLAN
D1.03	WEST DECONSTRUCTION ELEVATION
D1.04	NORTH DECONSTRUCTION ELEVATION
D1.05	SOUTH DECONSTRUCTION ELEVATION
D1.06	EAST DECONSTRUCTION ELEVATION
D1.07	POST DECONSTRUCTION PERSPECTIVE RENDERINGS
D1.08	POST DECONSTRUCTION WEST ELEVATION
D1.09	POST DECONSTRUCTION NORTH ELEVATION
D1.10	POST DECONSTRUCTION SOUTH ELEVATION
D1.11	POST DECONSTRUCTION EAST ELEVATION

#### **GENERAL NOTES**

1. (E) PAINT COATINGS CONTAIN LEAD. RE FOR WORKER SAFETY AND DISPOSAL REQUIREMENTS.
2. EXISTING SOILS ARE CONTAMINATED. NO SOIL DISTURBANCE IS ANTICIPATED.

3. (E) TANKS OR PIPING MAY CONTAIN REMNANTS OF HYDROCARBONS. CONTRACTOR RESPONSIBLE FOR CUTTING EQUIPMENT AND TECHNIQUES EMPLOYED TO ENSURE WORKER SAFETY.







**GAS WORKS PARK** 

**EMERGENCY DEMOLITION** 

COVER SHEET


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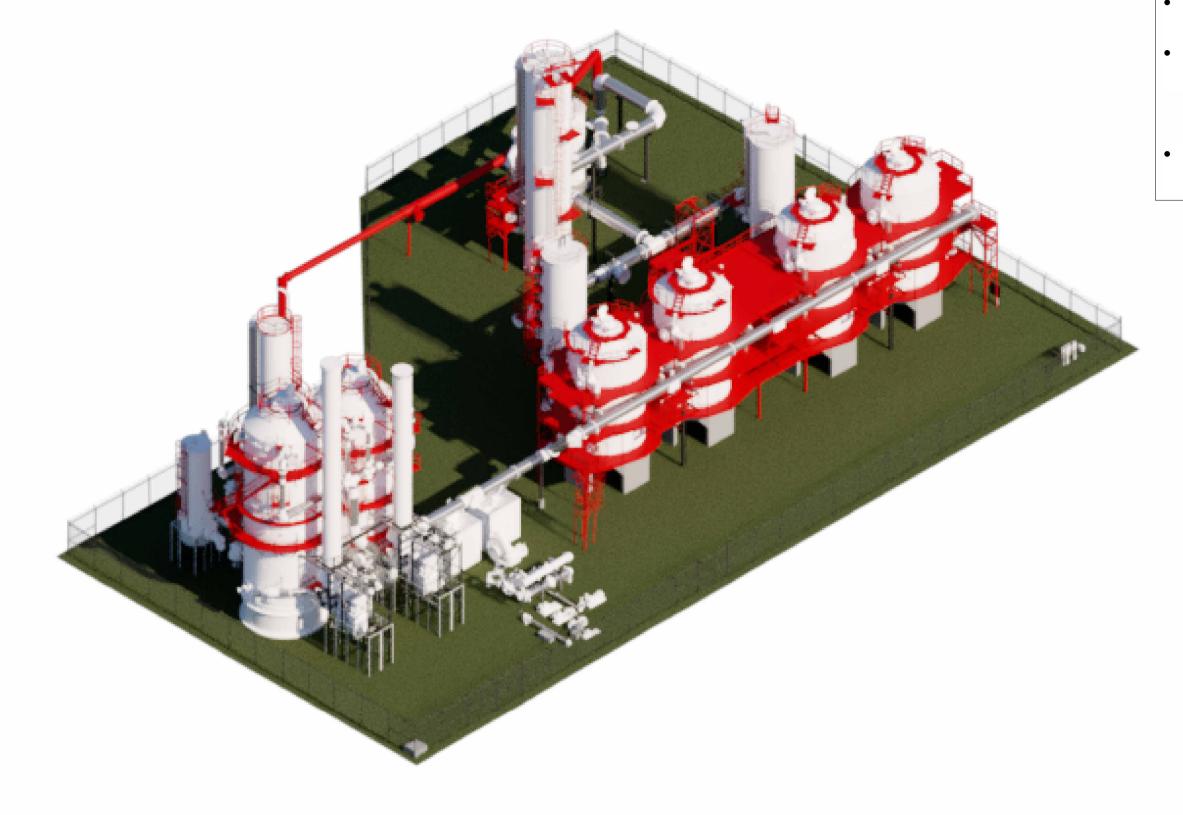
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LEVEL

ITEMS RENDERED IN RED ARE SELECTED

CUT-OFF VERTICAL FRAMING AT GROUND

CAPPING OF UTILITY PIPING IS INCLUDED

FOR REMOVAL AND DISPOSAL (TYP.)

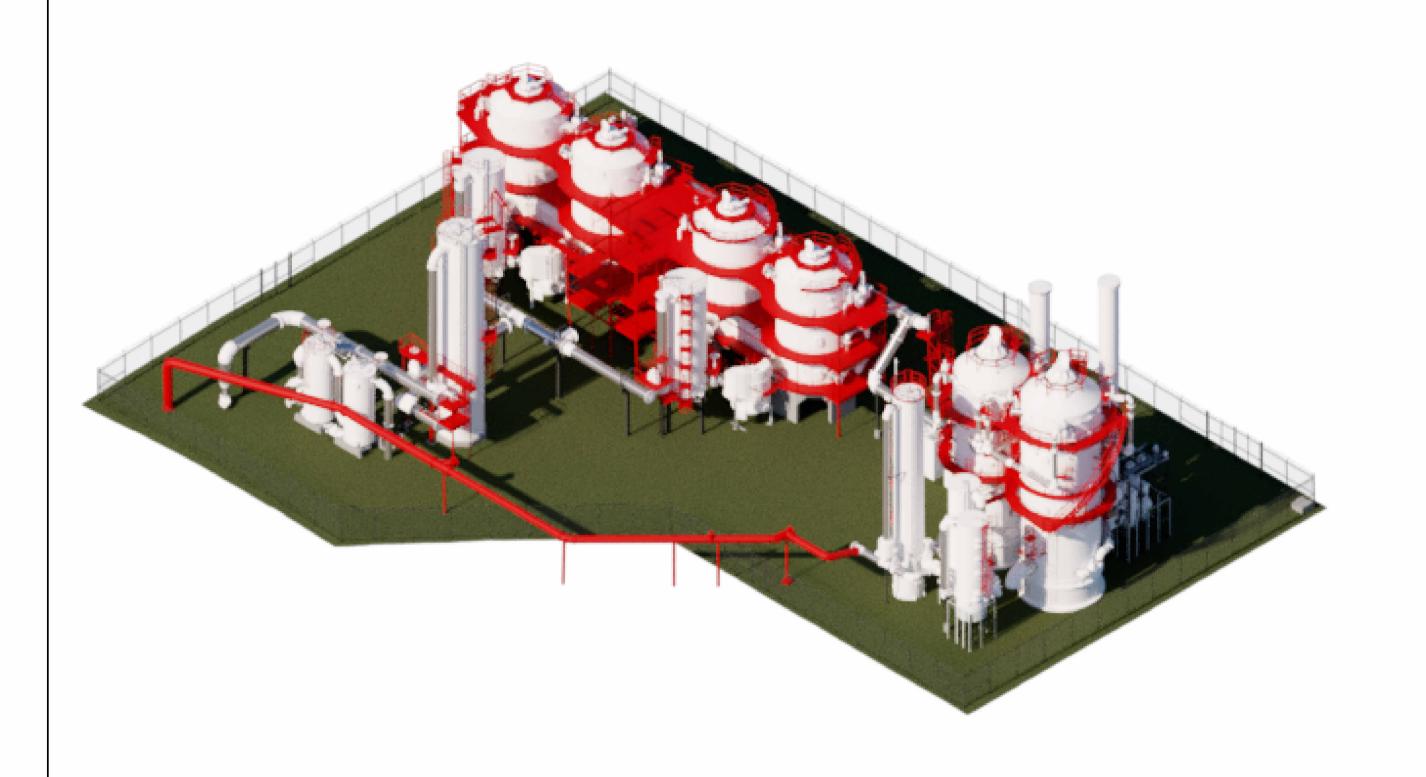SOIL DISTURBANCE IS EXCLUDED


FROM THIS PROJECT.

IN THE SCOPE OF THIS PROJECT.



4 NW PERSPECTIVE NTS



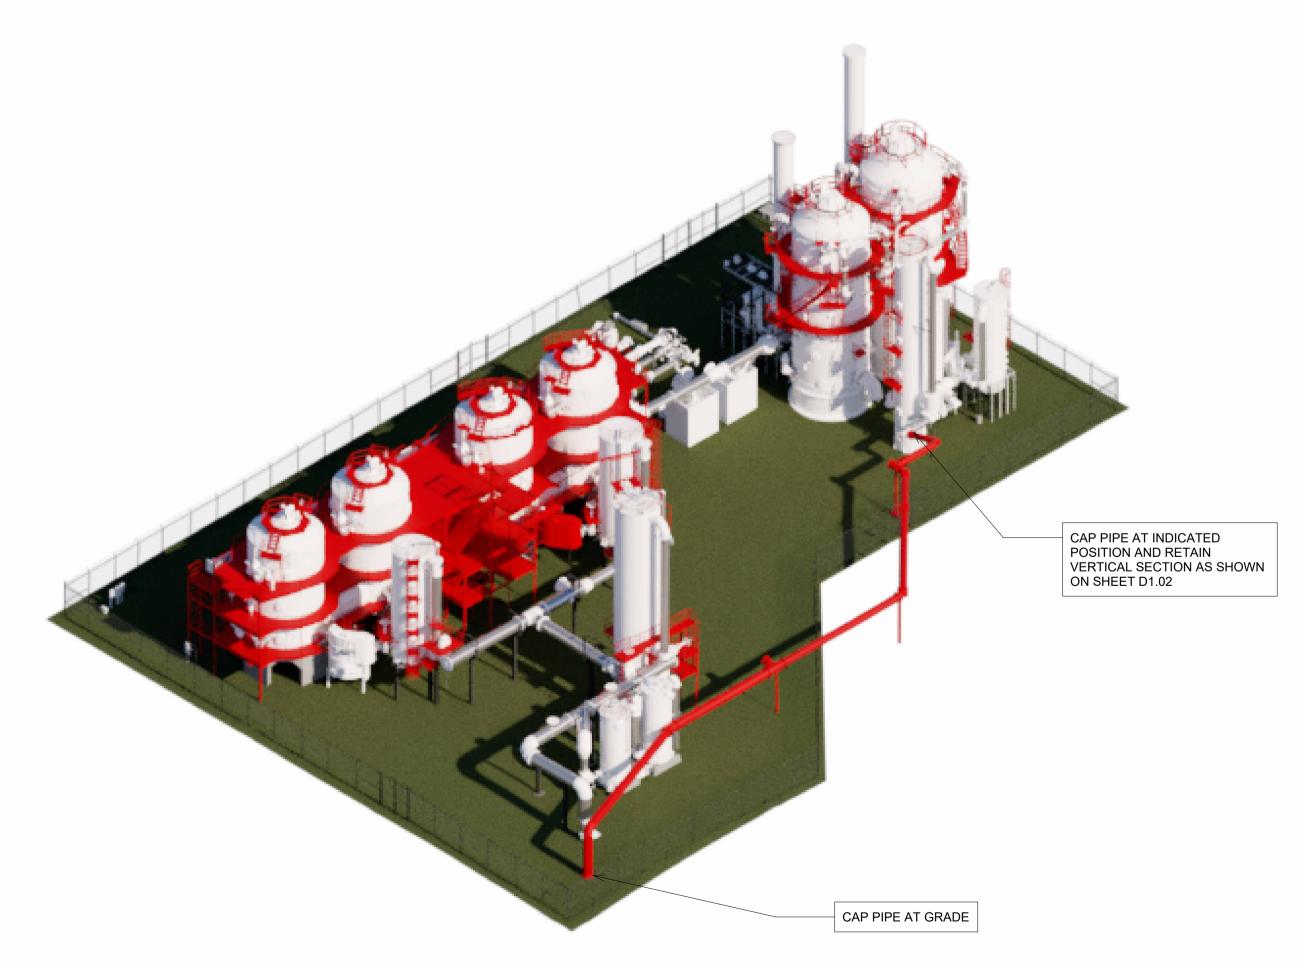

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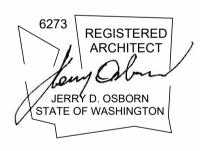
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FAS PURCHASING AND CONTRACTING DIRECTOR

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**GAS WORKS PARK** 

**EMERGENCY DEMOLITION** 

# DECONSTRUCTION PERSPECTIVE RENDERINGS

 PERSPECTIVE RENDERINGS

 DESIGNED \_\_Author \_\_DATE \_\_08/07/25


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10001 14.40.00 1 SW PERSPECTIVE NTS



1. DECONSTRUCTION SHOWN ON THIS PLAN DOES NOT REPRESENT THE COMPLETE SCOPE OF DECONSTRUCTION REQUIREMENTS.


> APPROVED FOR ADVERTISING: FAS PURCHASING AND CONTRACTING DIRECTOR

Director, Purchasing & Contracting

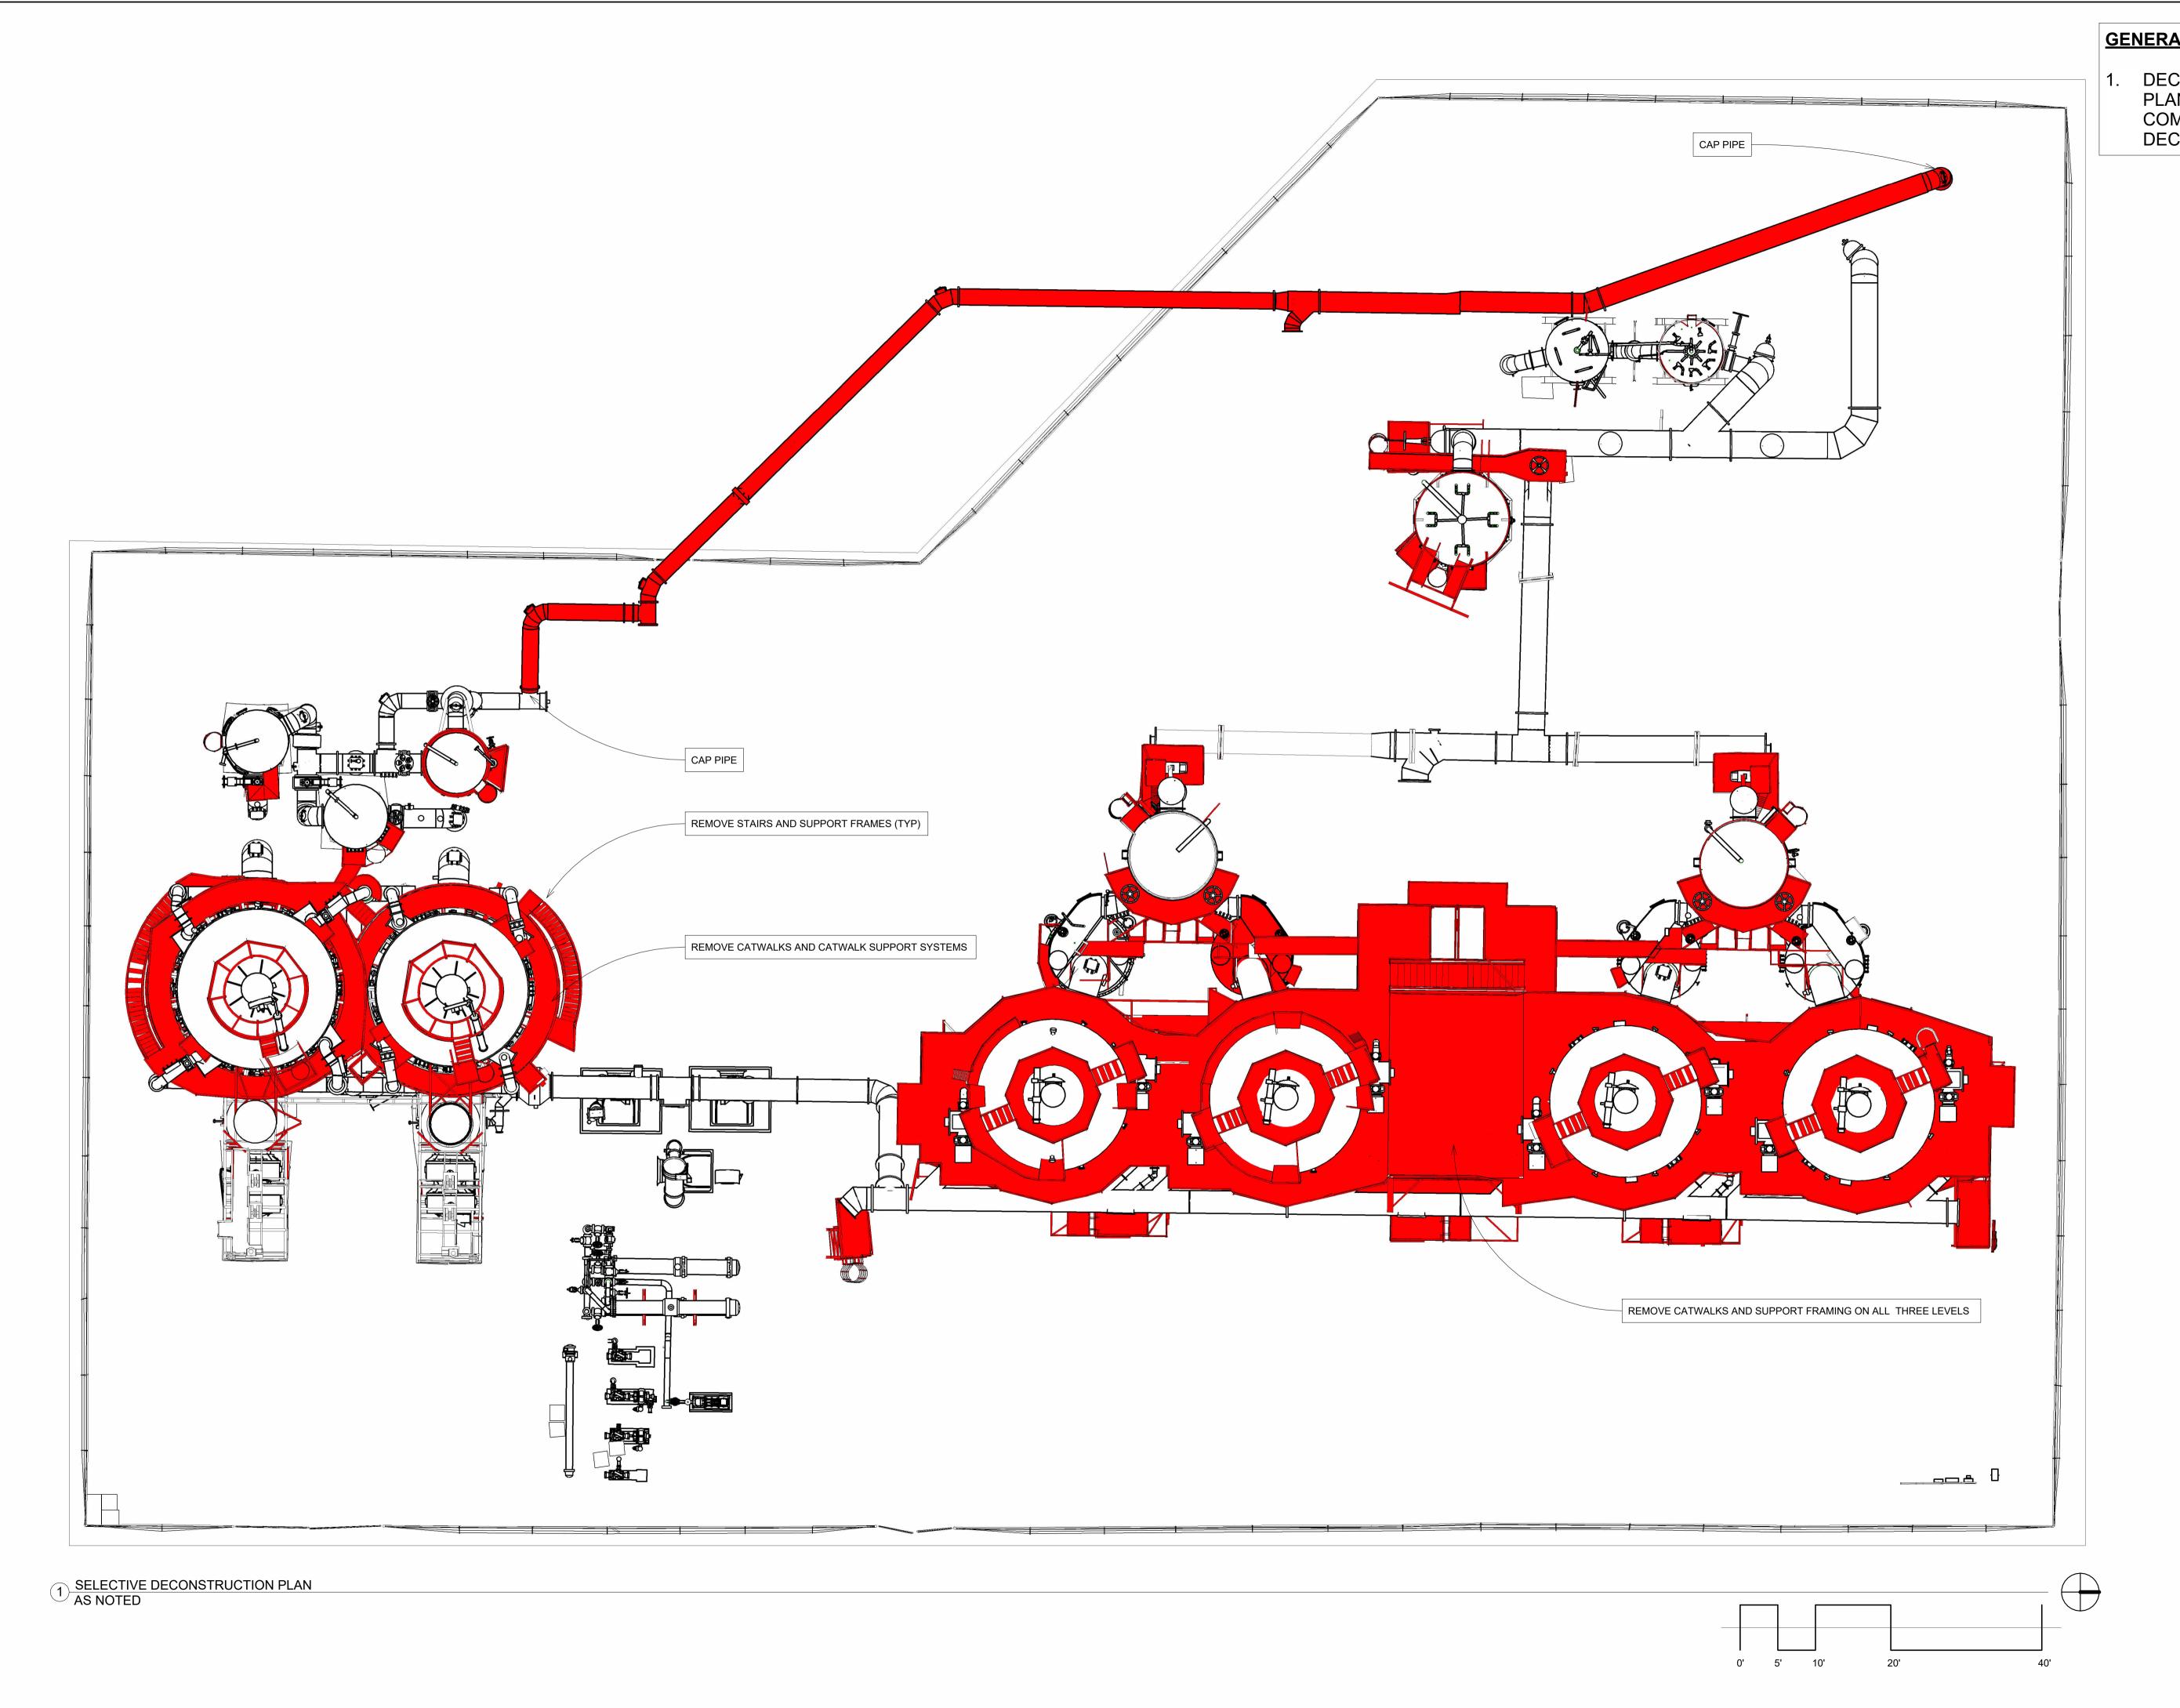DATE NO. **REVISION - AS BUILT** 

REVIEWED:

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**GAS WORKS PARK** 

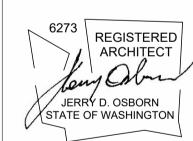**EMERGENCY DEMOLITION** 


SELECTIVE DECONSTRUCTION PLAN

DATE 08/07/25 DESIGNED Author DRAWN \_\_\_\_\_Designer\_ CHECKED Checker SHEET \_\_\_\_ OF \_\_\_

D1.02 ORDINANCE NO.

CONTRACT NO. SCALE AS NOTED (U.N.O.)

- DEMOLISH (E) PIPING
- 2. DEMOLISH (E) RAILING
- DEMOLISH (E) CATWALKS
- 4. DEMOLISH (E) CATWALK SUPPORT STRUCTURE
- 5. DEMOLISH (E) LADDER ASSEMBLY AND SUPPORT SYSTEM
- 6. DEMOLISH (E) PIPE SUPPORTS CUT OFF FLUSH WITH GRADE

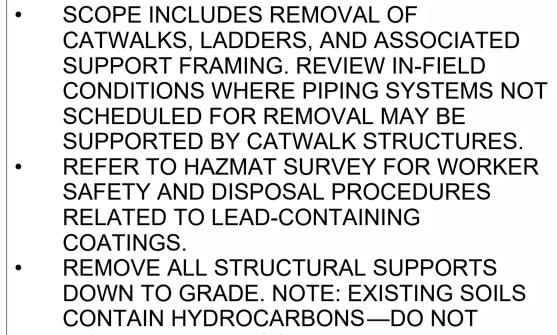

REMOVE ALL ELEMENTS INDICATED IN

APPLY "CORROSIONX HD" CORROSION-

INHIBITING COATING (OR APPROVED

THAT HAS BÉEN CUT OR TORCHED.

CAP EXISTING PIPE AT CUT/TORCH

CORROSION-INHIBITING COATING.

EQUIVALENT) TO ALL EXPOSED STEEL


LOCATIONS USING A 1/2" STEEL PLATE,

FIELD-WELDED TO THE PIPE END. PAINT


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**GENERAL NOTES** 

RED.

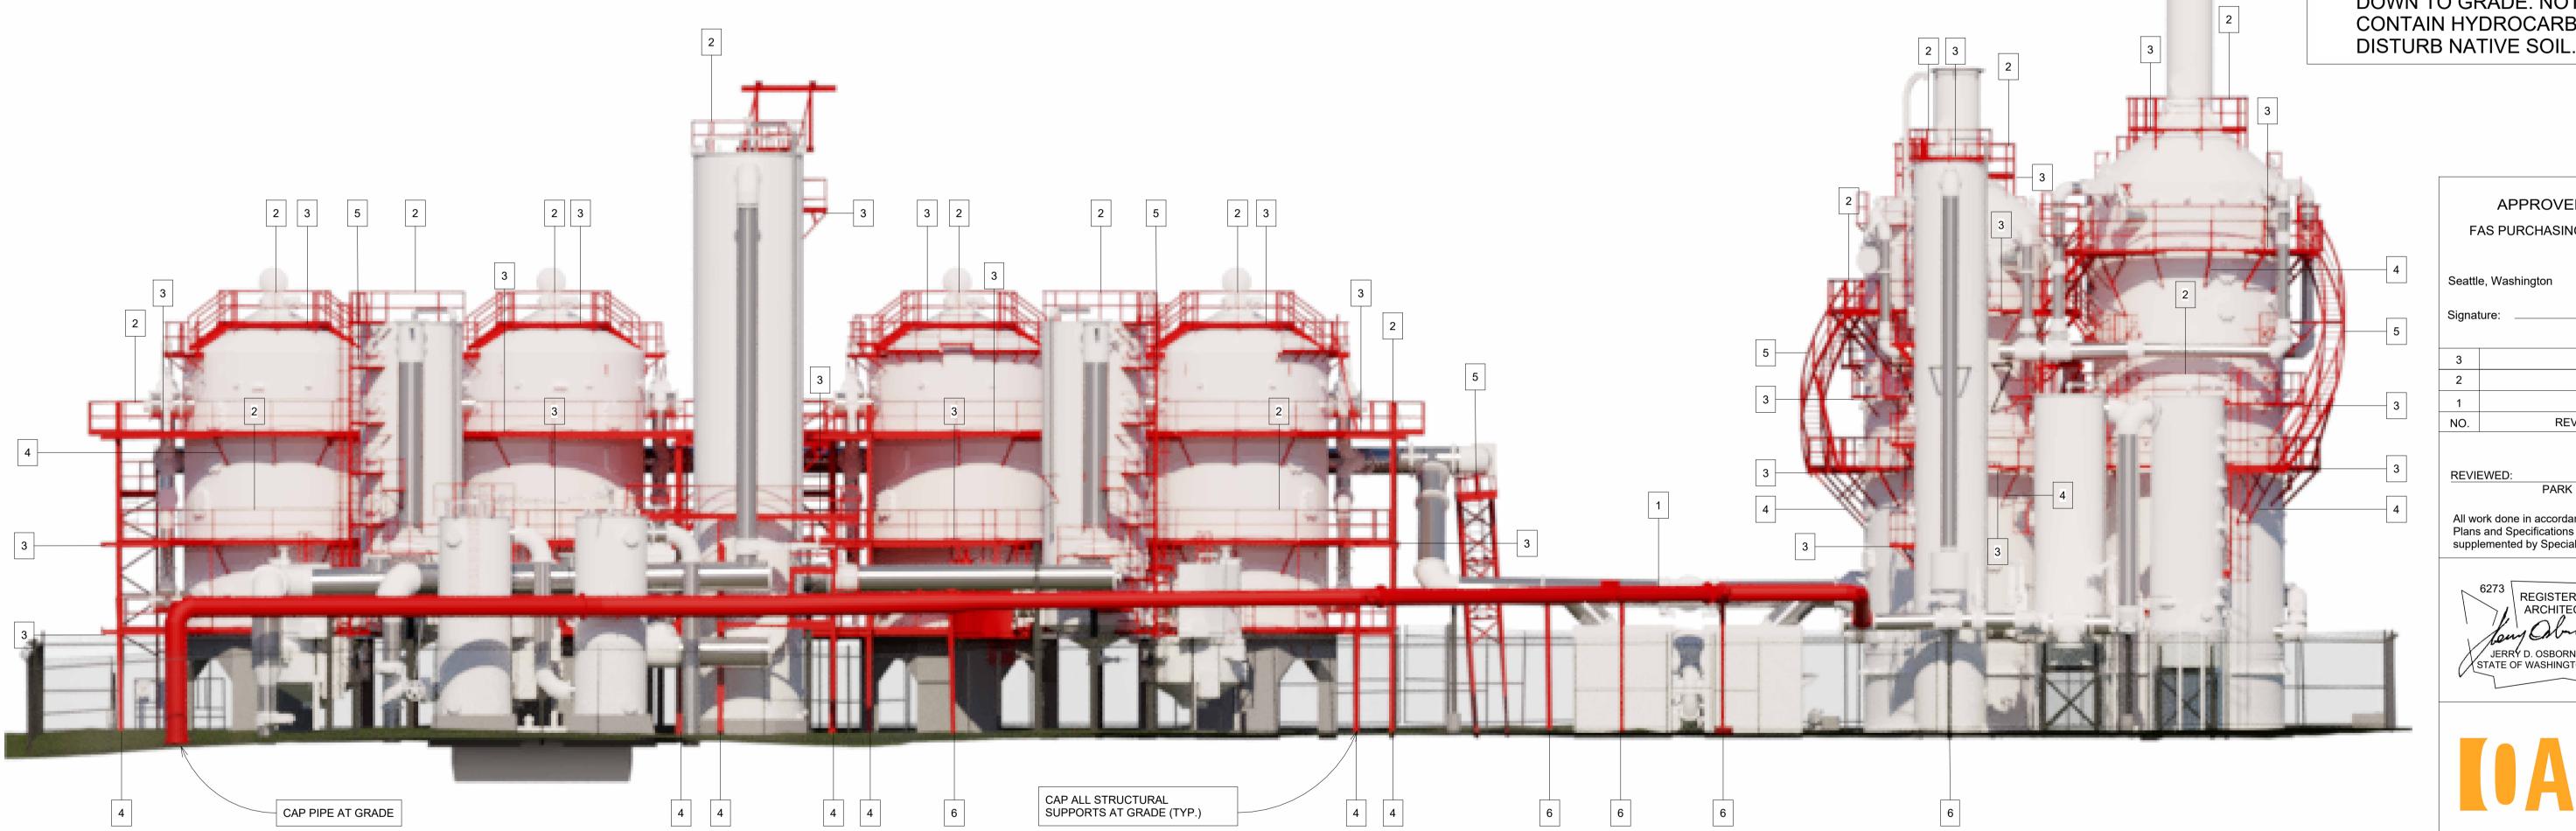

WEST DECONSTRUCTION ELEVATION <sup>¹</sup>∕ AS NOTED

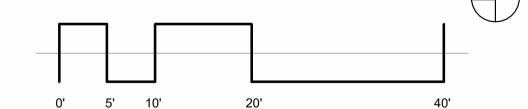


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Director, Purchasing & Contracting 2 NO. **REVISION - AS BUILT** DATE

REVIEWED: PARK ENGINEER

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**GAS WORKS PARK** 

**EMERGENCY DEMOLITION** 

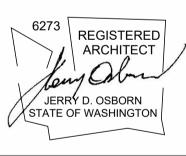WEST DECONSTRUCTION **ELEVATION** 

D1.03

DATE DESIGNED \_\_\_Author 08/07/25 DRAWN Designer SHEET \_\_\_\_ OF \_\_\_ CHECKED \_\_\_\_Checker\_

ORDINANCE NO. CONTRACT NO.


- DEMOLISH (E) PIPING
- 2. DEMOLISH (E) RAILING
- DEMOLISH (E) CATWALKS
- 4. DEMOLISH (E) CATWALK SUPPORT STRUCTURE
- 5. DEMOLISH (E) LADDER ASSEMBLY AND SUPPORT SYSTEM
- 6. DEMOLISH (E) PIPE SUPPORTS CUT OFF FLUSH WITH GRADE

#### **GENERAL NOTES**

- REMOVE ALL ELEMENTS INDICATED IN
- APPLY "CORROSIONX HD" CORROSION-INHIBITING COATING (OR APPROVED EQUIVALENT) TO ALL EXPOSED STEEL THAT HAS BÉEN CUT OR TORCHED.
- CAP EXISTING PIPE AT CUT/TORCH LOCATIONS USING A 1/2" STEEL PLATE, FIELD-WELDED TO THE PIPE END. PAINT THE CAP AND WELDS WITH THE SPECIFIED CORROSION-INHIBITING COATING.
- SCOPE INCLUDES REMOVAL OF CATWALKS, LADDERS, AND ASSOCIATED SUPPORT FRAMING. REVIEW IN-FIELD CONDITIONS WHERE PIPING SYSTEMS NOT SCHEDULED FOR REMOVAL MAY BE SUPPORTED BY CATWALK STRUCTURES.
- REFER TO HAZMAT SURVEY FOR WORKER SAFETY AND DISPOSAL PROCEDURES RELATED TO LEAD-CONTAINING COATINGS.
- REMOVE ALL STRUCTURAL SUPPORTS DOWN TO GRADE. NOTE: EXISTING SOILS CONTAIN HYDROCARBONS—DO NOT DISTURB NATIVE SOIL.



NORTH DECONSTRUCTION ELEVATION 

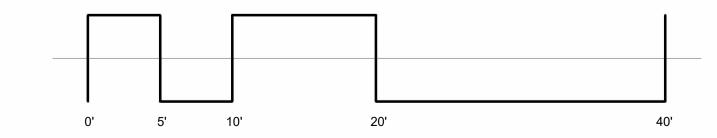


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**GAS WORKS PARK** 

D1.04

**EMERGENCY DEMOLITION** 

## NORTH DECONSTRUCTION

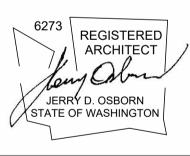**ELEVATION** DATE 08/07/25 DESIGNED \_ Designer

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- DEMOLISH (E) PIPING
- 2. DEMOLISH (E) RAILING
- DEMOLISH (E) CATWALKS
- 4. DEMOLISH (E) CATWALK SUPPORT STRUCTURE
- 5. DEMOLISH (E) LADDER ASSEMBLY AND SUPPORT SYSTEM
- 6. DEMOLISH (E) PIPE SUPPORTS CUT OFF FLUSH WITH GRADE

#### **GENERAL NOTES**

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DATE

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**GAS WORKS PARK** 

**EMERGENCY DEMOLITION** 

#### SOUTH DECONSTRUCTION **ELEVATION**

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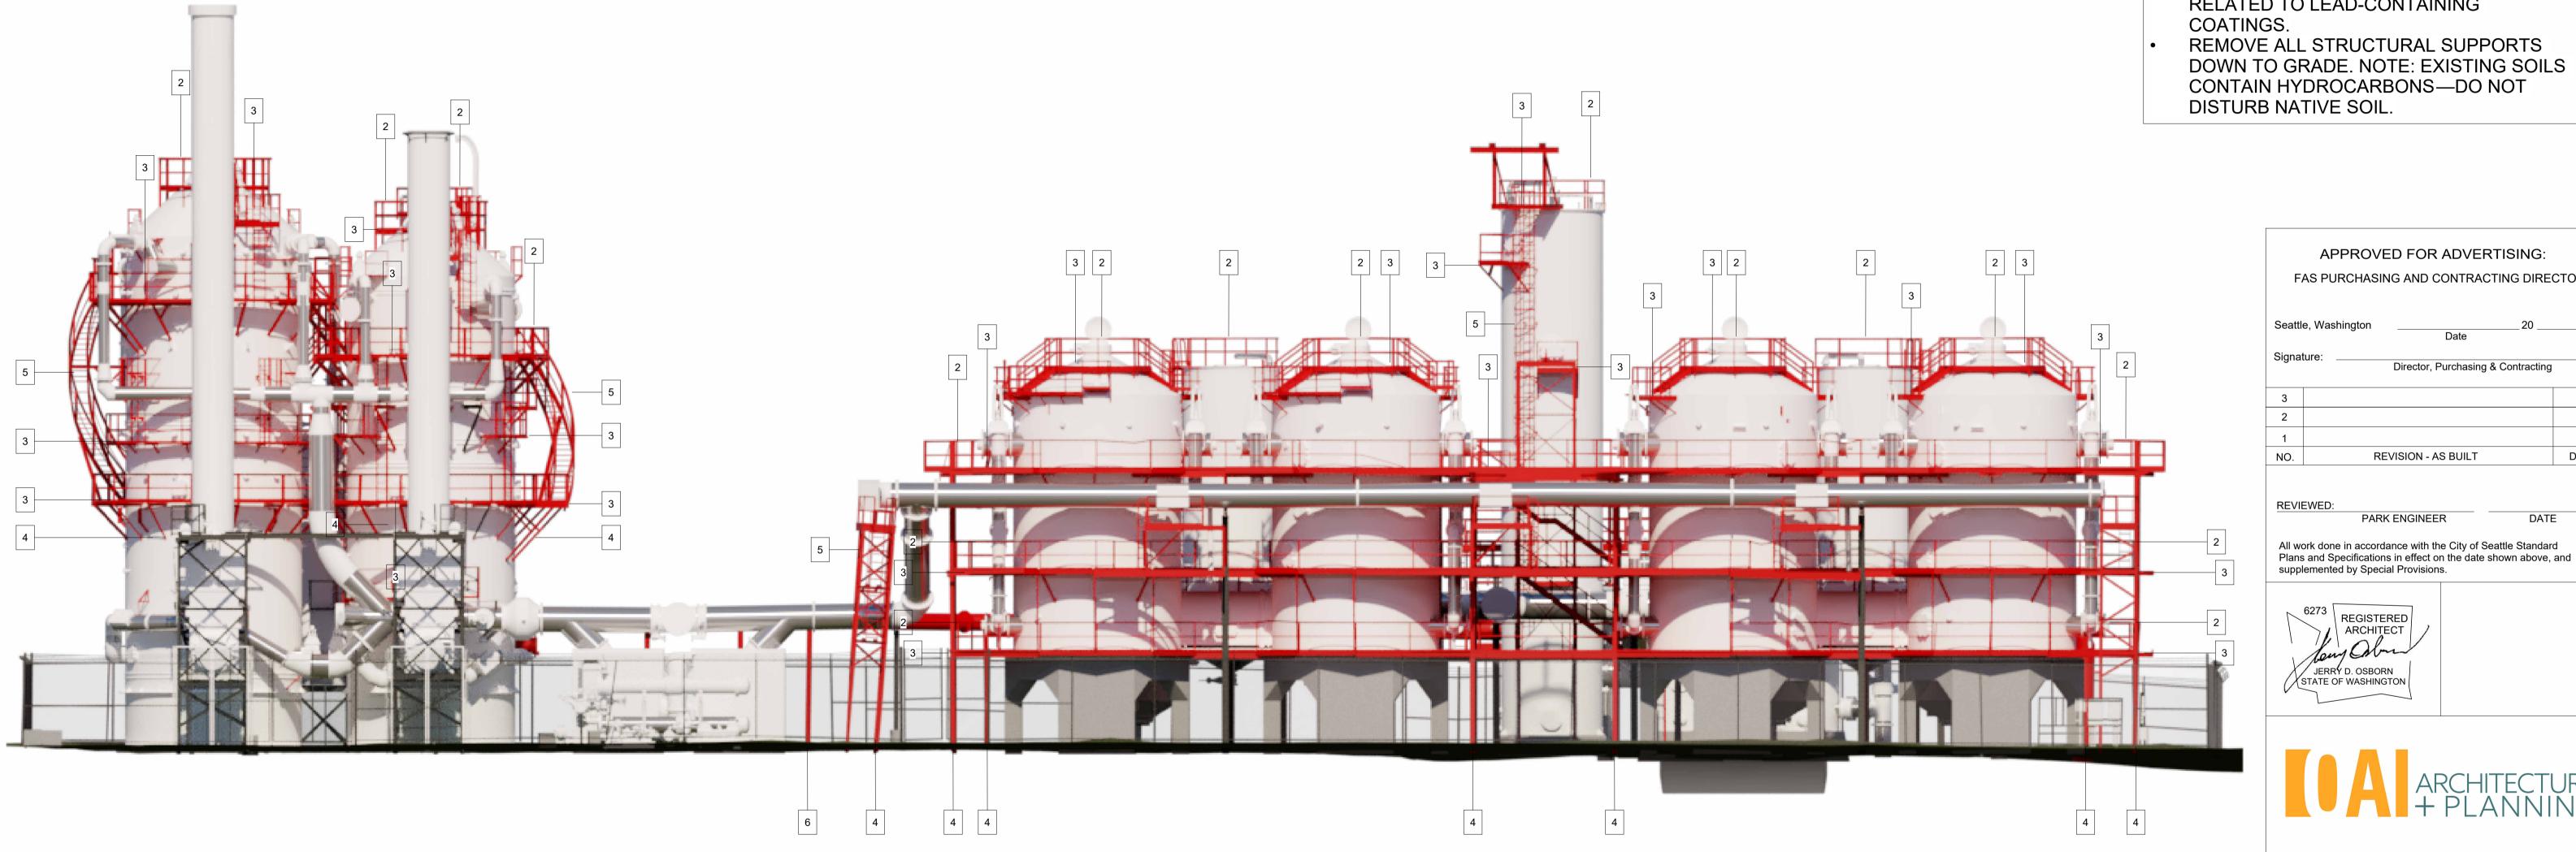


2 SOUTH DECONSTRUCTION ELEVATION AS NOTED


- DEMOLISH (E) PIPING
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- DEMOLISH (E) CATWALKS
- 4. DEMOLISH (E) CATWALK SUPPORT STRUCTURE
- 5. DEMOLISH (E) LADDER ASSEMBLY AND SUPPORT SYSTEM
- 6. DEMOLISH (E) PIPE SUPPORTS CUT OFF FLUSH WITH GRADE

#### **GENERAL NOTES**

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  - CAP EXISTING PIPE AT CUT/TORCH LOCATIONS USING A 1/2" STEEL PLATE, FIELD-WELDED TO THE PIPE END. PAINT THE CAP AND WELDS WITH THE SPECIFIED CORROSION-INHIBITING COATING.
- SCOPE INCLUDES REMOVAL OF CATWALKS, LADDERS, AND ASSOCIATED SUPPORT FRAMING. REVIEW IN-FIELD CONDITIONS WHERE PIPING SYSTEMS NOT SCHEDULED FOR REMOVAL MAY BE SUPPORTED BY CATWALK STRUCTURES.
- REFER TO HAZMAT SURVEY FOR WORKER SAFETY AND DISPOSAL PROCEDURES RELATED TO LEAD-CONTAINING
- REMOVE ALL STRUCTURAL SUPPORTS DOWN TO GRADE. NOTE: EXISTING SOILS CONTAIN HYDROCARBONS—DO NOT DISTURB NATIVE SOIL.



2 EAST DECONSTRUCTION ELEVATION AS NOTED

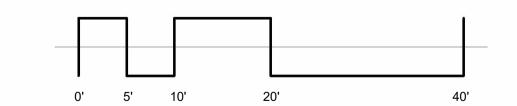

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REVIEWED: PARK ENGINEER

**REVISION - AS BUILT** 

DATE

JERRY D. OSBORN STATE OF WASHINGTON



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**GAS WORKS PARK** 

**EMERGENCY DEMOLITION** 

**EAST DECONSTRUCTION ELEVATION** 

DESIGNED Author DRAWN Designer CHECKED Checker

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08/07/25


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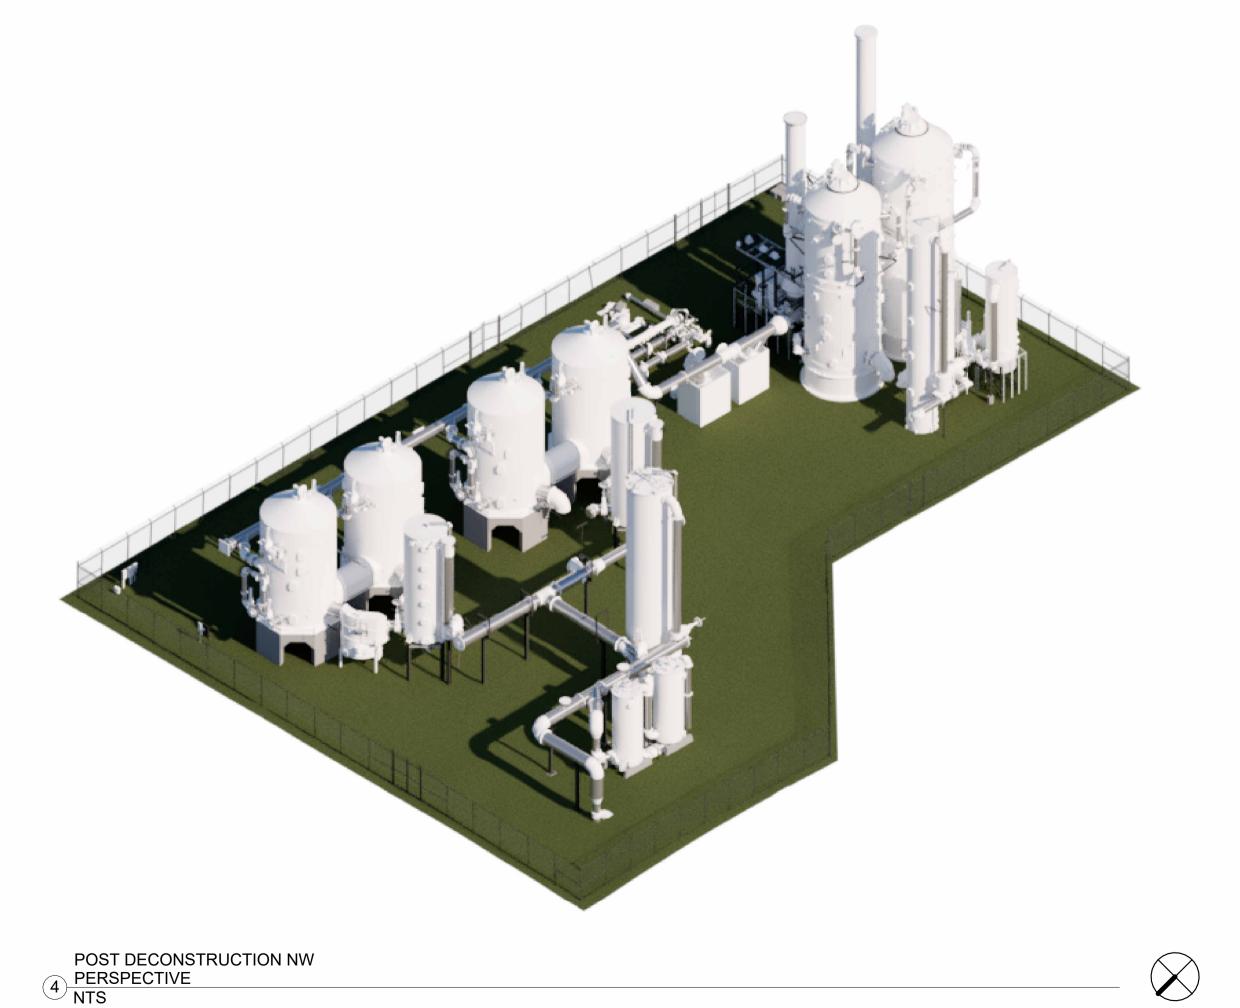






POST DECONSTRUCTION NE
PERSPECTIVE
NTS



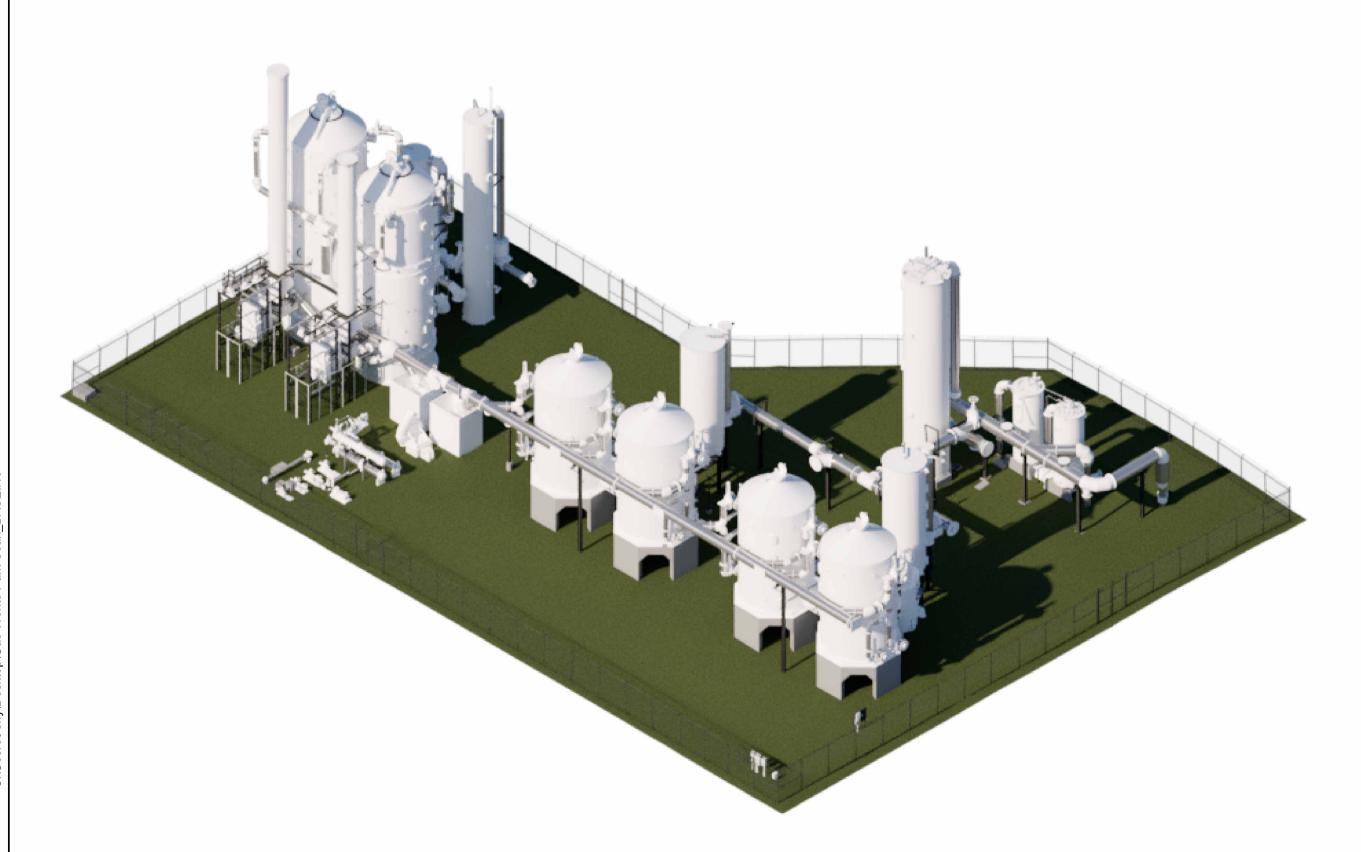


#### **GENERAL NOTES**

- ITEMS RENDERED IN RED ARE SELECTED FOR REMOVAL AND DISPOSAL (TYP.)
- CUT-OFF VERTICAL FRAMING AT GROUND LEVEL
  - SOIL DISTURBANCE IS EXCLUDED FROM THIS PROJECT.
- CAPPING OF UTILITY PIPING IS INCLUDED IN THE SCOPE OF THIS PROJECT.

APPROVED FOR ADVERTISING: FAS PURCHASING AND CONTRACTING DIRECTOR

Director, Purchasing & Contracting DATE **REVISION - AS BUILT** 

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**GAS WORKS PARK** 

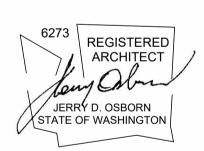**EMERGENCY DEMOLITION** 

POST DECONSTRUCTION PERSPECTIVE RENDERINGS

DATE 08/07/25 DESIGNED <u>Author</u> Designer CHECKED Checker SHEET \_\_\_\_ OF \_\_\_


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D1.07 (U.N.O.) SCALE NTS

- SCOPE INCLUDES REMOVAL OF CATWALKS, LADDERS, AND ASSOCIATED SUPPORT FRAMING. REVIEW IN-FIELD CONDITIONS WHERE PIPING SYSTEMS NOT SCHEDULED FOR REMOVAL MAY BE SUPPORTED BY CATWALK STRUCTURES.
- REFER TO HAZMAT SURVEY FOR WORKER SAFETY AND DISPOSAL PROCEDURES RELATED TO LEAD-CONTAINING COATINGS.
- REMOVE ALL STRUCTURAL SUPPORTS DOWN TO GRADE. NOTE: EXISTING SOILS CONTAIN HYDROCARBONS—DO NOT DISTURB NATIVE SOIL.



POST DECONSTRUCTION WEST 1 ELEVATION AS NOTED

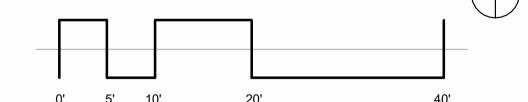


APPROVED FOR ADVERTISING: FAS PURCHASING AND CONTRACTING DIRECTOR

Director, Purchasing & Contracting 2 NO. **REVISION - AS BUILT** DATE

REVIEWED:

All work done in accordance with the City of Seattle Standard Plans and Specifications in effect on the date shown above, and supplemented by Special Provisions.

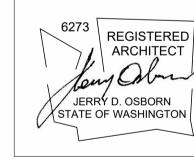



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**GAS WORKS PARK** 

**EMERGENCY DEMOLITION** 

POST DECONSTRUCTION WEST **ELEVATION** 

DESIGNED \_\_\_Author DATE 08/07/25 DRAWN Designer CHECKED Checker SHEET \_\_\_\_ OF \_\_\_

ORDINANCE NO. CONTRACT NO.


- SCOPE INCLUDES REMOVAL OF
   CATWALKS, LADDERS, AND ASSOCIATED
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- REFER TO HAZMAT SURVEY FOR WORKER SAFETY AND DISPOSAL PROCEDURES RELATED TO LEAD-CONTAINING COATINGS.
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  DISTURB NATIVE SOIL.



POST DECONSTRUCTION NORTH

ELEVATION
AS NOTED

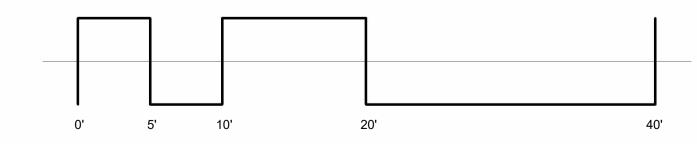

Signature:

Director, Purchasing & Contracting

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NO. REVISION - AS BUILT DATE

PARK ENGINEER DATE

All work done in accordance with the City of Seattle Standard

Plans and Specifications in effect on the date shown above, and

Plans and Specifications in effect on the date shown above, supplemented by Special Provisions.



REVIEWED:



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**EMERGENCY DEMOLITION** 

# POST DECONSTRUCTION NORTH ELEVATION

DESIGNED Author DATE 08/07/25
DRAWN Designer

CHECKED Checker SHEET OF OF ORDINANCE NO. D1.09

CONTRACT NO.

SCALE AS NOTED (U.N.O.)

9/11/2025 11:13:06 AM

- SCOPE INCLUDES REMOVAL OF
   CATWALKS, LADDERS, AND ASSOCIATED
   SUPPORT FRAMING. REVIEW IN-FIELD
   CONDITIONS WHERE PIPING SYSTEMS NOT
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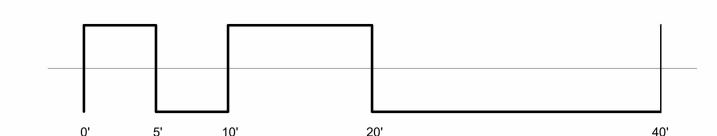
   PEEER TO HAZMAT SURVEY FOR WORKER.
- REFER TO HAZMAT SURVEY FOR WORKER SAFETY AND DISPOSAL PROCEDURES RELATED TO LEAD-CONTAINING COATINGS.
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POST DECONSTRUCTION SOUTH

ELEVATION

AS NOTED



APPROVED FOR ADVERTISING:
FAS PURCHASING AND CONTRACTING DIRECTOR


Date
Signature:

Director, Purchasing & Contracting

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NO. REVISION - AS BUILT DATE

REVIEWED:
PARK ENGINEER
DATE

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ARCHITECTURI + PLANNING
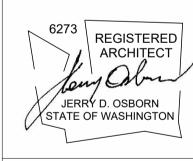
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**GAS WORKS PARK** 

**EMERGENCY DEMOLITION** 

# POST DECONSTRUCTION SOUTH ELEVATION


 SOUTH ELEVATION

 DESIGNED Author DRAWN Designer CHECKED Checker
 DATE 08/07/25


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ORDINANCE NO. \_\_\_\_\_ D1.10

- SCOPE INCLUDES REMOVAL OF CATWALKS, LADDERS, AND ASSOCIATED SUPPORT FRAMING. REVIEW IN-FIELD CONDITIONS WHERE PIPING SYSTEMS NOT SCHEDULED FOR REMOVAL MAY BE SUPPORTED BY CATWALK STRUCTURES. REFER TO HAZMAT SURVEY FOR WORKER
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POST DECONSTRUCTION EAST 2 ELEVATION AS NOTED

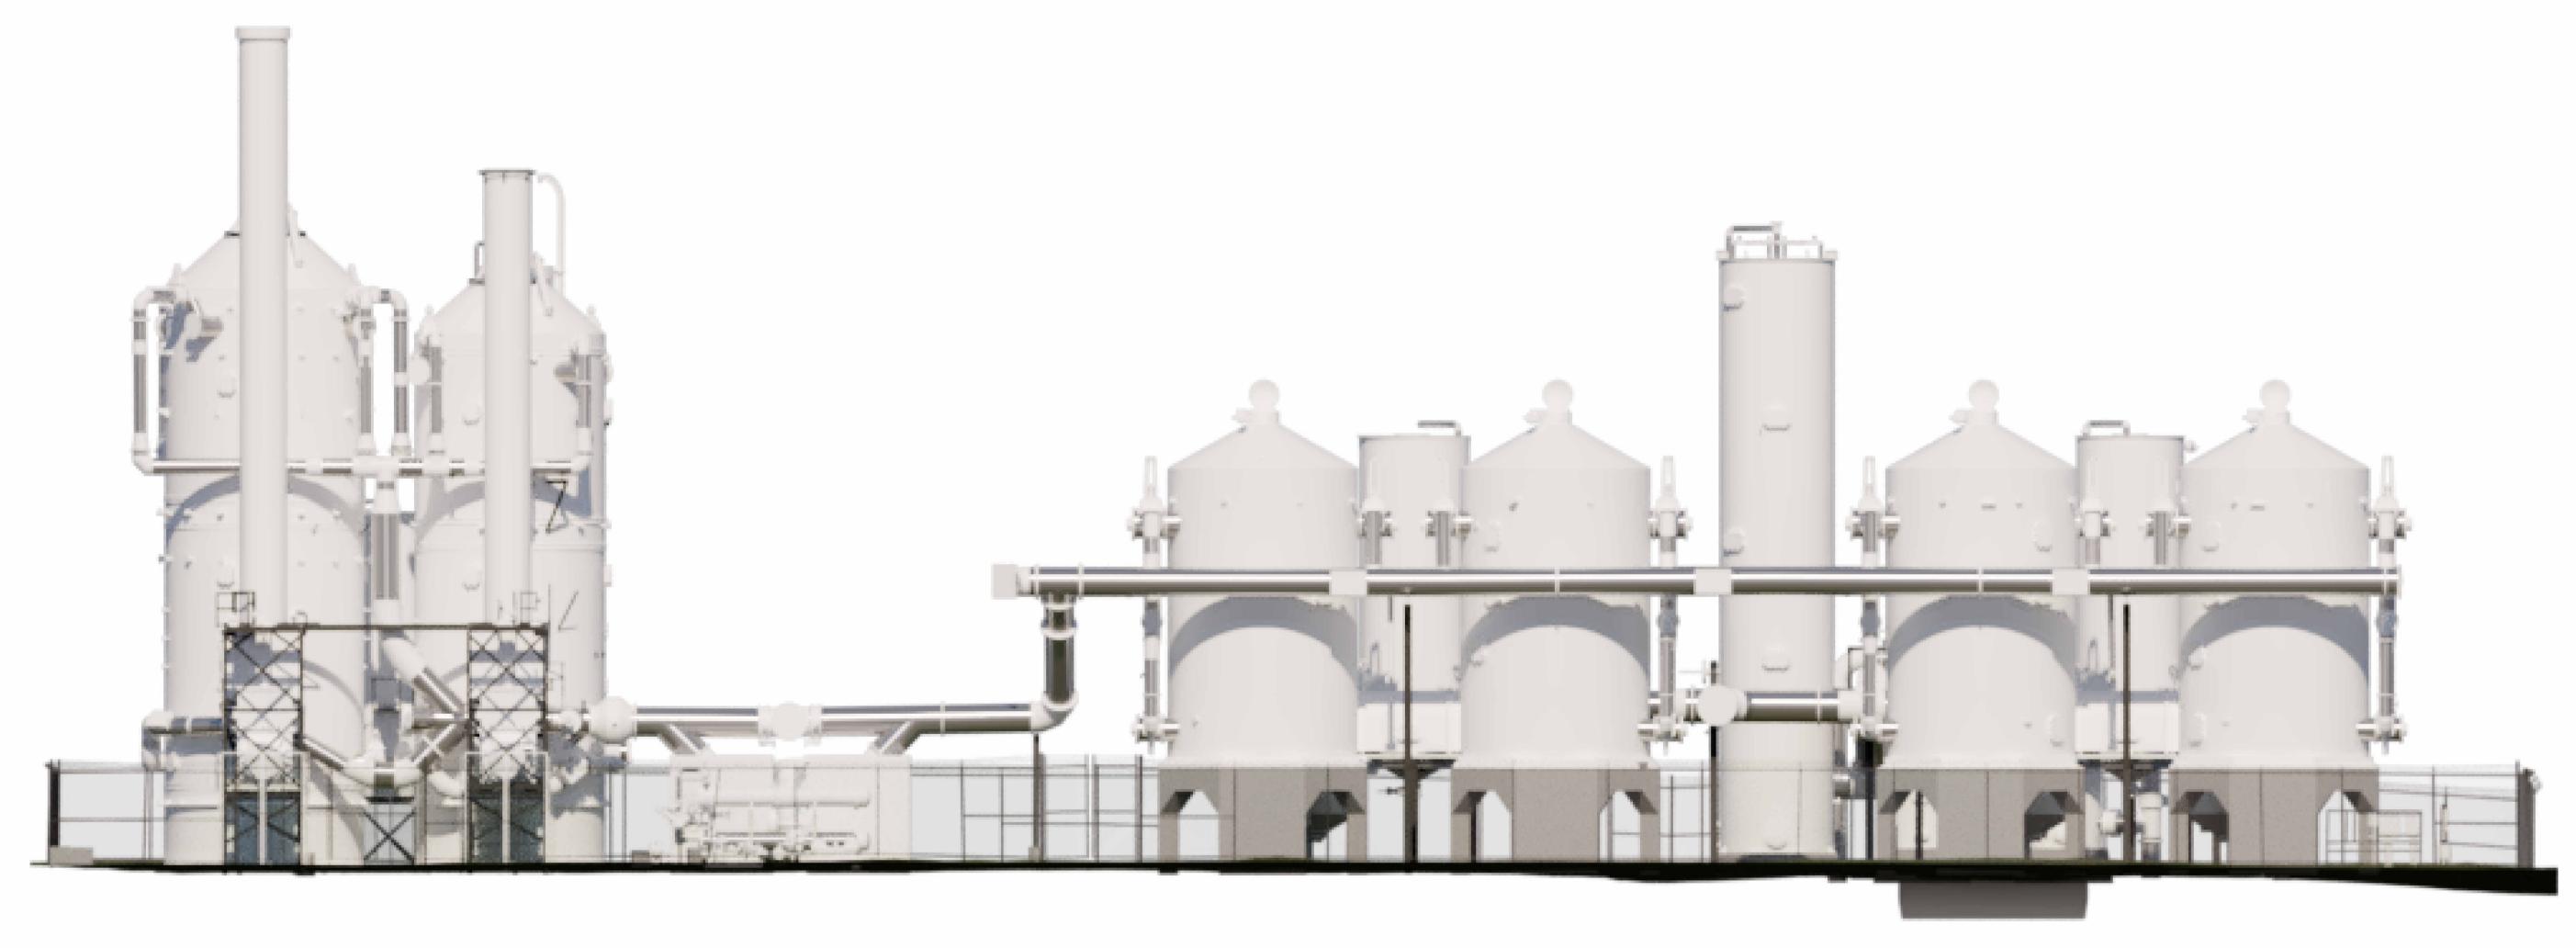

APPROVED FOR ADVERTISING: FAS PURCHASING AND CONTRACTING DIRECTOR


Director, Purchasing & Contracting

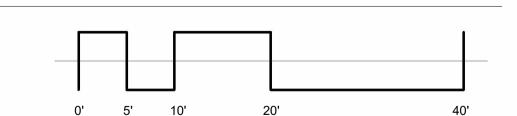DATE

NO. **REVISION - AS BUILT** 

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D1.11

#### POST DECONSTRUCTION EAST **ELEVATION**

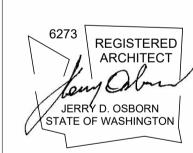DATE 08/07/25 DESIGNED \_\_\_Author DRAWN Designer CHECKED Checker SHEET \_\_\_\_ OF \_\_\_

ORDINANCE NO. CONTRACT NO.