Gas Works Park - Cracking Tower Work/Repairs

September 9, 2025

Introduction

As requested by Landmarks Board staff, below is a brief overview describing work by SPR on the fence surrounding the Cracking Towers at Gas Works Park and other actions to deter climbing of the towers. This is cursory and not intended to be a thorough history of the site. The timelines are approximate and based off memory.

Background

The fence around the Cracking Towers is considered an Institutional Control as part of the Consent Decree for the upland cleanup work and maintenance and improvement, if necessary, of the fence is required. Pursuant to the Consent Decree, Seattle Parks & Recreation (SPR) Staff inspect the soil cover and fence on a regular (approximately weekly) basis, needed repairs are typically handled through SPR's work order system, minor work that can be done by the grounds crew in the regular course of their activities at the park may not generate a work order. In addition, the Northeast District maintenance staff are at the park on a daily basis and also call-in work orders if they see issues with the fence or gates.

Timeline (approximate)

June 26, 2015 – Landmarks Preservation Board (LPB) – Architectural Review Committee (ARC) briefing to discuss removing some or all of the stairs and landings to deter climbing of the south towers. ARC suggested starting with more focused removals of obvious access points.

2016 - SPR hires PSM Consulting Engineers to undertake a Climbing and Safety Evaluation of Towers 1 & 2 (southerly large towers).

August 7, 2019 – LPB issues Certificate of Approval (CoA) to allow SPR to perform selective removal of climbable features and undertake limited alterations to Towers 1 & 2 to deter climbing.

2019-2023 – SPR Metal Shop Crew undertakes approved work on Towers 1 & 2. Ongoing repairs were also being made to the fence and gates intermittently, as it was cut or otherwise manipulated/vandalized, ostensibly to gain access into the restricted area.

2023 – SPR hired All City Fence to do a complete restoration of the chain-link fence, restore the barbed wire on top of the fence, add steel mesh panels over the chain-link and reconstruct the gates with the steel mesh to resist cutting and strengthen the gates.

2023 – SPR hired a landscape contractor to remove all vegetation and trees that were growing around and amongst the towers to make the area more open and remove potential access point(s) to the towers. Note that SPR crews have been and continue to remove blackberries and mow the lawn areas around the towers within the Cracking Tower fenced area. They generally avoid working directly under the towers due to safety concerns/potential falling metal.

2024 – A leaning support element within the Cracking Tower area, between the North and South Towers, was removed with a CoA from LPB issued on June 26, 2024

2023-2025 – SPR facilities continues to address access points; 3 of the 4 gates have been welded shut; area(s) under the gates have been paved to strengthen the gates and limit the possibility of digging under a gate.

Incidents

The following is a list of incidents at the Cracking Towers since 2008. This list is based on aid calls that Seattle Fire Department (SFD) responded to and has been provided by SFD:

Date and	Victim Details	Description	Outcome
Time			
10/11/2008	Male, age 22	Climbed fenced-off structure; catwalk gave way, fell onto another catwalk.	Non-life-threatening (possible dislocated shoulder)
0400 hours			·
12/13/2009	Female	Fell off structure.	Life-threatening
0023 hours	(age 25)		injuries; survived
5/25/2012	Male, age 19	Fell off towers. Was visiting Seattle from Massachusetts.	Death
0010 hours			
3/29/2013	Male	Fell off structure; unconscious with liver and head injuries.	Life-threatening injuries; survived
0517 hours	(age 19)		
7/19/2014	Female, 19	Fell 35 feet while writing graffiti.	Multiple broken bones; survived
0322 hours		0.2	33

Date and Time	Victim Details	Description	Outcome	
1/25/2015	Male	Fell off structure.	Life-threatening head and internal injuries;	
0033 hours	(age 21)		survived	
2/1/2015	Male	Fell off structure but remained	Injuries; transported to	
2210 hours	(age 19)	conscious.	HMC	
12/11/2016	Male	Fell off structure while intoxicated after he missed a hole in catwalk; rescued by	Open femur fracture, possible pelvic fracture, etc.; survived	
2213 hours	(age 23)	SFD.		
1/1/2019	Male	Climbed while intoxicated; fell.	Significant injuries;	
2213 hours	(age 40)		survived	
2/21/2022	Male	Fell off structure; rescued by	Broken leg, head laceration; survived	
0117 hours	(age 26)	SFD.		
9/17/2022	Female	Fell through an opening in the walkway while climbing with friends on the south towers. They had all been drinking.	Death	
0242 hours	(age 20)			
	Only known female victim.			
11/23/2023	Male	Fell off refinery; unconscious,	Survived with brain damage.	
0030 hours	(age 16)	no pulse.		
3/29/2024	Male	Fell 60 feet; walking and	Injuries; treated at HMC	
2318 hours	(age 19)	talking.		
7/10/2025	Male	Fell off towers after a classical music concert in the park.	Death	
2230 hours	(age 15)			

Gas Works Park Cracking Towers Tower Photographs

David Graves, Strategic Advisor | September 10, 2025























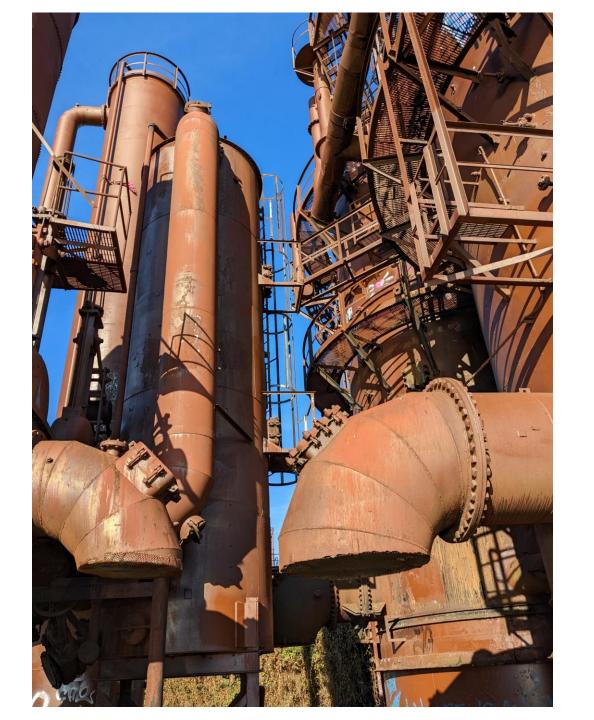

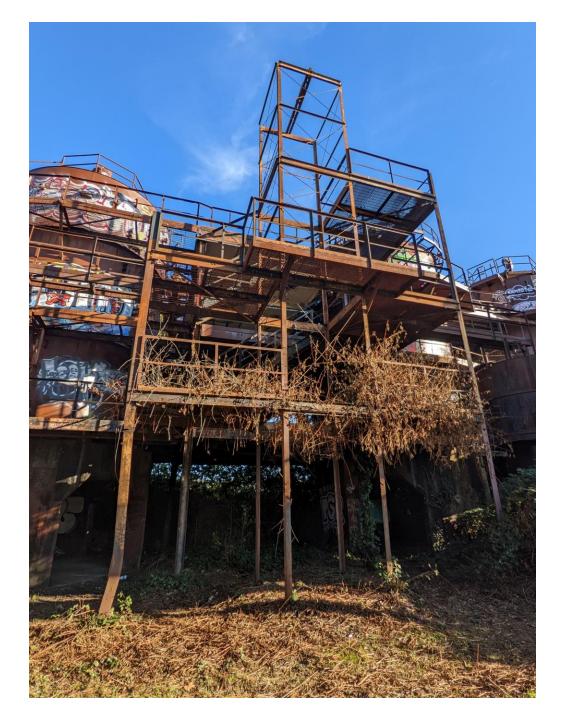









GAS WORKS PARK "CRACKING TOWERS": EMERGENCY SELECTIVE DECONSTRUCTION

1901 N NORTHLAKE WAY 98103



VICINITY MAP

GAS WORKS PARK - NOT TO SCALE

PROJECT TEAM

OWNER

SEATTLE PARKS AND RECREATIONS 100 DEXTER AVE N, SEATTLE, WA, 98109

CONTACT: MIKE SCHWINDELLER

PHONE: 206.615.1165

EMAIL:

MIKE.SCHWINDELLER@SEATTLE.GOV

ARCHITECT

OSBORN ARCHITECTS INC., PS (OAI) 1001 SW KLICKITAT WAY, STE 204 SEATTLE, WA 98134

CONTACT: JERRY OSBORN PHONE: 206.920.6348

EMAIL: JOSBORN@OAIPS.COM

HAZMAT CONSULTANT

CONTACT: RYAN HUNTER PHONE: 484.269.2138

EMAIL: RYAN.HUNTER@PBSUSA.COM

SITE INFORMATION

PROPERTY ADDRESS: 1901 N NORTHLAKE

WAY 98103

OWNER: SEATTLE PARKS AND RECREATION

ZONING: UI U/45

PARCEL NUMBER:124970-0005

SCOPE OF WORK


SELECTIVE REMOVAL OF PIPING, CATWALKS, LADDERS AND SUPPORT SYSTEMS FROM TOWER STRUCTURES LOCATED WITHIN GAS WORKS PARK.
EMERGENCY SECURITY LIGHTING SYSTEMS.

SHEET LIST

G1.00	COVER SHEET
D1.01	DECONSTRUCTION PERSPECTIVE RENDERINGS
D1.02	SELECTIVE DECONSTRUCTION PLAN
D1.03	WEST DECONSTRUCTION ELEVATION
D1.04	NORTH DECONSTRUCTION ELEVATION
D1.05	SOUTH DECONSTRUCTION ELEVATION
D1.06	EAST DECONSTRUCTION ELEVATION

GENERAL NOTES

(E) PAINT COATINGS CONTAIN LEAD. REFER
TO HAZMAT SURVEY FOR WORKER SAFETY AND
DISPOSAL REQUIREMENTS.
 EXISTING SOILS ARE CONTAMINATED. NO SOIL
DISTURBANCE IS ANTICIPATED.
 (E) TANKS OR PIPING MAY CONTAIN
REMNANTS OF HYDROCARBONS. CONTRACTOR
RESPONSIBLE FOR CUTTING EQUIPMENT AND
TECHNIQUES EMPLOYED TO ENSURE WORKER
SAFETY.

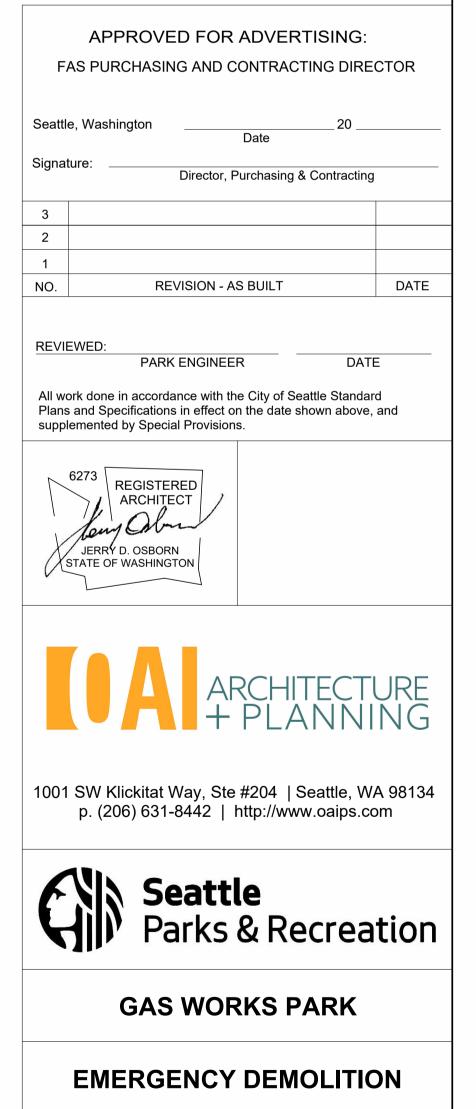

COVER SHEET

CHECKED


ORDINANCE NO.

SCALE 1 1/2" = 1'-0" (U.N.O.)

SHEET ____ OF ___

G1.00

9/8/2025 3:58:58 PM

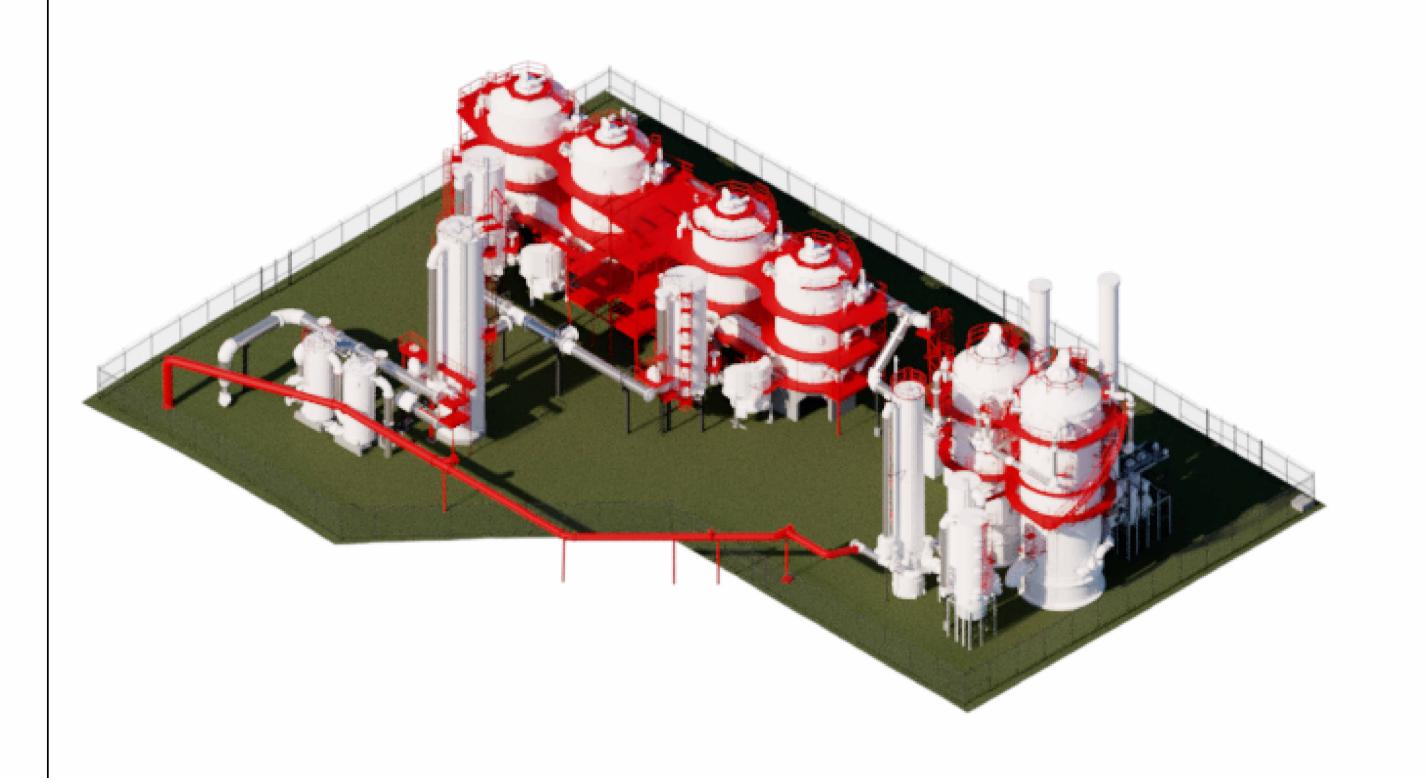




APPROVED FOR ADVERTISING: FAS PURCHASING AND CONTRACTING DIRECTOR

GENERAL NOTES

FROM THIS PROJECT.

Director, Purchasing & Contracting **REVISION - AS BUILT**

All work done in accordance with the City of Seattle Standard Plans and Specifications in effect on the date shown above, and supplemented by Special Provisions.

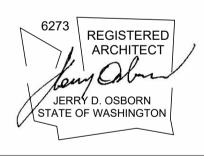

CAP PIPE AT INDICATED
POSITION AND RETAIN
VERTICAL SECTION AS SHOWN
ON SHEET D1.02



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GAS WORKS PARK

EMERGENCY DEMOLITION

DECONSTRUCTION

PER	SPECI	IVER	END	ERING
DESIGNED	Author		DATE	08/07/25
DRAWN	Designer			
CHECKED	Checker		SHEET	OF


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SCALE NTS

D1.01 ORDINANCE NO. CONTRACT NO.

2 SE PERSPECTIVE NTS




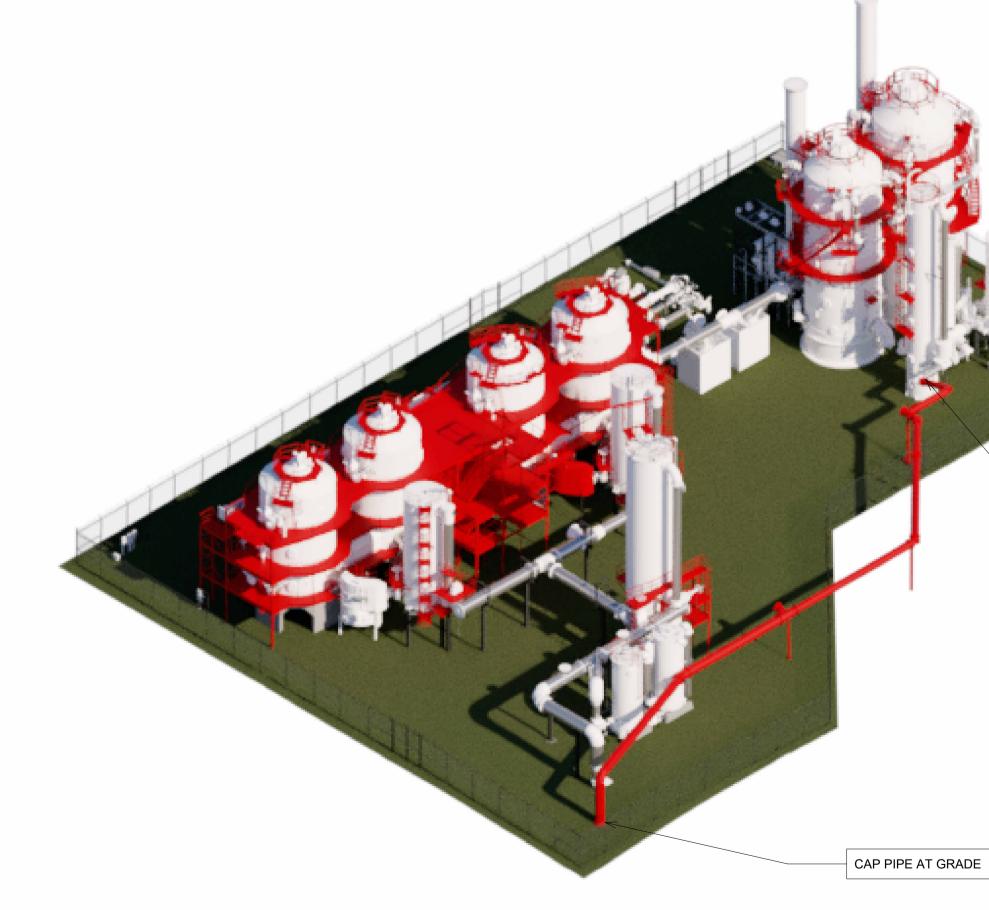

4 NW PERSPECTIVE NTS

3 NE PERSPECTIVE NTS

1 SW PERSPECTIVE NTS

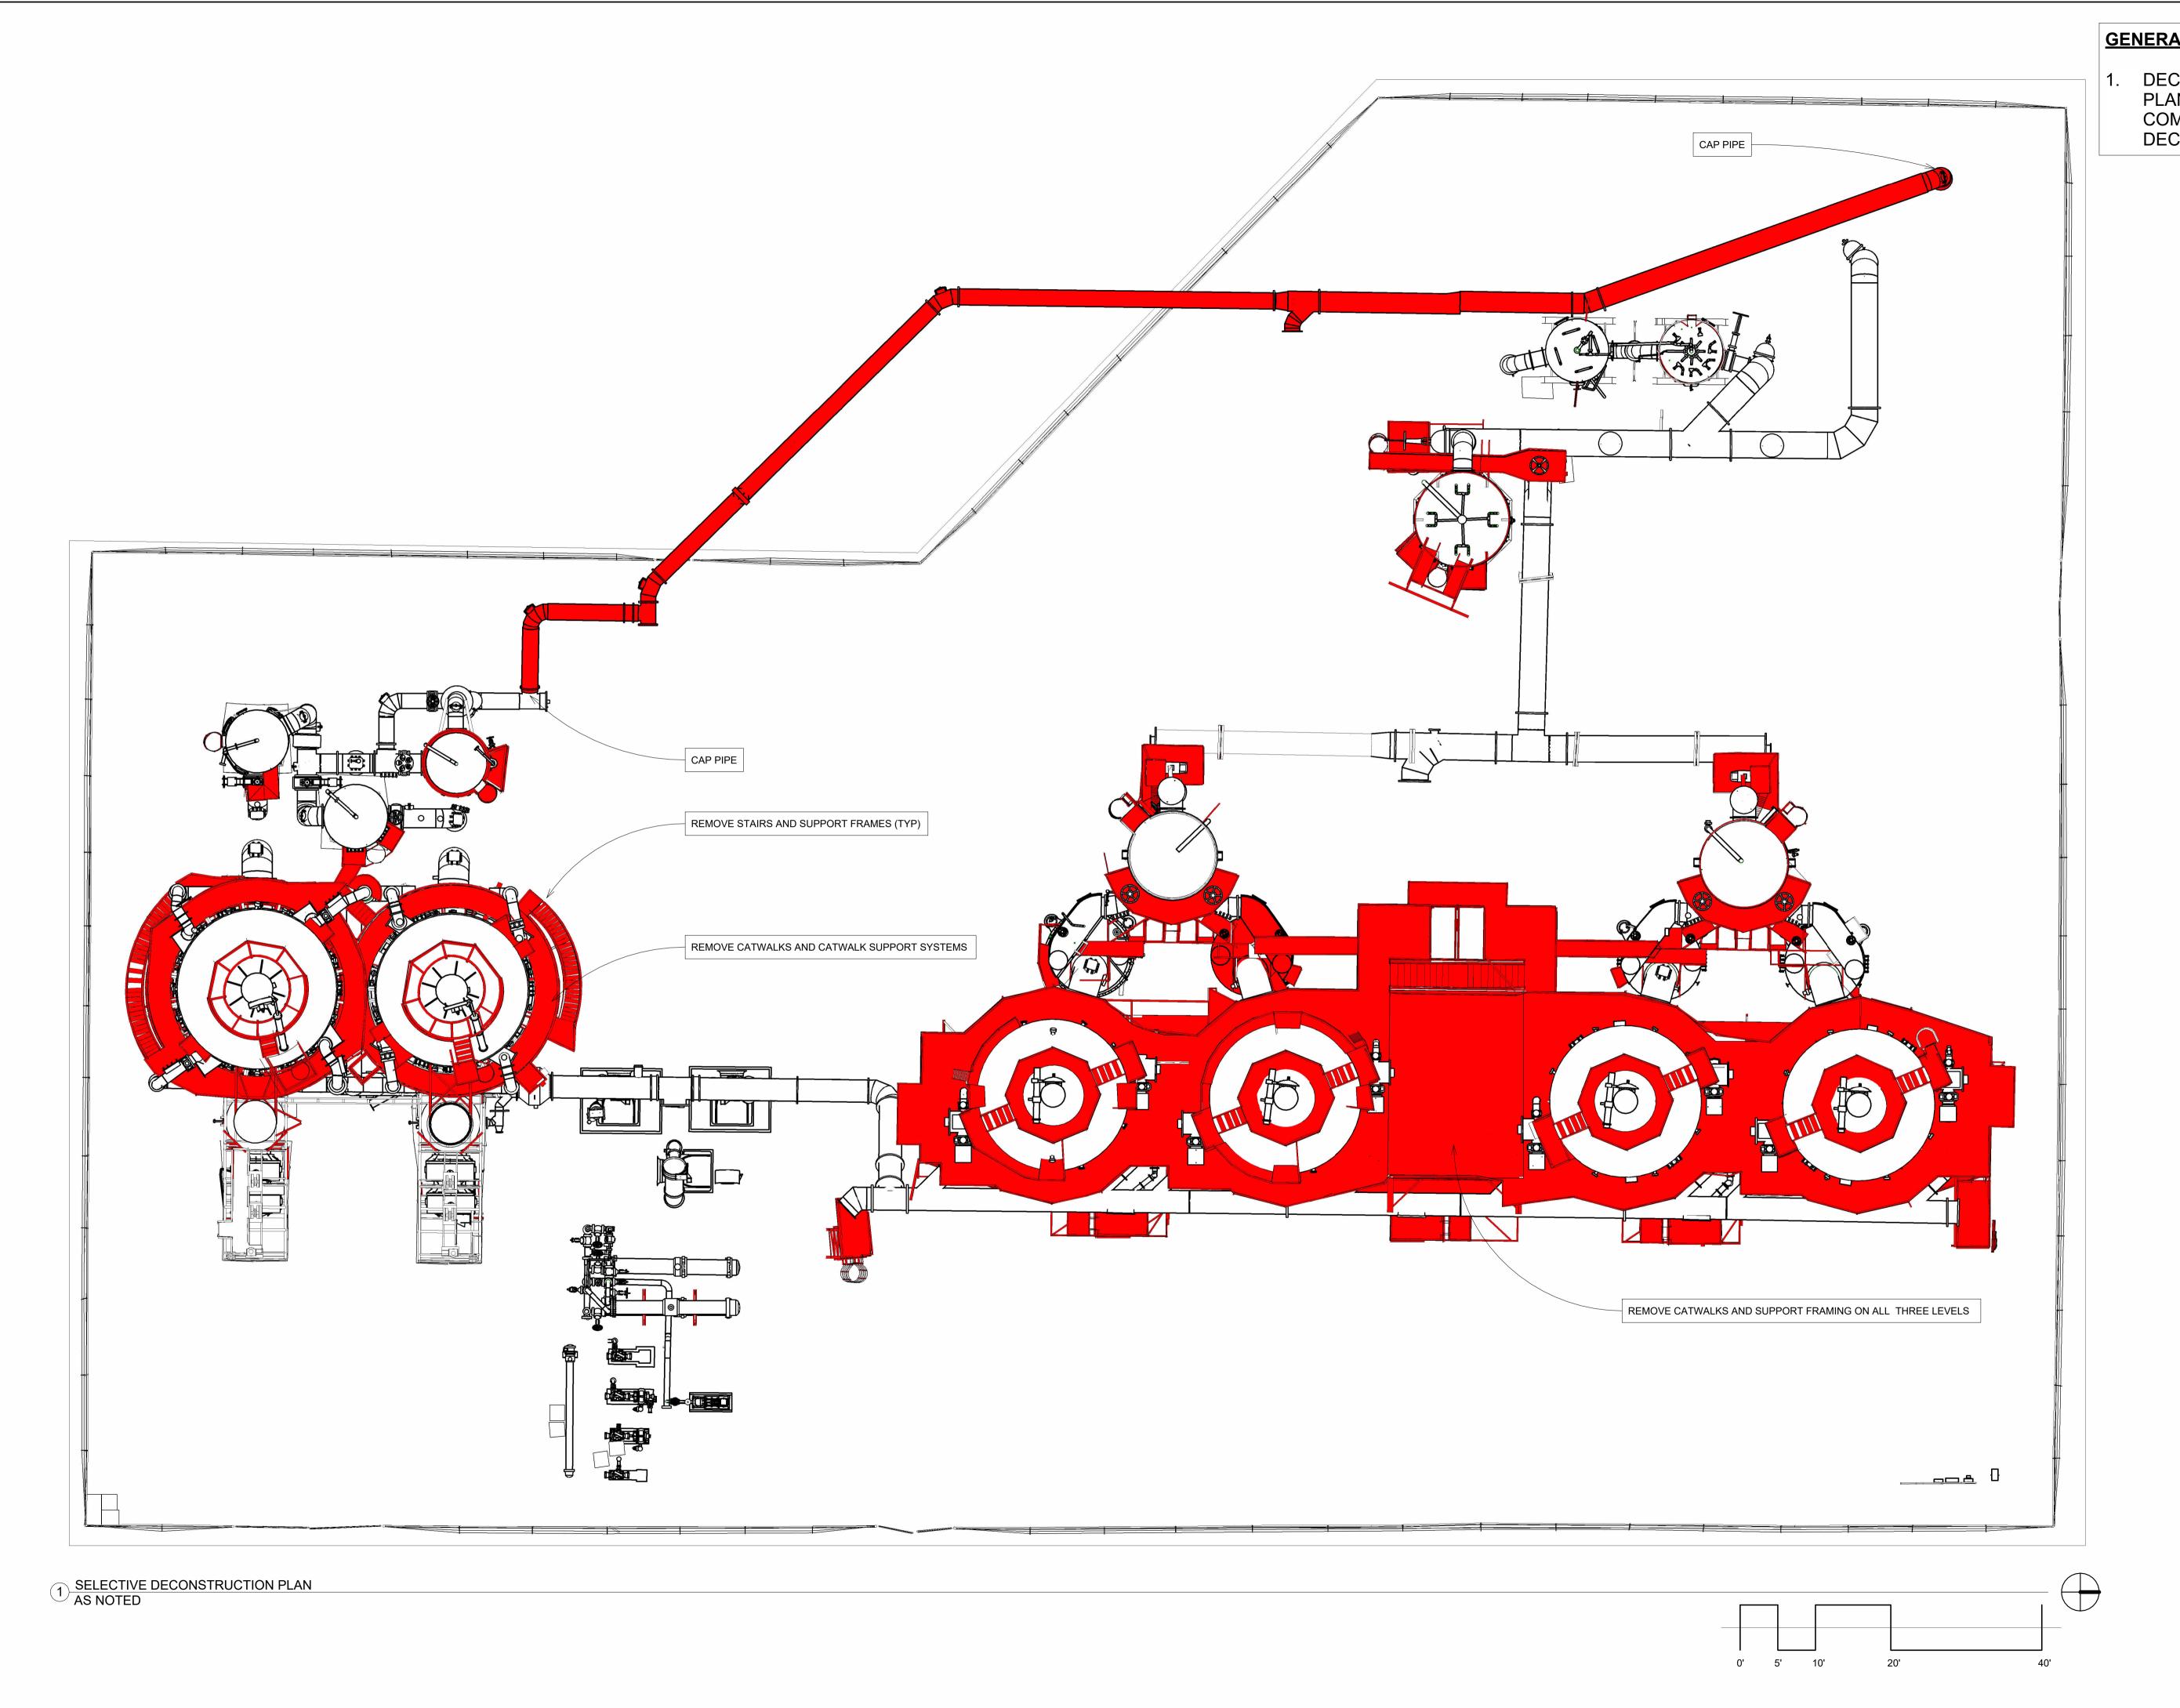

GENERAL NOTES:

1. DECONSTRUCTION SHOWN ON THIS PLAN DOES NOT REPRESENT THE COMPLETE SCOPE OF DECONSTRUCTION REQUIREMENTS.

> APPROVED FOR ADVERTISING: FAS PURCHASING AND CONTRACTING DIRECTOR

NO.

REVIEWED:

Director, Purchasing & Contracting

DATE

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GAS WORKS PARK

EMERGENCY DEMOLITION


SELECTIVE DECONSTRUCTION PLAN

DATE 08/07/25 DESIGNED Author DRAWN _____Designer_ CHECKED Checker SHEET ____ OF ___

D1.02 ORDINANCE NO. CONTRACT NO.

SCALE AS NOTED (U.N.O.)

- DEMOLISH (E) PIPING
- 2. DEMOLISH (E) RAILING
- DEMOLISH (E) CATWALKS
- 4. DEMOLISH (E) CATWALK SUPPORT STRUCTURE
- 5. DEMOLISH (E) LADDER ASSEMBLY AND SUPPORT SYSTEM
- 6. DEMOLISH (E) PIPE SUPPORTS CUT OFF FLUSH WITH GRADE

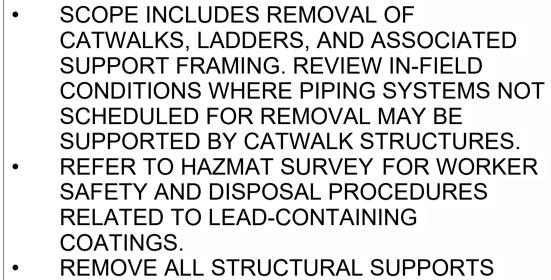

REMOVE ALL ELEMENTS INDICATED IN

APPLY "CORROSIONX HD" CORROSION-

INHIBITING COATING (OR APPROVED

THAT HAS BÉEN CUT OR TORCHED.

CAP EXISTING PIPE AT CUT/TORCH

CORROSION-INHIBITING COATING.

EQUIVALENT) TO ALL EXPOSED STEEL

LOCATIONS USING A 1/2" STEEL PLATE,

FIELD-WELDED TO THE PIPE END. PAINT

THE CAP AND WELDS WITH THE SPECIFIED

GENERAL NOTES

RED.


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FAS PURCHASING AND CONTRACTING DIRECTOR

Director, Purchasing & Contracting 2 NO. **REVISION - AS BUILT** DATE

REVIEWED: PARK ENGINEER

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GAS WORKS PARK


EMERGENCY DEMOLITION

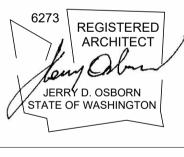WEST DECONSTRUCTION **ELEVATION**

DATE DESIGNED ___Author 08/07/25 DRAWN Designer SHEET ____ OF ___ CHECKED ____Checker_

D1.03 ORDINANCE NO. CONTRACT NO.

SCALE AS NOTED (U.N.O.)

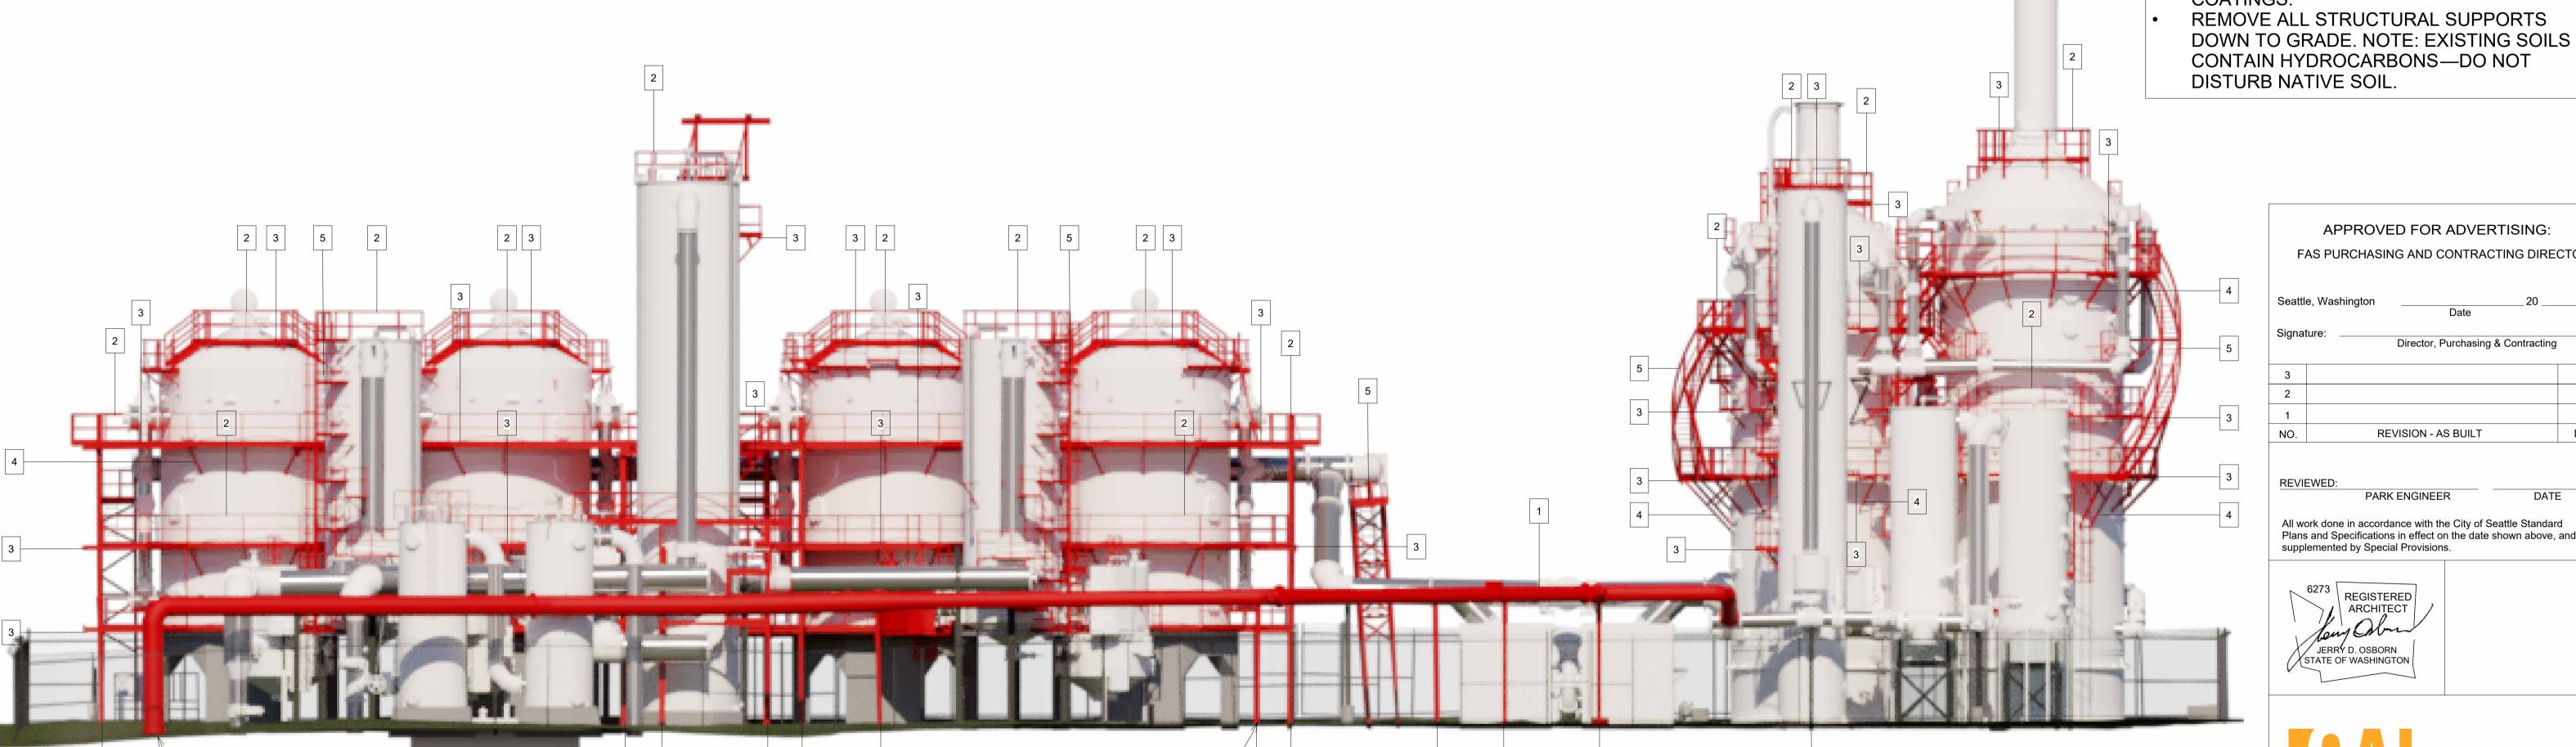

CAP ALL STRUCTURAL SUPPORTS AT GRADE (TYP.)

WEST DECONSTRUCTION ELEVATION ^¹∕ AS NOTED

CAP PIPE AT GRADE

4 4

- DEMOLISH (E) PIPING
- 2. DEMOLISH (E) RAILING
- DEMOLISH (E) CATWALKS
- 4. DEMOLISH (E) CATWALK SUPPORT STRUCTURE
- 5. DEMOLISH (E) LADDER ASSEMBLY AND SUPPORT SYSTEM
- 6. DEMOLISH (E) PIPE SUPPORTS CUT OFF FLUSH WITH GRADE

GENERAL NOTES

- REMOVE ALL ELEMENTS INDICATED IN
- APPLY "CORROSIONX HD" CORROSION-INHIBITING COATING (OR APPROVED EQUIVALENT) TO ALL EXPOSED STEEL THAT HAS BÉEN CUT OR TORCHED.
- CAP EXISTING PIPE AT CUT/TORCH LOCATIONS USING A 1/2" STEEL PLATE, FIELD-WELDED TO THE PIPE END. PAINT THE CAP AND WELDS WITH THE SPECIFIED CORROSION-INHIBITING COATING.
- SCOPE INCLUDES REMOVAL OF CATWALKS, LADDERS, AND ASSOCIATED SUPPORT FRAMING. REVIEW IN-FIELD CONDITIONS WHERE PIPING SYSTEMS NOT SCHEDULED FOR REMOVAL MAY BE SUPPORTED BY CATWALK STRUCTURES.
- REFER TO HAZMAT SURVEY FOR WORKER SAFETY AND DISPOSAL PROCEDURES RELATED TO LEAD-CONTAINING
- REMOVE ALL STRUCTURAL SUPPORTS DOWN TO GRADE. NOTE: EXISTING SOILS CONTAIN HYDROCARBONS—DO NOT



DATE

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GAS WORKS PARK

EMERGENCY DEMOLITION

NORTH DECONSTRUCTION **ELEVATION**

DESIGNED	Author	DATE	08/07/25
DRAWN	Designer		
CHECKED	Checker	SHEET	OF
		†	

D1.04 ORDINANCE NO. CONTRACT NO.

SCALE AS NOTED (U.N.O.)

5 CAP PIPE

NORTH DECONSTRUCTION ELEVATION

AS NOTED


- 1. DEMOLISH (E) PIPING
- 2. DEMOLISH (E) RAILING
- B. DEMOLISH (E) CATWALKS
- 4. DEMOLISH (E) CATWALK SUPPORT STRUCTURE
- 5. DEMOLISH (E) LADDER ASSEMBLY AND SUPPORT SYSTEM
- 6. DEMOLISH (E) PIPE SUPPORTS CUT OFF FLUSH WITH GRADE

GENERAL NOTES

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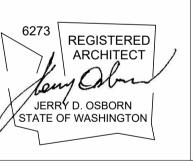


2 SOUTH DECONSTRUCTION ELEVATION AS NOTED

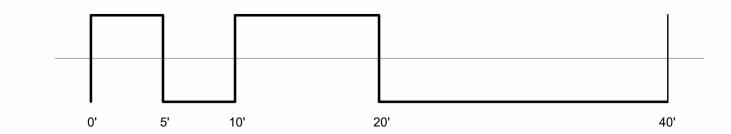

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GAS WORKS PARK

EMERGENCY DEMOLITION

SOUTH DECONSTRUCTION ELEVATION

 ELEVATION

 DESIGNED
 Author
 DATE
 08/07/25

 DRAWN
 Designer
 SHEET
 OF

ORDINANCE NO. _____


D1.05

SCALE AS NOTED (U.N.O.)


- DEMOLISH (E) PIPING
- 2. DEMOLISH (E) RAILING
- DEMOLISH (E) CATWALKS
- 4. DEMOLISH (E) CATWALK SUPPORT STRUCTURE
- 5. DEMOLISH (E) LADDER ASSEMBLY AND SUPPORT SYSTEM
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2 EAST ELEVATION AS NOTED



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Seattle, Washington Director, Purchasing & Contracting 2 NO. DATE **REVISION - AS BUILT**

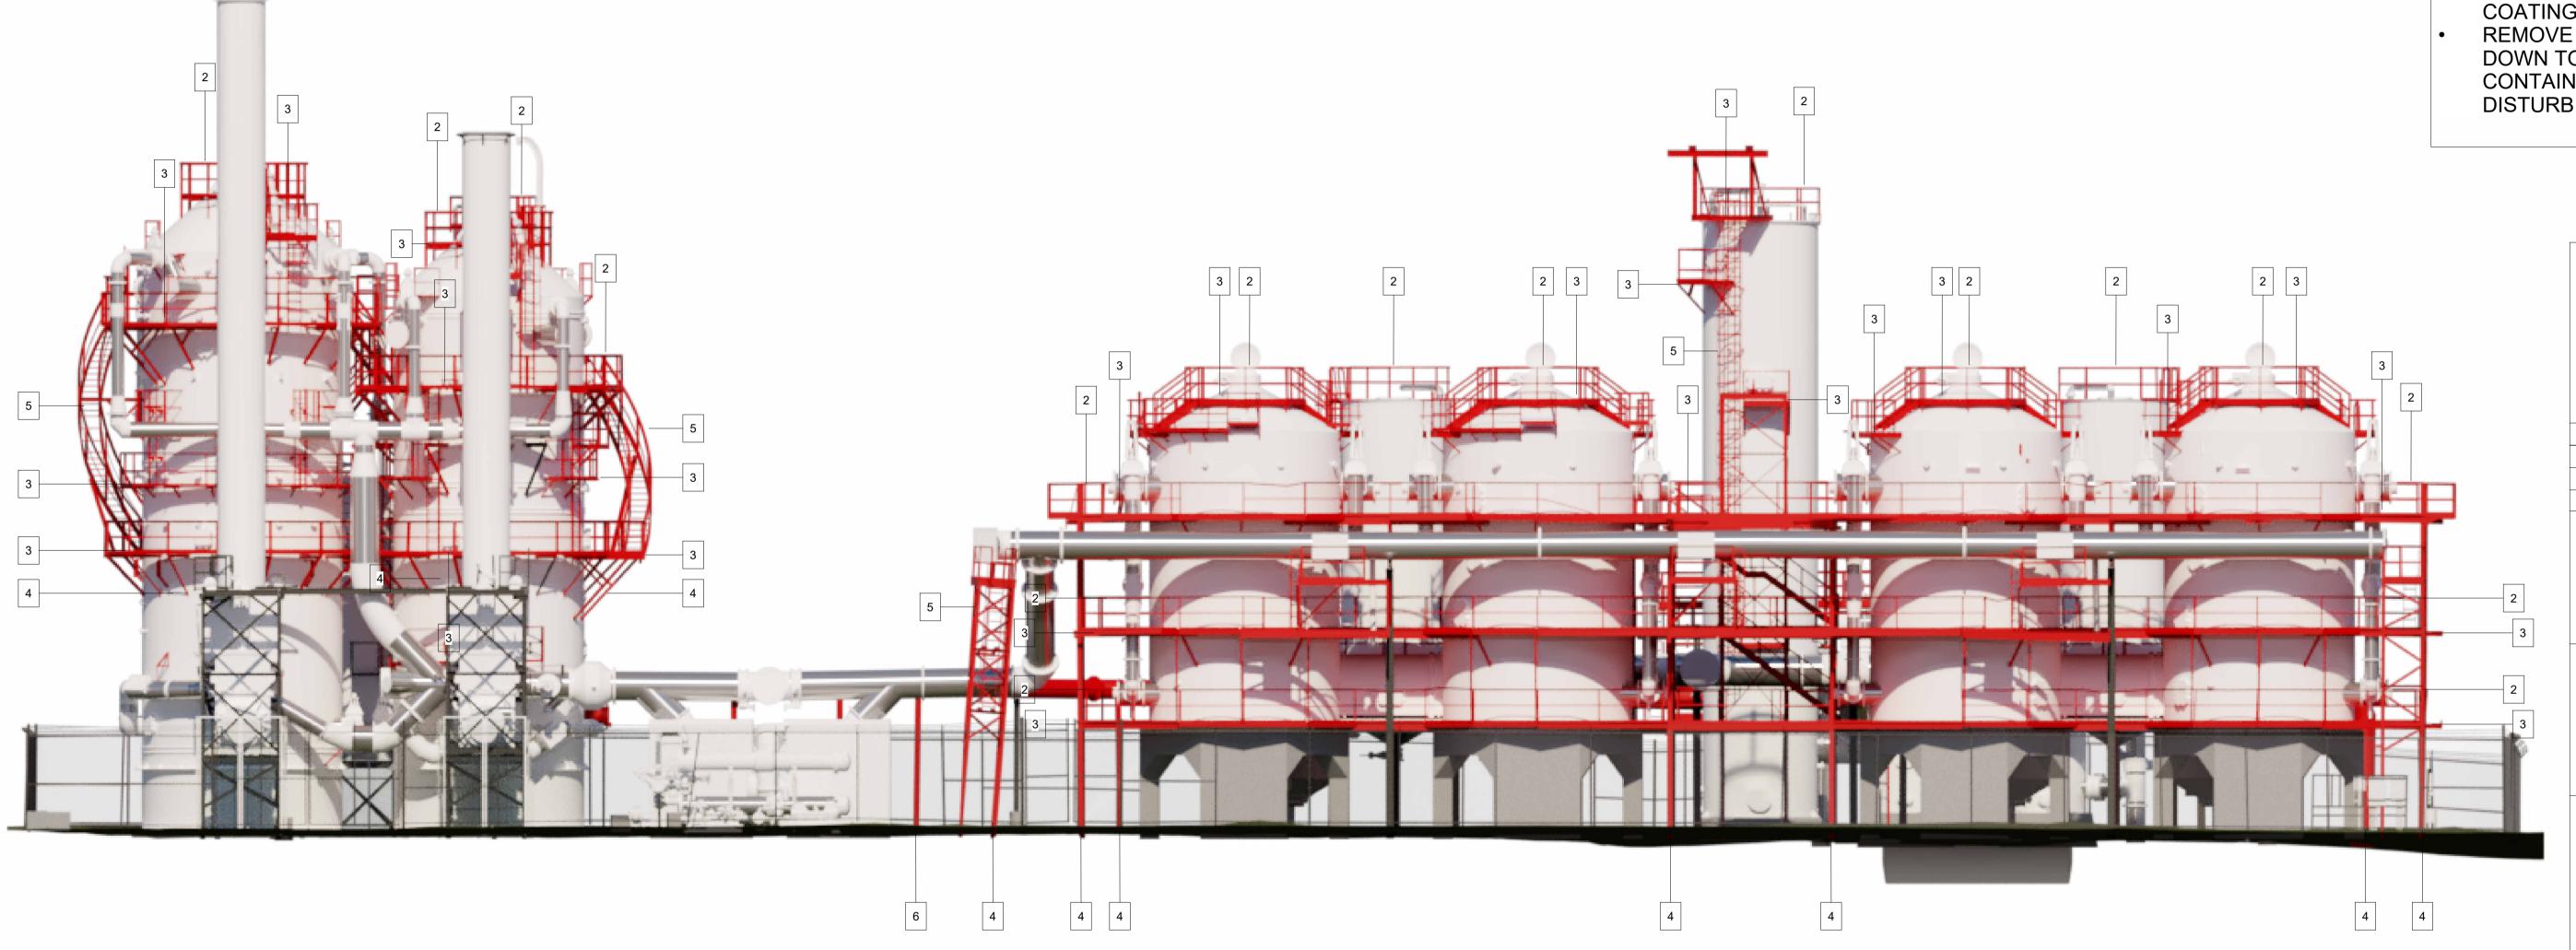REVIEWED: PARK ENGINEER

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JERRY D. OSBORN STATE OF WASHINGTON
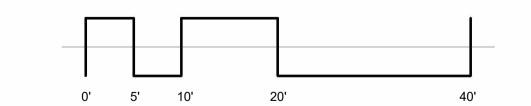
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GAS WORKS PARK

EMERGENCY DEMOLITION

EAST DECONSTRUCTION ELEVATION

08/07/25


DATE DESIGNED Author DRAWN Designer SHEET ____ OF __ CHECKED Checker

D1.06 ORDINANCE NO.

CONTRACT NO.

SCALE AS NOTED (U.N.O.)

Gas Works Park Cracking Towers

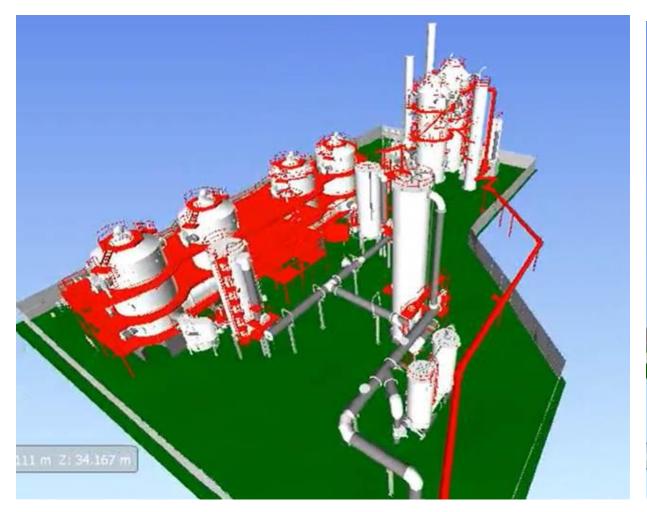




Looking Southeast (before and after)






Looking Northeast (before and after)

Gas Works Park Cracking Towers

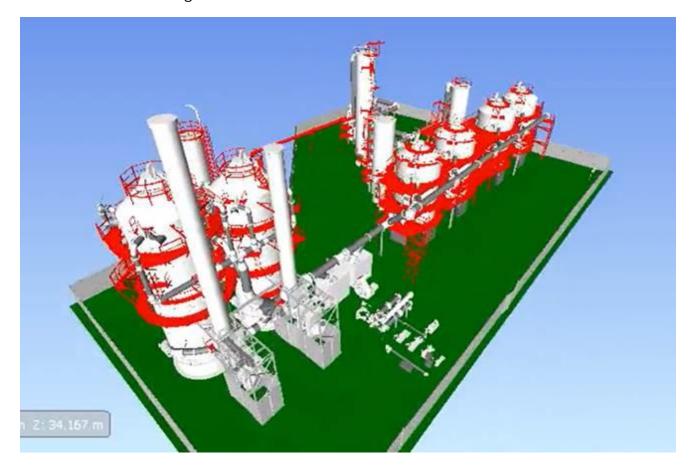

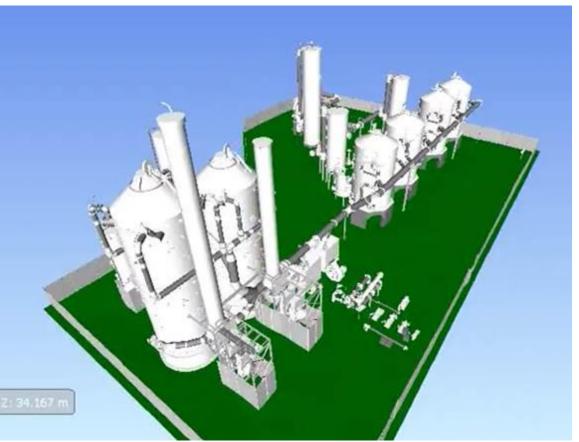

Looking Northwest (before and after)





Looking Southwest (before and after)