


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2		G-002	NOTES (1 OF 2)
3		G-003	NOTES (2 OF 2)
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6		CD101	CSEC PLAN - SW HOLDEN ST (1 OF 2)
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8		CD103	DEMOLITION PLAN - SW HOLDEN ST (1 OF 2)
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12	-	CU101	GRADING AND STORM DRAIN PLAN AND PROFILE - SW HOLDEN ST (1 OF 2)
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DETAIL AND SECTION REFERENCING

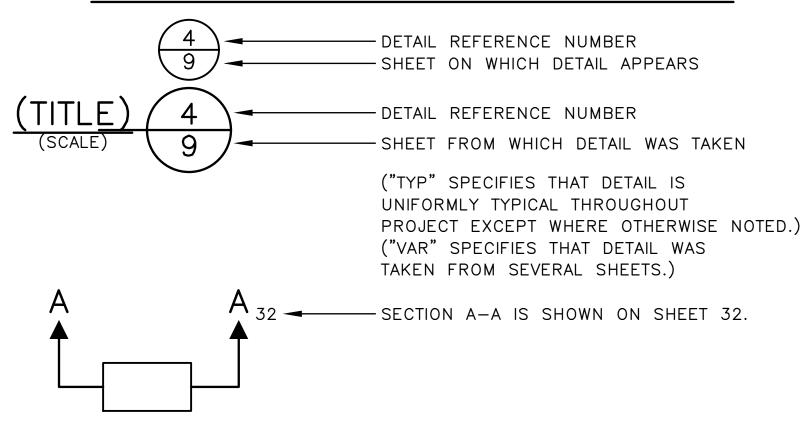

SECTION A−A 30 - SECTION A-A IS TAKEN FROM SHEET 30.

VICINITY MAP. LOCATION MAP, SHEET INDEX, DETAIL AND SECTION REFERENCING

APPROVED FOR ADVERTISING	INITIALS AND DATE	INITIALS AND DATE
DEPARTMENT OF FINANCE & ADMINISTRATIVE SERVICES SEATTLE, WASHINGTON 20	DESIGNED CHECKED	REVIEWED: DES. CONST. SDOT PROJ. MGR.
SEATTLE, WASHINGTON	DRAWN	RECEIVED
	CHECKED	REVISED AS BUILT
BY:	ALL WORK SHALL BE DONE IN ACCORDANCE WITH T SPECIFICATIONS AND OTHER DOCUMENTS CALLED FO	



HOLDEN NDS

VPI # 792-752 G - 001

SHEET 1 OF 36

- 1. ALL WORK MUST CONFORM TO THE 2023 EDITION OF CITY OF SEATTLE STANDARD SPECIFICATIONS, THE 2023 EDITION OF THE CITY OF SEATTLE STANDARD PLANS; AND SEATTLE DEPARTMENT OF TRANSPORTATION DIRECTOR'S RULE 01-2017 RIGHT-OF-WAY OPENING AND RESTORATION RULES. A COPY OF THESE DOCUMENTS SHALL BE ON SITE DURING CONSTRUCTION.
- 2. A COPY OF THE APPROVED PLAN MUST BE ON SITE WHENEVER CONSTRUCTION IS IN PROGRESS.
- 3. ERRORS AND OMISSIONS ON THE PERMITTED PLANS MUST BE CORRECTED BY THE ENGINEER AND APPROVED BY THE CITY OF SEATTLE.
- 4. ALL PERMITS REQUIRED FOR WORK WITHIN THE PUBLIC RIGHT OF WAY MUST BE OBTAINED PRIOR TO THE START OF CONSTRUCTION.
- 5. NOT USED.
- 6. CONTRACTOR MUST CONTACT SEATTLE DEPARTMENT OF TRANSPORTATION, STREET USE INSPECTOR A MINIMUM OF 2 BUSINESS DAYS PRIOR TO NEEDING AN INSPECTION.
- 7. ALL DAMAGE TO CITY INFRASTRUCTURE CAUSED BY THE CONSTRUCTION MUST BE IMMEDIATELY REPORTED AND REPAIRED AS REQUIRED BY THE SEATTLE DEPARTMENT OF TRANSPORTATION. TO REPORT DAMAGE TO SPU INFRASTRUCTURE, INCLUDING ANY SEWAGE RELEASE OR BLOCKAGE, CALL 206-386-1800.
- 8. THE APPROVED PLANS WILL SHOW THE APPROXIMATE AREA OF PAVEMENT RESTORATION BASED ON THE DEPTH OF UTILITY CUTS AND/OR THE AREA OF CURB AND/OR PAVEMENT TO BE REMOVED AND REPLACED. THE ACTUAL LIMITS OF THE PAVEMENT RESTORATION WILL BE PER THE DIRECTOR'S RULE 01-2017, RIGHT-OF-WAY OPENING AND RESTORATION RULE AND WILL BE DETERMINED IN THE FIELD BY THE SEATTLE DEPARTMENT OF TRANSPORTATION STREET USE INSPECTOR PRIOR TO THE PAVEMENT RESTORATION. FOR SPU WATER SERVICES, APPLICANT MUST SHOW THE PAVEMENT RESTORATION LIMITS FOR THE PROPOSED AND THE EXISTING WATER SERVICES TO BE RETIRED, INCLUDING SERVICES THAT ARE OUTSIDE THE PROJECT AREA, BUT SERVE THE PARCEL.
- 9. NAVD88 AND NAD 83 (2011) 2010.00 EPOCH.
- 10. SURVEYING AND STAKING OF ALL IMPROVEMENTS IN THE PUBLIC RIGHT OF WAY MUST BE COMPLETED PRIOR TO CONSTRUCTION. CONTRACTOR TO STAKE THE CURB AT THE CENTERLINE OF DRAINAGE GRATES PER STANDARD PLAN 260A. SURVEY GRADE SHEETS MUST BE SUBMITTED AND APPROVED BY THE SEATTLE DEPARTMENT OF TRANSPORTATION AT LEAST 2 BUSINESS DAYS PRIOR TO CONSTRUCTION.
- 11. IF AN EXISTING CURB IS TO BE REMOVED AND REPLACED IN THE SAME LOCATION THE CONTRACTOR MUST PROVIDE THE STREET USE INSPECTOR A PLAN WITH EXISTING FLOW LINE AND TOP OF CURB ELEVATIONS IDENTIFIED. CONTRACTOR TO STAKE THE LOCATION OF THE EXISTING CURB PRIOR TO DEMOLITION.
- 12. THE CONTRACTOR MUST BE RESPONSIBLE FOR REFERENCING AND REPLACING ALL SURVEY MONUMENTS THAT MAY BE DISTURBED, DESTROYED OR REMOVED BY THE PROJECT AND 2 WORKING DAYS, PRIOR TO THE WORK, MUST FILE AN APPLICATION FOR PERMIT TO REMOVE OR DESTROY A SURVEY MONUMENT WITH THE WASHINGTON STATE DEPARTMENT OF NATURAL RESOURCES, PURSUANT TO WAC 332-120. THE CONTRACTOR MUST PROVIDE THE ENGINEER AND SPU LAND SURVEY WITH A COPY OF THE APPROVED PERMIT AND COMPLETION REPORT. SEE STANDARD SPECIFICATION 1- 07.28 ITEM 17.
- 13. THE CONTRACTOR MUST SUBMIT ALL APPLICABLE DOCUMENTS REQUIRED UNDER SECTION 1-05.3 OF THE STANDARD SPECIFICATIONS PRIOR TO CONSTRUCTION. A MATERIAL SOURCE FORM FOR ALL MATERIALS TO BE PLACED IN THE RIGHT OF WAY AND MIX DESIGNS FOR ALL ASPHALT, CONCRETE AND AGGREGATES TO BE PLACED IN THE RIGHT OF WAY MUST BE SUBMITTED TO THE SEATTLE DEPARTMENT OF TRANSPORTATION FOR REVIEW AND APPROVAL PRIOR TO BEGINNING CONSTRUCTION. A REVISED MATERIAL SOURCE FORM AND MIX DESIGNS MUST BE SUBMITTED FOR REVIEW AND APPROVAL PRIOR TO PLACEMENT OF ANY SUBSTITUTE MATERIALS.
- 14. THE CONTRACTOR MUST NOTIFY THE SEATTLE FIRE DEPARTMENT DISPATCHER (206-386-1495) AT LEAST TWENTY-FOUR (24) HOURS IN ADVANCE OF ALL WATER SERVICE INTERRUPTIONS, HYDRANT SHUTOFFS, AND STREET CLOSURES OR OTHER ACCESS BLOCKAGE. THE CONTRACTOR MUST ALSO NOTIFY THE DISPATCHER OF ALL NEW, RELOCATED, OR ELIMINATED HYDRANTS RESULTING FROM THIS WORK.

- 15. THE CONTRACTOR MUST LOCATE AND PROTECT ALL CASTINGS AND UTILITIES DURING CONSTRUCTION.
- 16. THE CONTRACTOR MUST CONTACT THE UNDERGROUND UTILITIES LOCATOR SERVICE (811) AT LEAST 48 HOURS PRIOR TO CONSTRUCTION.
- 17. IT IS THE SOLE RESPONSIBILITY OF THE CONTRACTOR TO VERIFY THE ACCURACY OF ALL UTILITY LOCATIONS SHOWN AND TO FURTHER DISCOVER AND AVOID ANY OTHER UTILITIES NOT SHOWN WHICH MAY BE AFFECTED BY THE IMPLEMENTATION OF THIS PLAN. ALL LOCATIONS OF EXISTING UTILITIES SHOWN HEREIN HAVE BEEN ESTABLISHED BY FIELD SURVEY OR OBTAINED FROM AVAILABLE RECORDS AND SHOULD THEREFORE BE CONSIDERED APPROXIMATELY ONLY AND NOT NECESSARILY COMPLETE. UTILITIES HAVING NO RECORDED DEPTH ARE SHOWN AT THEIR STANDARD DEPTH. WHERE AVAILABLE, POTHOLE LOCATIONS AND DEPTH INFORMATION OBTAINED FOR THE PROJECT ARE SHOWN IN THE DRAWINGS.
- 18. THE CONTRACTOR MUST ADJUST ALL EXISTING MAINTENANCE HOLE RIMS, DRAINAGE STRUCTURE LIDS, VALVE BOXES, AND UTILITY ACCESS STRUCTURES TO FINISH GRADE WITHIN AREAS AFFECTED BY THE PROPOSED IMPROVEMENTS PER STD SPEC 7-20.3. IF AN EXISTING WATER VALVE BOX REQUIRES ADJUSTMENT, IT MUST BE DONE BY EXCAVATING THE CASTING AND VERTICALLY ADJUSTING THE TOP SECTION OF THE VALVE BOX. THE FLANGE MUST BE CAST INTO SURROUNDING PAVEMENT AS SHOWN ON STD PLAN 315. DO NOT USE RING EXTENSIONS.
- 19. THE CONTRACTOR MUST FOLLOW SPU CORE TAP PROCEDURES FOR ALL NEW CONNECTIONS TO EXISTING SEWER OR DRAINAGE MAINS OR STRUCTURES. CONTRACTORS ARE NOT ALLOWED TO CORE INTO MAINS OR STRUCTURES 6 PRIOR APPROVAL FROM SPUDWW. TO SCHEDULE CORE CUT CONTACT SPU-DWW AT 206-615-0511 A MINIMUM OF 2 BUSINESS DAYS IN ADVANCE.
- 20. ALL UTILITY SERVICE CONNECTIONS SHOWN ON THIS PLAN REQUIRE SEPARATE PERMITS.
- 21. THE CONTRACTOR MUST PROVIDE FOR ALL TESTING AS REQUIRED BY THE STREET USE INSPECTOR AND SPU RESIDENT ENGINEER
- 22. INSPECTION AND ACCEPTANCE OF ALL WORK IN THE PUBLIC RIGHT-OF-WAY MUST BE DONE BY REPRESENTATIVES OF THE CITY OF SEATTLE. IT WILL BE THE CONTRACTOR'S RESPONSIBILITY TO COORDINATE AND SCHEDULE APPROPRIATE INSPECTIONS ALLOWING FOR PROPER ADVANCE NOTICE. THE SEATTLE DEPARTMENT OF TRANSPORTATION STREET USE INSPECTOR MAY REQUIRE REMOVAL AND RECONSTRUCTION OF ANY ITEMS PLACED IN THE RIGHT OF WAY THAT DO NOT MEET CITY STANDARDS OR THAT WERE CONSTRUCTED WITHOUT APPROPRIATE INSPECTIONS.
- 23. THE CONTRACTOR MUST PROVIDE A PLAN FOR STORMWATER AND EROSION CONTROL AND INSTALL, MAINTAIN AND REMOVE TEMPORARY FACILITIES PER SECTION 8-01. AS CONSTRUCTION PROGRESSES AND CONDITIONS DICTATE, ADDITIONAL CONTROL FACILITIES MAY BE REQUIRED. DURING THE COURSE OF CONSTRUCTION IT WILL BE THE OBLIGATION AND RESPONSIBILITY OF THE CONTRACTOR TO ADDRESS ANY NEW CONDITIONS THAT MAY BE CREATED BY THE CONTRACTOR'S ACTIVITIES AND TO PROVIDE ADDITIONAL FACILITIES THAT MAY BE NEEDED TO PROTECT ADJACENT PROPERTIES.
- 24. NOT USED.
- 25. ALL TRAFFIC CONTROL MUST BE IN ACCORDANCE WITH THE CITY OF SEATTLE TRAFFIC CONTROL MANUAL FOR IN-STREET WORK. AN APPROVED TRAFFIC CONTROL PLAN WILL BE REQUIRED FOR ALL ARTERIAL STREETS, HIGH IMPACT AREAS AND CONSTRUCTION HUBS PRIOR TO BEGINNING CONSTRUCTION. TRUCK TRAFFIC MUST BE MINIMIZED THROUGH THE NEIGHBORHOODS. TRUCK TRAFFIC MUST USE ARTERIAL ROUTES WHERE POSSIBLE.
- 26. CONTRACTOR MUST NOTIFY KING COUNTY METRO AT 206- 477-1140 FOURTEEN DAYS IN ADVANCE OF ANY IMPACT TO TRANSIT OPERATIONS. CALL 206-477-1150 FOR ANY COORDINATION RELATED TO KING COUNTRY METRO TROLLEY (INCLUDING SLU AND FIRST HILL STREET CAR). CONTACT KING COUNTY METRO TWO MONTHS PRIOR FOR ANY TROLLEY DE-ENERGIZING REQUESTS.
- 27. COORDINATE PARKING/LOADING SIGN(S) AND PAY STATION REMOVAL / RELOCATION AND INSTALLATION WITH SEATTLE DEPARTMENT OF TRANSPORTATION CURB SPACE MANAGEMENT AT 206-684-5370 WITH AT LEAST 10 BUSINESS DAYS' NOTICE. SIGNPOSTS ARE TO BE INSTALLED IN ACCORDANCE WITH STANDARD PLANS 616, 620, 621A, 621B, 625, & 626
- 28. ALL STREET NAME SIGNS MUST BE INSTALLED BY SEATTLE DEPARTMENT OF TRANSPORTATION AT THE CONTRACTOR'S EXPENSE.

- 29. ALL PLANNED AND PROPOSED WORK SHOWN HEREIN TO BE PERFORMED BY SEATTLE CITY LIGHT, SEATTLE PUBLIC UTILITIES, AND OTHER UTILITIES TO INSTALL, REPAIR, REMOVE OR RELOCATE UTILITIES WILL BE DONE AT THE PERMITTEE'S EXPENSE.
- 30. CONTRACTOR MUST CONTACT THE SEATTLE DEPARTMENT OF PARKS AND RECREATION TO APPLY FOR A SEPARATE PERMIT IF WORKING WITHIN A DESIGNATED PARK BOULEVARD.
- 31. CARE MUST BE EXERCISED WHEN EXCAVATING OR REMOVING PAVEMENT NEAR EXISTING CHARGED WATER MAINS. CAST IRON WATER MAINS ARE KNOWN TO BE SENSITIVE TO EXCESSIVE VIBRATION. COORDINATE PROTECTION METHODS WITH SPU.

SEATTLE CITY LIGHT NOTES UNLESS OTHERWISE NOTED:

- 1. ALL DISCONNECTIONS: TEMPORARY OR FINAL SERVICE CONNECTIONS WILL BE MADE BY SEATTLE CITYLIGHT (SCL) AT PROJECT'S EXPENSE. COORDINATE ALL ENERGIZING AND DE-ENERGIZING OF STREET LIGHTING SERVICE WITH SCL ELECTRICAL SERVICE REPRESENTATIVE AND STREETLIGHT ENGINEER FIFTEEN (15) WORKING DAYS IN ADVANCE. ADDITIONAL TIME MAY BE NEEDED FOR CREW SCHEDULING AND MOBILIZATION.
- 2. CONTRACTOR MUST MAKE PRIOR COORDINATION FOR FLOOD OR STREETLIGHT REMOVAL. CONTRACTOR MUST MAKE PRIOR DELIVERY COORDINATION FOR SALVAGED STREETLIGHT-RELATED MATERIALS TOSEATTLE CITY LIGHT SALVAGE YARD AT 4TH AVE S & S SPOKANE ST, 98134. CONTACT SALVAGE COORDINATOR AT 206-386-1765. NO ARTERIAL STREETLIGHT MAY BE DISABLED WITHOUT PRIOR APPROVAL FROM SEATTLE DEPARTMENT OF TRANSPORTATION, (SDOT).
- 3. EXISTING STREET LIGHTING SYSTEM SHALL BE MAINTAINED DURING CONSTRUCTION.
- 4. WORK MUST BE SCHEDULED SUCH THAT NO TWO (2) ADJACENT OR OPPOSITE STREETLIGHTS ARE DISABLED AT ANY ONE TIME.
- 5. ANY EXCAVATION IN PROXIMITY TO AN EXISTING POWER POLE, STREETLIGHT POLE, OR OTHER INSTALLATION MUST BE DONE WITHOUT UNDERMINING ITS STABILITY UST COMPLY WITH WASHINGTON ADMINISTRATIVE CODE (WAC) 296-155, SAFETY STANDARDS FOR CONSTRUCTION WORK, PART N. CONTRACTOR IS RESPONSIBLE FOR TEMPORARY STABILIZING SUPPORT. POLE PROTECTION/SUPPORTING SYSTEMS USED WHILE EXCAVATING MUST COMPLY WITH CITY LIGHT WORK PRACTICE 0101.75.
- 6. INSTALLATION OF UNDERGROUND STREETLIGHT SYSTEMS, AND STREETLIGHT SYSTEM GROUNDING AND BONDING MUST BE PER SEATTLE CITY LIGHT (SCL) CONSTRUCTION STANDARD 1714.50.
- 7. ALL WIRING, INCLUDING STREET LIGHTING, PEDESTRIAN LIGHTING AND FESTOON LIGHTING CIRCUITS MUST BE CLEARLY LABELED PER SEATTLE CITY LIGHT (SCL) CONSTRUCTION STANDARD 1714.10.
- 8. EACH LUMINAIRE MUST BE FUSED PER (SCL) CONSTRUCTION STANDARD 1730.00.
- 9. STREETLIGHT HANDHOLE AND CONDUIT REQUIREMENTS MUST CONFORM TO SCL CONSTRUCTION STANDARD 1716.07.
- 10. PULL TAPE MUST BE INSTALLED THROUGH VACANT CONDUIT CAPPED PER (SCL) CONSTRUCTION STANDARD U2-11.40/NDK-40.
- 11. MAINTAIN MINIMUM HORIZONTAL & VERTICAL CLEARANCES BETWEEN SCL UNDERGROUND STRUCTURES AND VARIOUS OTHER UTILITY STRUCTURES PER SCL CONSTRUCTION STANDARD 0214.00.
- 12. FOR STREET LIGHTING INSPECTIONS CONTACT SCL ELECTRICAL REVIEWER TEN (10) WORKING DAYS IN ADVANCE.
- 13. CONTRACTOR MUST CALL FOR AN ELECTRICAL REVIEWER INSPECTION OF THE STREET LIGHTING SYSTEM AT VARIOUS STAGES OF INSTALLATION/CONSTRUCTION OR AS INSTRUCTED BY THE SCL INSPECTOR.
- 14. CONTRACTOR MUST PROVIDE AN OPERATOR AND MAN LIFT TRUCK FOR USE DURING INSPECTION OF INSTALLED STREETLIGHT FACILITIES.

ORDINANCE NO.

SIGNAL NOTES

UNLESS OTHERWISE NOTED:

- 1. CONTRACTOR SHALL MAINTAIN EXISTING SIGNAL OPERATION DURING CONSTRUCTION AND PROVIDE TEMPORARY SIGNAL MODIFICATIONS WHEN NEEDED APPROVED BY THE ENGINEER AT THE CONTRACTOR'S EXPENSE
- 2. ALL WORK NECESSARY TO ADJUST, RELOCATE, REPAIR OR CONSTRUCT ANY PART OF THE SIGNAL UTILITY SHALL BE AT THE CONTRACTOR'S EXPENSE. THIS WORK IS TO BE PERFORMED BY A QUALIFIED SIGNAL CONTRACTOR OR SDOT CREWS.
- 3. ANY CONFLICTS WITH THE SIGNAL SYSTEM AND CONSTRUCTION SEQUENCE MUST BE COORDINATED WITH THE SIGNAL OPERATIONS OFFICE AS SOON AS KNOWN. CONTACT DODD PHARIS AT 206-684-5105. A MINIMUM FIVE WORKING-DAY NOTICE IS REQUIRED FOR ANY WORK REQUESTED OF TRAFFIC SIGNAL ELECTRICIAN CREWS. SDOT CREWS WILL NOT BE SCHEDULED UNTIL AN ACCOUNT HAS BEEN SET UP FOR THE SPECIFIC PROJECT WITH A DEPOSIT TO COVER ALL COSTS TO RESOLVE THE CONFLICT AND A RESPONSIBLE PARTY HAS SIGNED THE SDOT-SIGNAL PRIVATE CONTRACTOR BILLING AGREEMENT. ANY WORK PERFORMED BY SDOT CREWS EXCEEDING THE DEPOSIT AMOUNT WILL BE INVOICED AND BILLED TO THE CONTRACTOR. ANY UNUSED MONEY WILL BE REFUNDED AT THE CONCLUSION OF THE PROJECT.
- 4. ANY SIGNAL ITEMS, INCLUDING BUT NOT LIMITED TO SIGNAL HEADS, POLE FOUNDATIONS, PEDESTALS, DETECTOR LOOPS, CONDUITS, HANDHOLES, AND ASSOCIATED SPAN WIRES AND CABLES THAT ARE DAMAGED OR DESTROYED SHALL BE REPLACED AT THE CONTRACTOR'S EXPENSE.
- 5. ANY SIGNAL ITEMS WHICH ARE DISTURBED AS A RESULT OF GRADE CHANGE ARE REQUIRED TO BE REGRADED OR REPLACED AT THE CONTRACTOR'S EXPENSE.
- 6. ACCESS TO CONTROLLER CABINETS AND ASSOCIATED SIGNAL EQUIPMENT MUST BE AVAILABLE AT ALL TIMES. SPACE MUST BE PROVIDED FOR DOOR SWING. ANY FENCES, EQUIPMENT AND MATERIAL STORAGE SHALL NOT BLOCK ACCESS TO SIGNAL EQUIPMENT. ANY COSTS AND/OR TIME LOSS INCURRED BY SDOT CREWS IN GAINING ACCESS TO BLOCKED SIGNAL EQUIPMENT WILL BE AT THE CONTRACTOR'S EXPENSE.
- 7. ANY WORK THAT WILL DAMAGE OR DESTROY TRAFFIC LOOP DETECTORS MUST NOTIFY SIGNAL OPERATIONS OFFICE AT EARLIEST TIME NO LESS THAN TWO WEEKS PRIOR TO SCHEDULED WORK. SIGNAL OPERATIONS OFFICE WILL PREPARE AN ESTIMATE TO COVER THE COST ASSOCIATED WITH TEMPORARY DETECTION AND TIMING, DIS—CONNECTION, DETECTOR TESTING, RE—CONNECTION AND RESTORATION OF PERMANENT TIMING. IT IS THE RESPONSIBILITY OF THE CONTRACTOR TO RESTORE THE DETECTOR LOOPS WITHIN TWO (2) WEEKS OF DESTRUCTION OR PROVIDE TEMPORARY DETECTION DURING THE INTERIM. FULLY RESTORED PAVEMENT MUST BE IN PLACE BEFORE THE LOOPS CAN BE RESTORED. A DEPOSIT FOR THE FULL ESTIMATE PREPARED BY THE SIGNAL OPERATIONS OFFICE AND A SIGNED SDOT—SIGNAL PRIVATE CONTRACTOR BILLING AGREEMENT BILLING IS REQUIRED PRIOR TO SCHEDULED WORK.

PSE NOTES


UNLESS OTHERWISE NOTED:

- 1. CONTACT MAPREQUEST@PSE.COM FOR UPDATED GAS MAPS OF AREA.
- 2. MAINTAIN A MINIMUM 1-FT VERTICAL SEPARATION WHEN CROSSING GAS MAINS OR SERVICES AND MINIMUM3-FT HORIZONTAL SEPARATION WHEN RUNNING PARALLEL TO GAS MAINS OR SERVICES.
- 3. CONTACT PSE PI INSPECTOR BEFORE WORKING NEAR HIGH PRESSURE OR > 4-IN GAS MAIN: DOWNTOWN SEATTLE: GLENN HUDEN | 206-396-4159 | GLENN.HUDEN@PSE.COM SOUTH SEATTLE: TROY PETERSON | 206-396-0730 | TROY.PETERSON@PSE.COM NORTH SEATTLE: MITCH BALZER | 253-377-9539 | MITCHELL.BALZER@PSE.COM
- 4. COORDINATE WITH PSE CUSTOMER CONSTRUCTION SERVICES AT 1-888-321-7779 AND A PSE PROJECT MANAGER FOR RELOCATION OF GAS MAINS AND SERVICES AS NEEDED.
- 5. LOCATE AND PROTECT ALL GAS FACILITIES IN THE FIELD.
- 6. THE CONTRACTOR MUST COORDINATE VERTICAL ADJUSTMENT OF GAS SERVICES LINES WITH THE GAS COMPANY.

NOTES (1 OF 2)

60% SIP SUBMITTAL

INITIALS AND DATE APPROVED FOR ADVERTISING INITIALS AND DATE EVIEWED: DESIGNED CONST. DEPARTMENT OF FINANCE & ADMINISTRATIVE SERVICES CHECKED PROJ. MGR. SEATTLE, WASHINGTON 20 RECEIVED DRAWN CHECKED REVISED AS BUILT PURCHASING AND CONTRACTING

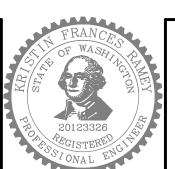



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SHEET 2 OF 36

UNLESS OTHERWISE NOTED:

- 1. THE CONTRACTOR MUST SUBMIT A TREE, VEGETATION, AND SOIL PROTECTION PLAN (TVSPP) IN ACCORDANCE WITH 8-01.3(2)B. ALL TREES NOT IDENTIFIED FOR REMOVAL MUST BE PROTECTED PER STANDARD PLAN 132A, 132B, AND 133, NOTE AND PHOTOGRAPH CONDITIONS AND MATERIALS IN EXISTING TREE PITS TO INCLUDING PAVERS FOR REVIEW BY SDOT URBAN FORESTRY.
- 2. CONTRACTOR MUST NOTIFY THE ENGINEER AND SDOT URBAN FORESTRY 72 HOURS MIN PRIOR TO BOTH DEMOLITION AND EXCAVATION WITHIN THE TREE DRIP LINE.
- 3. AIR SPADING REQUIRED ALL TRENCH EXCAVATION IN THE TREE DRIPLINE MUST BE PERFORMED TO FULL DEPTH AND WIDTH OF THE EXCAVATION WITH AN AIR SPADE UNDER THE SUPERVISION OF AN SDOT URBAN FORESTRY ARBORIST. WATER SLUICING IS NOT ALLOWED. RETAIN ALL STRUCTURAL ROOTS (1) INCH OR GREATER) ACROSS TRENCHES. SDOT URBAN FORESTRY ARBORIST TO DIRECT ROOT PRUNING IF NECESSARY.
- 4. AVOID DAMAGE TO ROOTS DURING CONCRETE SAWCUTTING, DEMOLITION. EXCAVATION, AND TRENCHING.
- 5. REMOVE PAVEMENT WITHIN TREE DRIPLINE BY SAWCUTTING FREQUENTLY (12 TO 18-INCHES O.C.) TO ALLOW SMALL PIECES TO BREAK OUT. IF PART OF PAVEMENT IS FIRMLY ATTACHED TO ROOTS GREATER THAN 1-INCH, PRUNE ROOTS UNDER SUPERVISION OF SDOT URBAN FORESTRY ARBORIST.
- 6. PROTECT TREE ROOTS AFTER EXPOSURE DUE TO CONCRETE REMOVAL, AIR SPADING, AND OTHER CONSTRUCTION ACTIVITY. ONLY EXCAVATE AND EXPOSE AREA OF ROOTS THAT CAN BE BACKFILLED AND COVERED WITHIN ONE WORKING DAY. MAINTAIN MOIST SUBGRADE CONDITION UNTIL NEW CONCRETE IS INSTALLED.
- 7. ALL DISTURBED SOILS MUST BE AMENDED PER STANDARD PLAN 142 AND SECTION 8-02 OF THE STANDARD SPECIFICATIONS UNLESS DISTURBANCE IS LIMITED TO WITHIN ONE FOOT OF A CURB OR SIDEWALK, THREE FEET OF A UTILITY STRUCTURE (E.G. WATER METER, UTILITY POLE, HAND HOLE, ETC.), OR THE DRIPLINE OF AN EXISTING TRFF.
- 8. COORDINATE TREE REMOVAL AND TRIMMING ON PRIVATE PROPERTY WITH PROPERTY OWNER.

DRAINAGE CB AND INLET NOTES

UNLESS OTHERWISE NOTED:

- 1. CATCH BASIN CONNECTIONS AND INLET CONNECTIONS MUST BE 8-IN DIAMETER. PIPE MUST BE CEMENT MORTAR LINED DUCTILE IRON CLASS 50 (MIN) PER SECTION 9-05.3. FITTINGS MUST BE CEMENT MORTAR LINED DUCTILE IRON. JOINTS MUST BE RUBBER GASKET, PUSH-ON, OR MECHANICAL.
- 2. BEDDING FOR DUCTILE IRON PIPE MUST BE CLASS D.
- 3. TRENCH BACKFILL MUST BE MINERAL AGGREGATE TYPE 17. NATIVE MATERIAL WILL NOT BE ALLOWED.
- 4. CATCH BASIN CONNECTIONS MUST BE PLACED AT A MINIMUM SLOPE OF 2% AND A MAXIMUM SLOPE OF 100% PER STANDARD PLAN 261 AND SPECIFICATION 7-08.3(4).
- 5. INLET CONNECTIONS MUST BE PLACED AT A MINIMUM SLOPE OF 5% AND A MAXIMUM SLOPE OF 50% PER SPECIFICATION 7-08.3(5).
- 6. CATCH BASINS AND INLETS MUST BE LOCATED PER STANDARD PLAN 260A AND 260B.
- 7. TELEVISION INSPECTION OF CATCH BASIN CONNECTIONS MUST BE PER SPECIFICATION 7-17.3(G).
- 8. CONTRACTORS ARE NOT ALLOWED TO CORE INTO MAINS OR STRUCTURES WITHOUT PRIOR APPROVAL FROM SPU. TO SCHEDULE CORE TAPS, CONTACT SPU AT 206-615-0511 A MINIMUM OF 2 BUSINESS DAYS IN ADVANCE. SPU SHALL BE ONSITE PRIOR TO THE START OF CONTRACTOR PERFORMED CORE TAP. CONTRACTORS PERFORMING CORE TAPS MUST PROVIDE THE COUPON OF REMOVED MATERIAL TO SPU.

WATER SERVICE NOTES UNLESS OTHERWISE NOTED:

- 1. ALL UNDERGROUND WATER SERVICE PIPING ON PRIVATE PROPERTY MUST BE INSPECTED PRIOR TO BACKFILLING TRENCH. FOR INFORMATION AND INSPECTION, CALL 206-684-5800.
- 2. WATER SERVICE TRANSFERS FROM THE EXISTING MAIN TO THE NEW MAIN WILL BE MADE BY SPU WITH CONTRACTOR ASSISTANCE.
- 3. WATER SERVICE RELOCATIONS, AS SHOWN ON THE PLANS AND CALLED OUT ON SERVICE LIST. WILL BE MADE BY SPU WITH CONTRACTOR
- 4. REPLACEMENT OF WATER METER BOXES IN DRIVING SURFACES WITH FRAMES AND COVERS HAVING INSPECTION COVERS (F&C W/IC) ARE CALLED OUT ON THE SERVICE LIST AND MUST BE PLACED BY CONTRACTOR.
- 5. WATER SERVICE RENEWALS, FROM NEW MAIN TO METER TAIL- RUN AND UNION CONNECTION. WILL BE PERFORMED BY SPU WITH CONTRACTOR ASSISTANCE.
- 6. WHERE WORK CROSSES THE LOCATION OF EXISTING WATER SERVICES, THE CONTRACTOR MUST COORDINATE WORK WITH SPU WHO WILL PROVIDE AN OFFSET IN THE SERVICE LINE AHEAD OF THE WORK.
- 7. SERVICE TRANSFERS: CONTRACTOR MUST ASSIST SPU WITH WATER SERVICE CONNECTION TRANSFERS PER STANDARD SPECIFICATION SECTION 7-15. FOR SERVICES LARGER THAN 2 INCHES, CONTRACTOR MUST SUPPLY PIPE. FITTINGS AND VALVES. FOR SERVICES 2 INCHES AND SMALLER SPU WILL PROVIDE ALL MATERIALS.
- 8. CONTRACTOR MUST ASSIST SPU WITH WATER SERVICE CONNECTIONS PER STANDARD SPECIFICATION SECTION 7-11.3(9)C. CONTRACTOR MUST SUPPLY AND INSTALL PIPE, FITTINGS AND VALVES FOR SERVICES GREATER THAN 2 INCHES. SPU WILL PROVIDE ALL MATERIALS FOR SERVICES 2 INCHES AND SMALLER.

BIORETENTION NOTES UNLESS OTHERWISE NOTED:

SCHEDULED INSPECTION.

- 1. BIORETENTION CELLS MUST BE PER STANDARD PLAN 292 OR 293A AND SPECIFICATION 7-21 WITH GRADING AND BOTTOM AREA AS SHOWN ON THE APPROVED PLAN. SUBGRADE MUST BE SCARIFIED 4 INCHES MINIMUM PRIOR TO PLACEMENT OF BIORETENTION SOIL. IMPORTED BIORETENTION SOIL MUST BE PER SPECIFICATION 9-14.1(4).
- 2. BIORETENTION LANDSCAPING MUST BE AS SHOWN ON THE APPROVED PLAN. CHANGES TO THE APPROVED LANDSCAPING PLAN REQUIRE SUBMITTAL OF A REVISED LANDSCAPING PLAN.
- 3. BIORETENTION FACILITIES SPECIAL INSPECTOR(S) AS DESCRIBED IN GSI CONSTRUCTION INSPECTION REQUIREMENTS ARE IDENTIFIED AND ATTEND A PRECONSTRUCTION MEETING WITH THE CITY OF SEATTLE DEPARTMENT OF TRANSPORTATION.
- 4. PROTECT THE INFILTRATIVE CAPACITY OF THE SOIL PER SPECIFICATION 3(2)B TREE, VEGETATION AND SOIL PROTECTION PLAN.
- 5. PRIOR TO PLACING BIORETENTION SOILS, CELLS MUST BE INSPECTED AND APPROVED BY THE BIORETENTION FACILITIES SPECIAL INSPECTOR. ALL SOIL MIX TICKETS MUST BE SUBMITTED AT OR BEFORE THIS
- 6. PRIOR TO PLACING MULCH, CELLS MUST BE INSPECTED AND APPROVED BY THE BIORETENTION FACILITIES SPECIAL INSPECTOR. ARBORIST WOOD MULCH MUST BE PER SPECIFICATION 9-14.4(4).
- 7. FINISHED GRADE MUST BE ONE INCH BELOW WALKS AND CURBS.
- 8. AFTER PLANTING. CELLS MUST BE INSPECTED AND APPROVED BY THE BIORETENTION FACILITIES SPECIAL INSPECTOR.
- 9. SUB-SURFACE DRAIN (SSD) PIPE AND FITTINGS, IF REQUIRED, MUST BE PER STANDARD PLAN NO. 291. BEDDING MUST BE MINERAL AGGREGATE TYPE 26 PER STANDARD PLAN 293A.
- 10. PROTECT ALL BIORETENTION CELLS FROM ACCUMULATING SEDIMENTS AND COMPACTION. ANY IMPACTED BIORETENTION CELL MUST BE RESTORED TO FULLY FUNCTIONING CONDITION BY REMOVAL OF SEDIMENT LADEN SOILS, OVER EXCAVATION AS APPROVED BY BIORETENTION FACILITIES SPECIAL INSPECTOR AND REPLACEMENT WITH NEW BIORETENTION SOIL.
- 11. SUBMIT THE GREEN STORMWATER INFRASTRUCTURE (GSI) PROJECT INFORMATION FORM AND SIGNED AND STAMPED FINAL CLOSE OUT LETTERS DOCUMENTING COMPLETION OF THE SPECIAL INSPECTION TO THE SDOT STREET USE INSPECTOR.

MAINLINE CONVEYANCE AND DETENTION NOTES

UNLESS OTHERWISE NOTED:

- 1. MAINLINE PIPE, CULVERT PIPE AND DETENTION PIPE MUST BE AS APPROVED BY SEATTLE PUBLIC UTILITIES (SPU) AND AS SHOWN ON THE PROFILE.
 - A. VCP MUST BE PER SPECIFICATION 9-05.5.
 - B. DIP MUST BE PER SPECIFICATION 9-05.3. FITTINGS MUST BE CEMENT MORTAR LINED DUCTILE IRON. JOINTS MUST BE RUBBER GASKET, PUSH-ON OR MECHANICAL
 - C. RCP MUST BE PER SPECIFICATION 9-05.2.
 - D. POLYPROPYLENE PIPE PER SPECIFICATION 9-05.17. POLYPROPYLENE PIPE DETENTION, FOR PIPE DIAMETERS 30" AND GREATER MUST BE TRIPLE WALL (SMOOTH INTERIOR), CORRUGATED STRUCTURAL CORE, AND SMOOTH EXTERIOR) POLYPROPYLENE PIPE. ALL JOINTS MUST BE BELL AND SPIGOT AND CONFORM TO ASTM D3212.
- 2. BEDDING MUST BE CLASS B FOR ALL PIPE. EXCEPT DUCTILE IRON PIPE THAT IS LESS THAN 30-INCH ID. WHICH MAY BE CLASS D. SEE STANDARD PLAN NO. 285 AND SPECIFICATION 7-17.3(1). CONTROLLED DENSITY FILL (CDF) MUST NOT BE IN CONTACT WITH THE PIPE. BEDDING MATERIAL MUST BE:
 - A. MINERAL AGGREGATE TYPE 22 FOR VCP AND POLYPROPYLENE
 - B. MINERAL AGGREGATE TYPE 9 FOR RCP.
 - C. SELECT NATIVE OR MINERAL AGGREGATE TYPE 9 OR MINERAL AGGREGATE TYPE 22 FOR DIP.
- 3. TEES ON NEW PIPE LESS THAN 24" IN DIAMETER MUST BE PREFABRICATED. ALL NEW CONNECTIONS TO EXISTING MAINLINES OR STRUCTURES, OR CONNECTIONS TO NEW MAINLINES WITHOUT PREFABRICATED TEES, MUST BE PER SPU CORE TAP PROCEDURES.
- 4. DETENTION PIPE AND FLOW CONTROL STRUCTURES MUST BE PER STANDARD PLAN NO. 270, 270A AND 272B.
- 5. ALL PIPELINES AND APPURTENANCES MUST BE CLEANED AND TESTED AFTER BACKFILLING PER SPECIFICATION 7-17.3(3). DEFLECTION TESTING OF FLEXIBLE PIPE MUST BE NO LESS THAN 30 DAYS AFTER BACKFILL AND PRIOR TO PAVING PER SPECIFICATION 7-17.3(3)F. TELEVISION INSPECTION OF MAINLINE MUST BE PER SPECIFICATION 7-17.3(3)G.
- 6. WHERE A NEW PIPE CLEARS AN EXISTING OR NEW UTILITY BY 6" OR LESS. POLYETHYLENE PLASTIC FOAM MUST BE PLACED AS A CUSHION BETWEEN THE UTILITIES PER SPECIFICATION 1-07.17(2).
- 7. PIPE 12" DIAMETER AND LARGER TO BE ABANDONED MUST BE FILLED WITH A PUMPABLE, FLOWABLE CEMENT SLURRY. SEE SPECIFICATION 2-02.3(5).

ABBREVIATIONS LEGEND

FOR ADDITIONAL LEGEND INFORMATION: SEE COS STD PLANS (002 SERIES) FOR STANDARD ABBREVIATIONS

TIGHTLINE SOLID WALL STORM DRAIN (UNDERDRAIN PIPE)

SLOTTED STORM DRAIN (UNDERDRAIN PIPE) PER COS STD PLAN 293b SSD

UNO UNLESS OTHERWISE NOTED

R/W. ROW RIGHT-OR-WAY

BIORETENTION CELL BRC ΕX EXISTING

TOC TOP OF CURB ELEVATION

BOTTOM OF CURB ELEVATION. GUTTER ELEVATIONS

NOTES (2 OF 2)

60% SIP SUBMITTAL

12. WATER TO ENSURE VEGETATION SURVIVAL. INITIALS AND DATE INITIALS AND DATE APPROVED FOR ADVERTISING EVIEWED: DESIGNED CONST. DEPARTMENT OF FINANCE & ADMINISTRATIVE SERVICES CHECKED PROJ. MGR. SEATTLE, WASHINGTON 20 ECEIVED DRAWN CHECKED EVISED AS BUILT PURCHASING AND CONTRACTING






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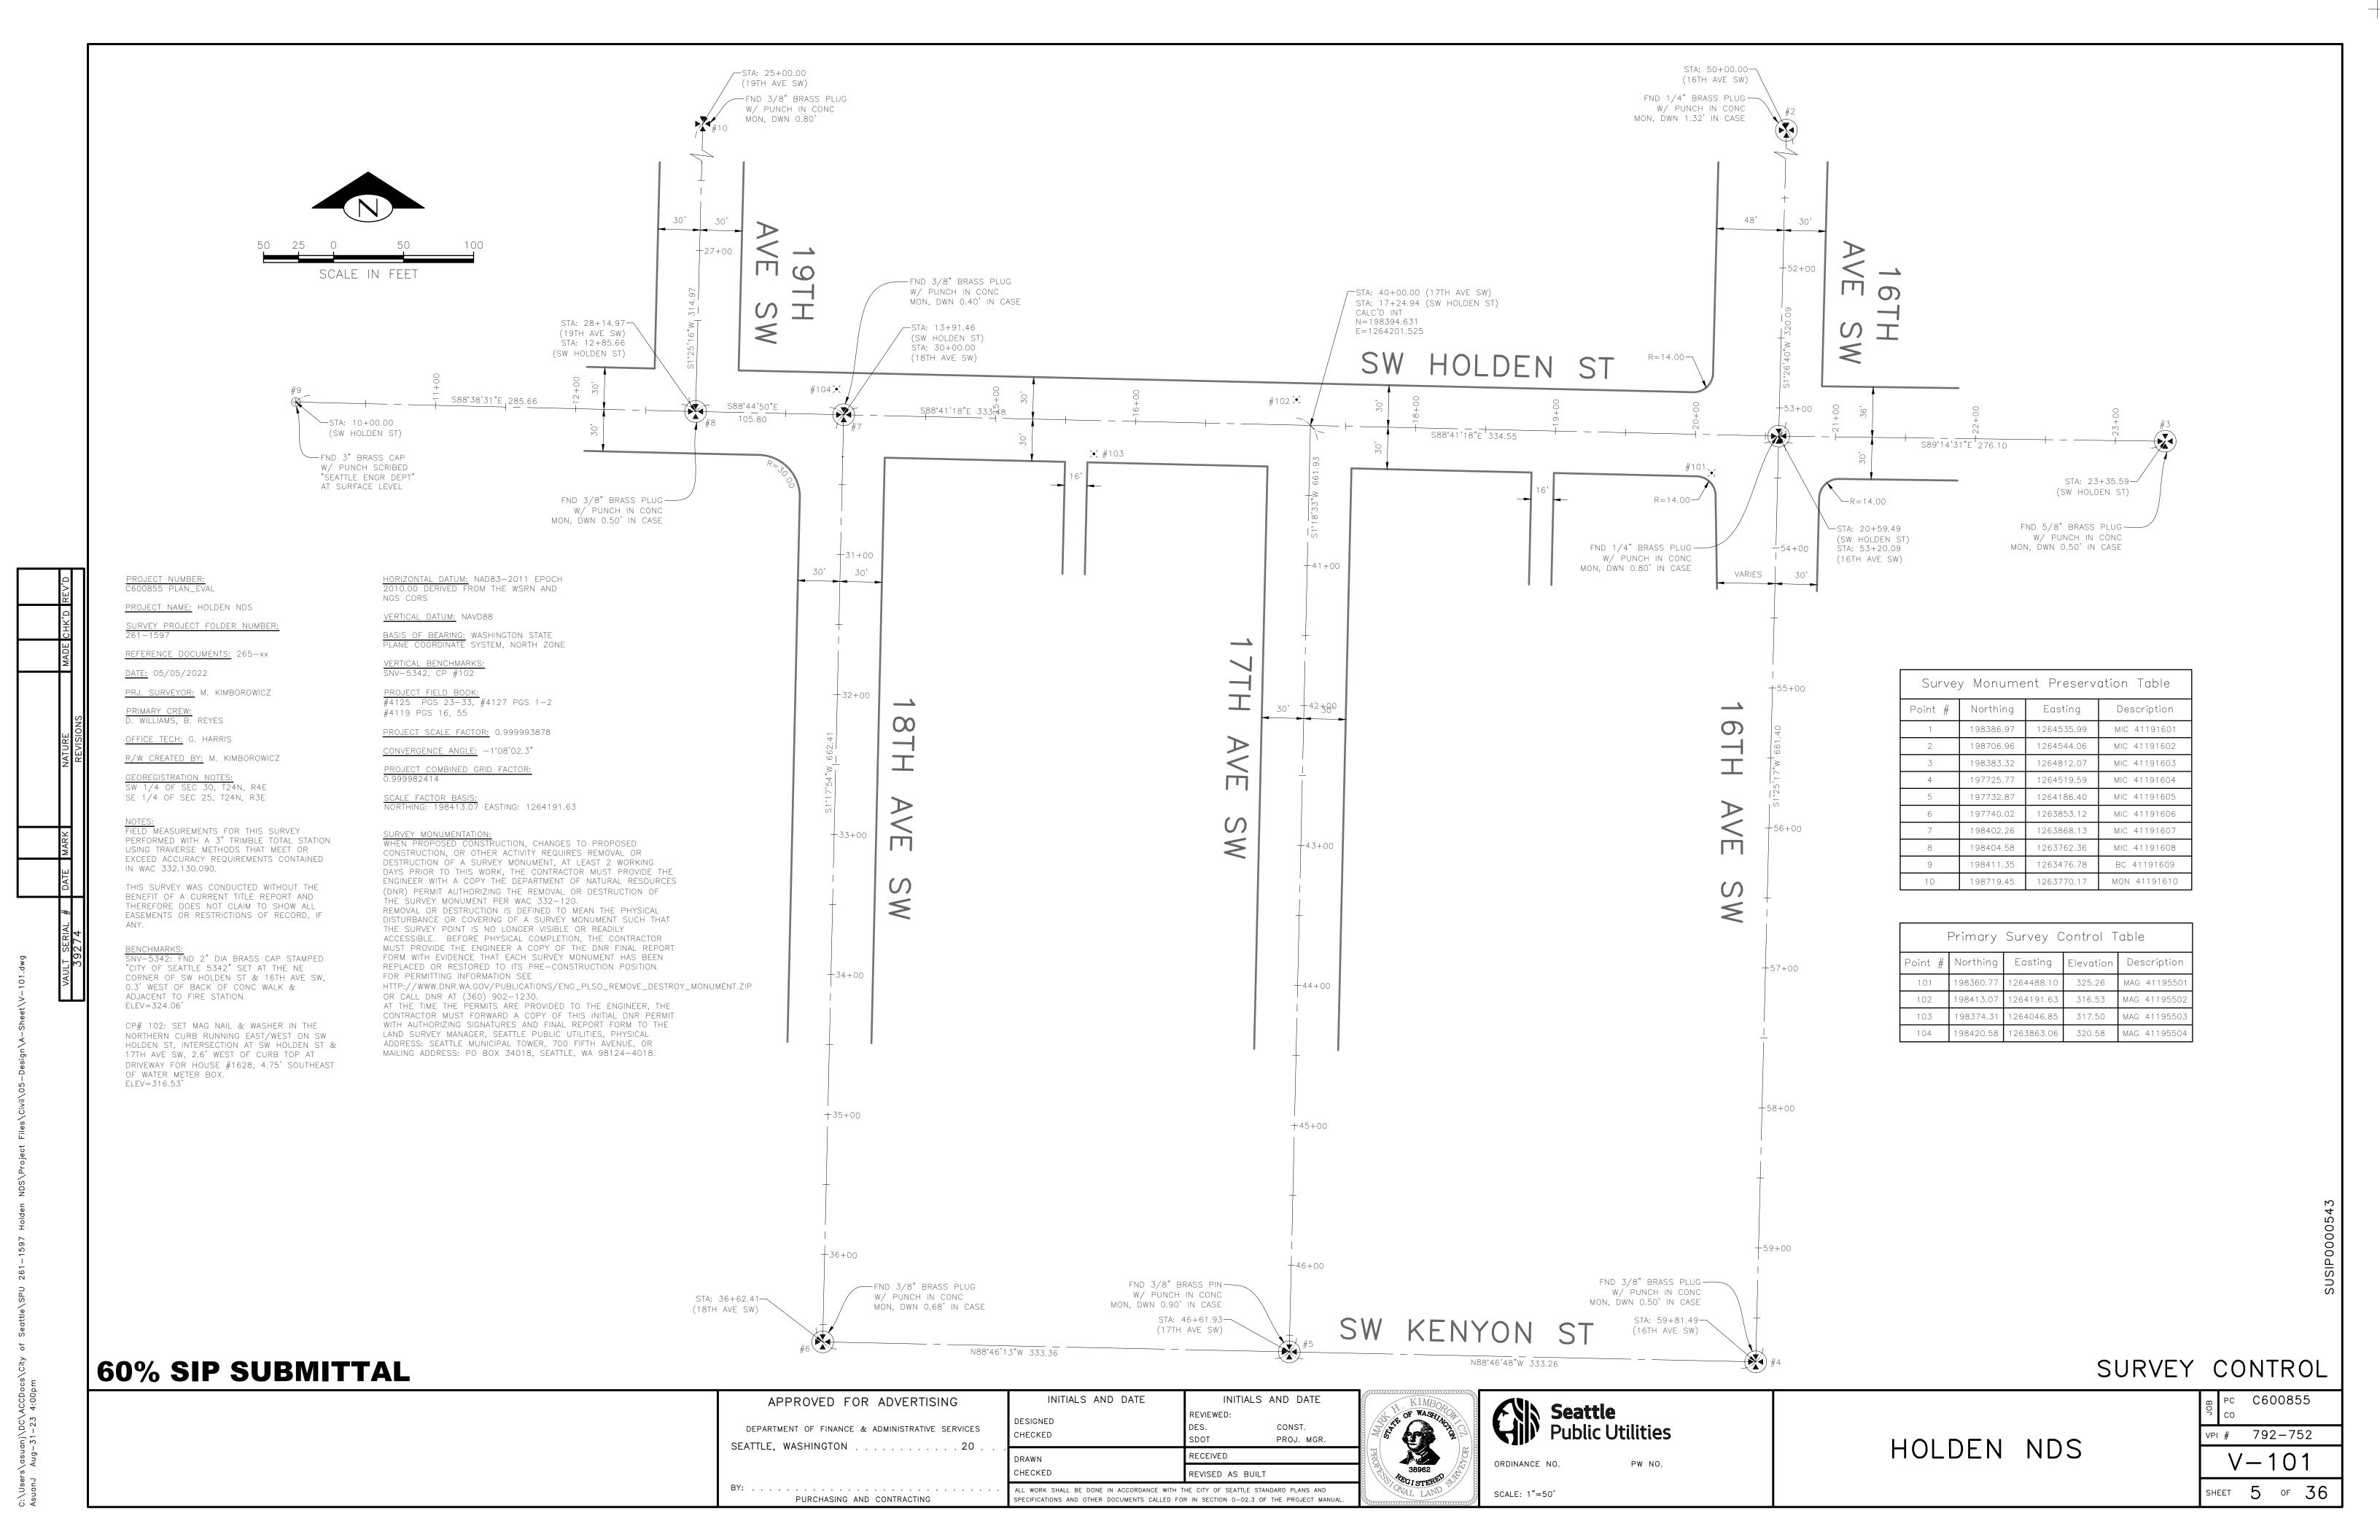
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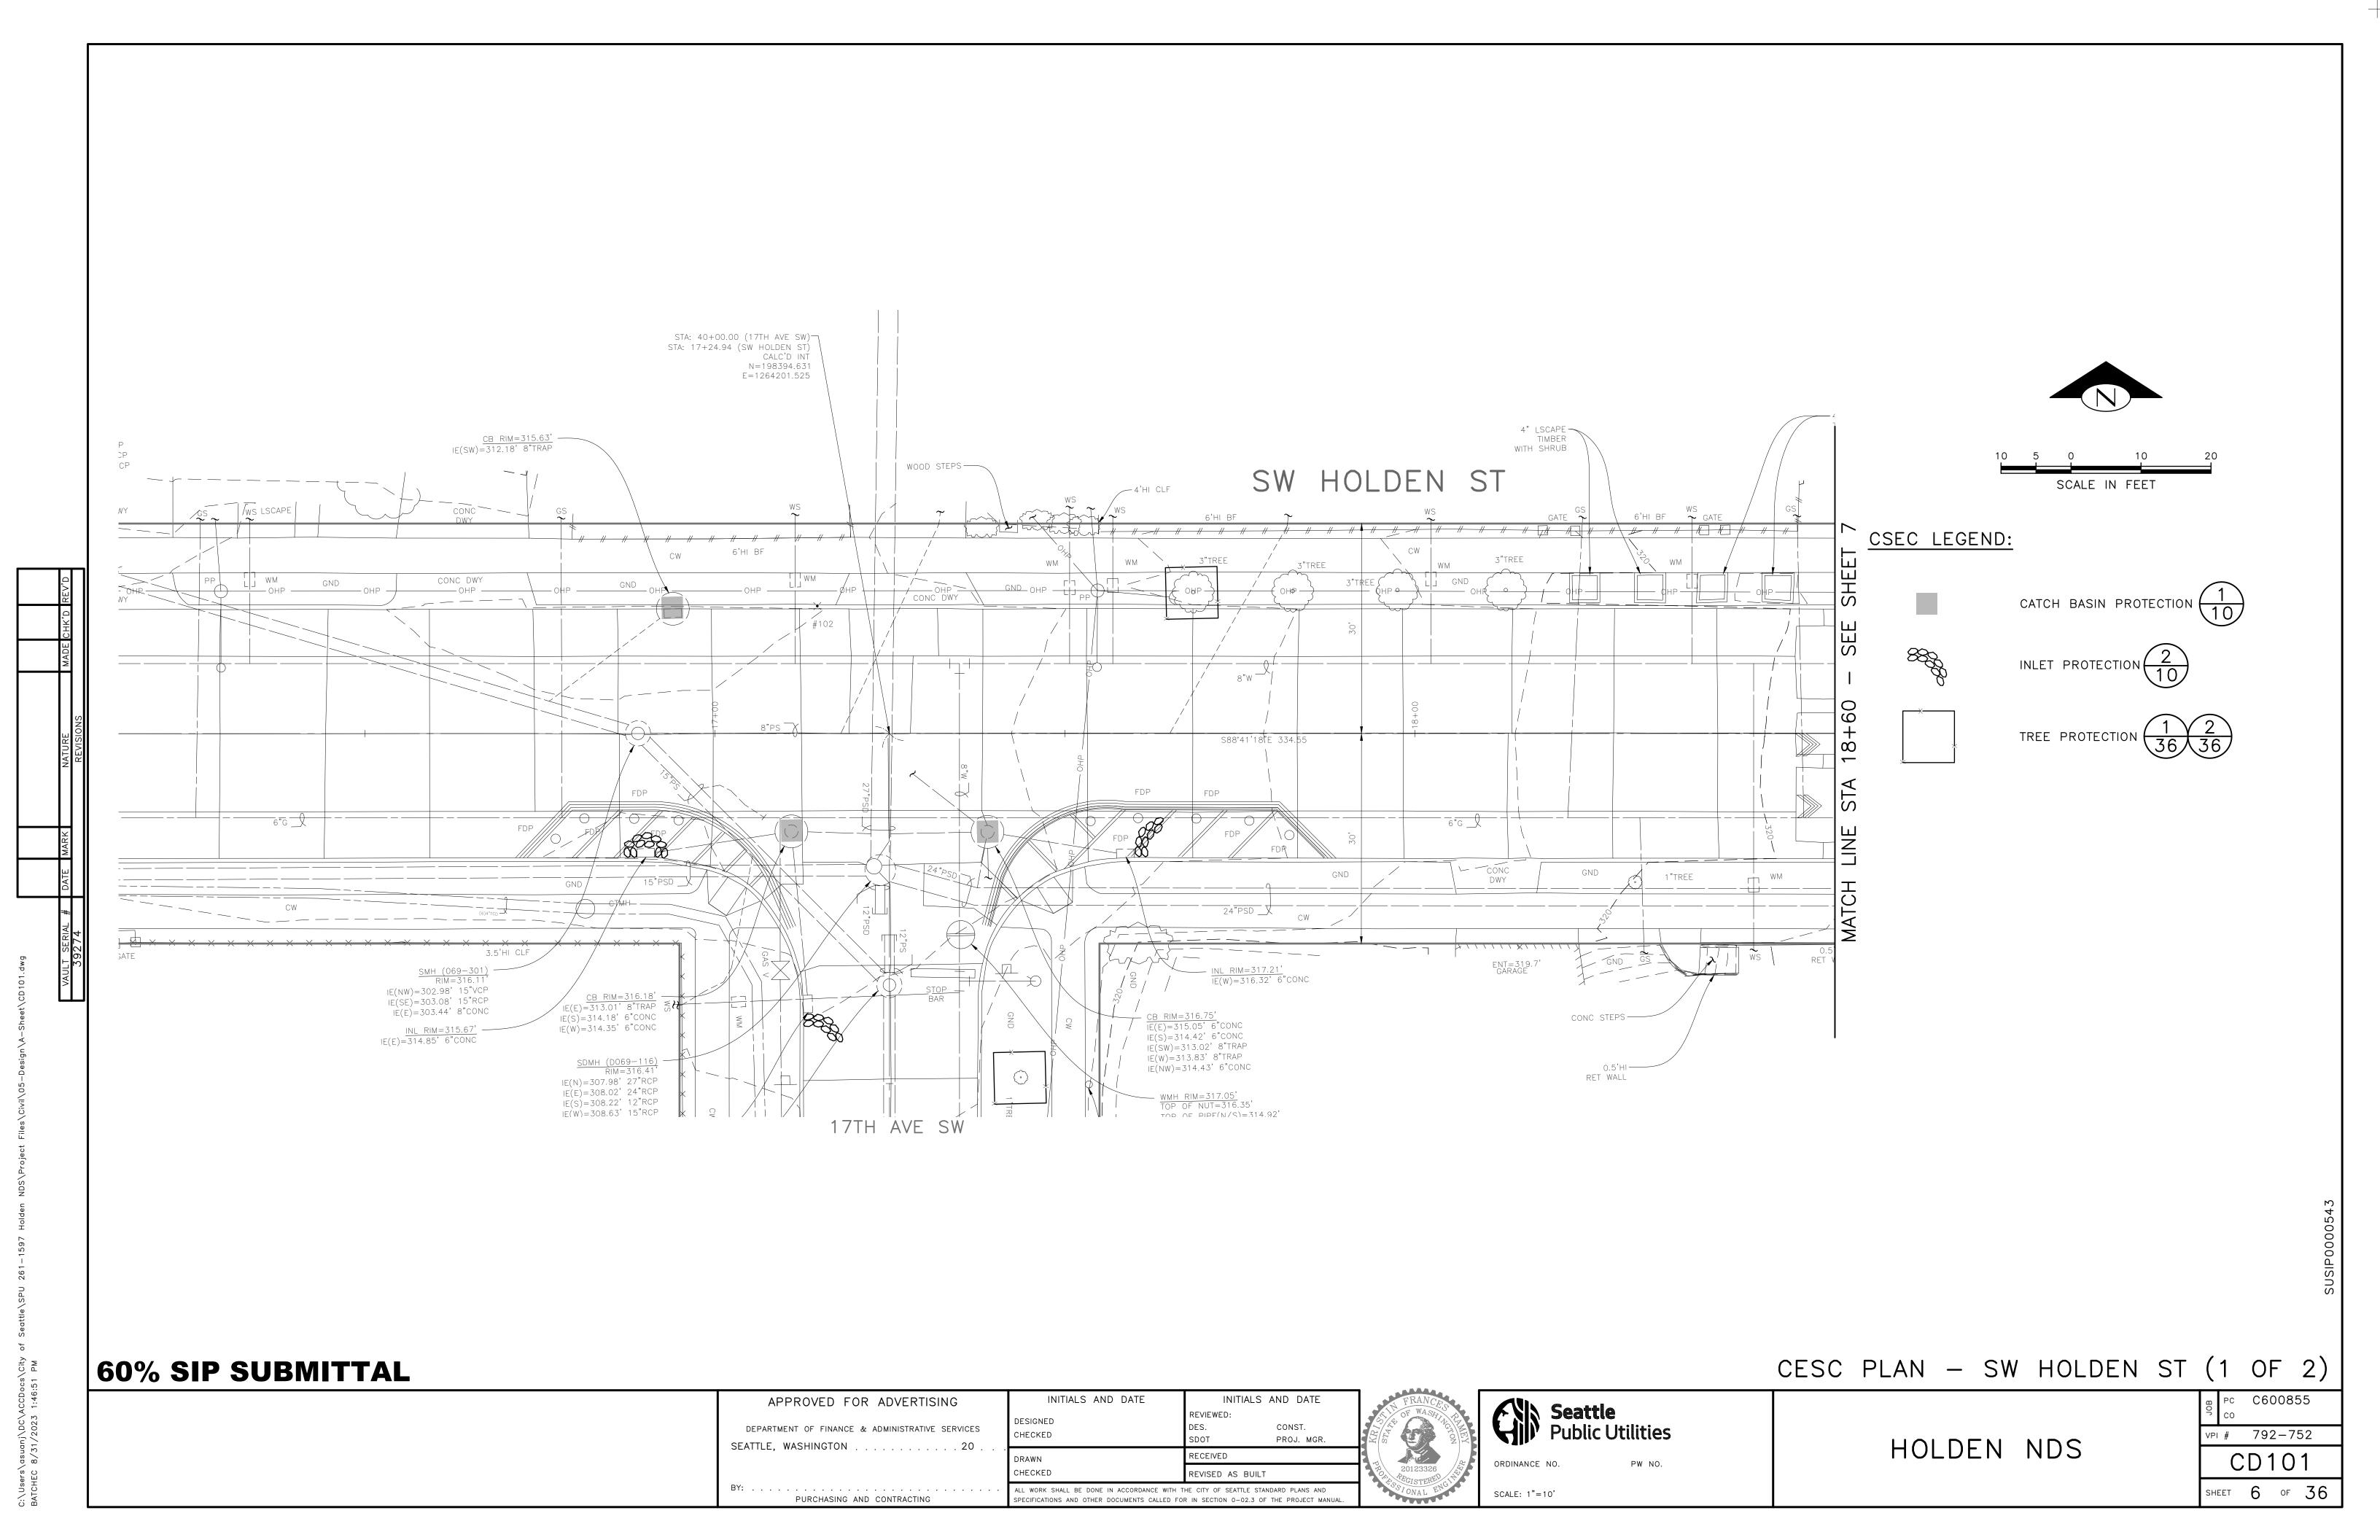
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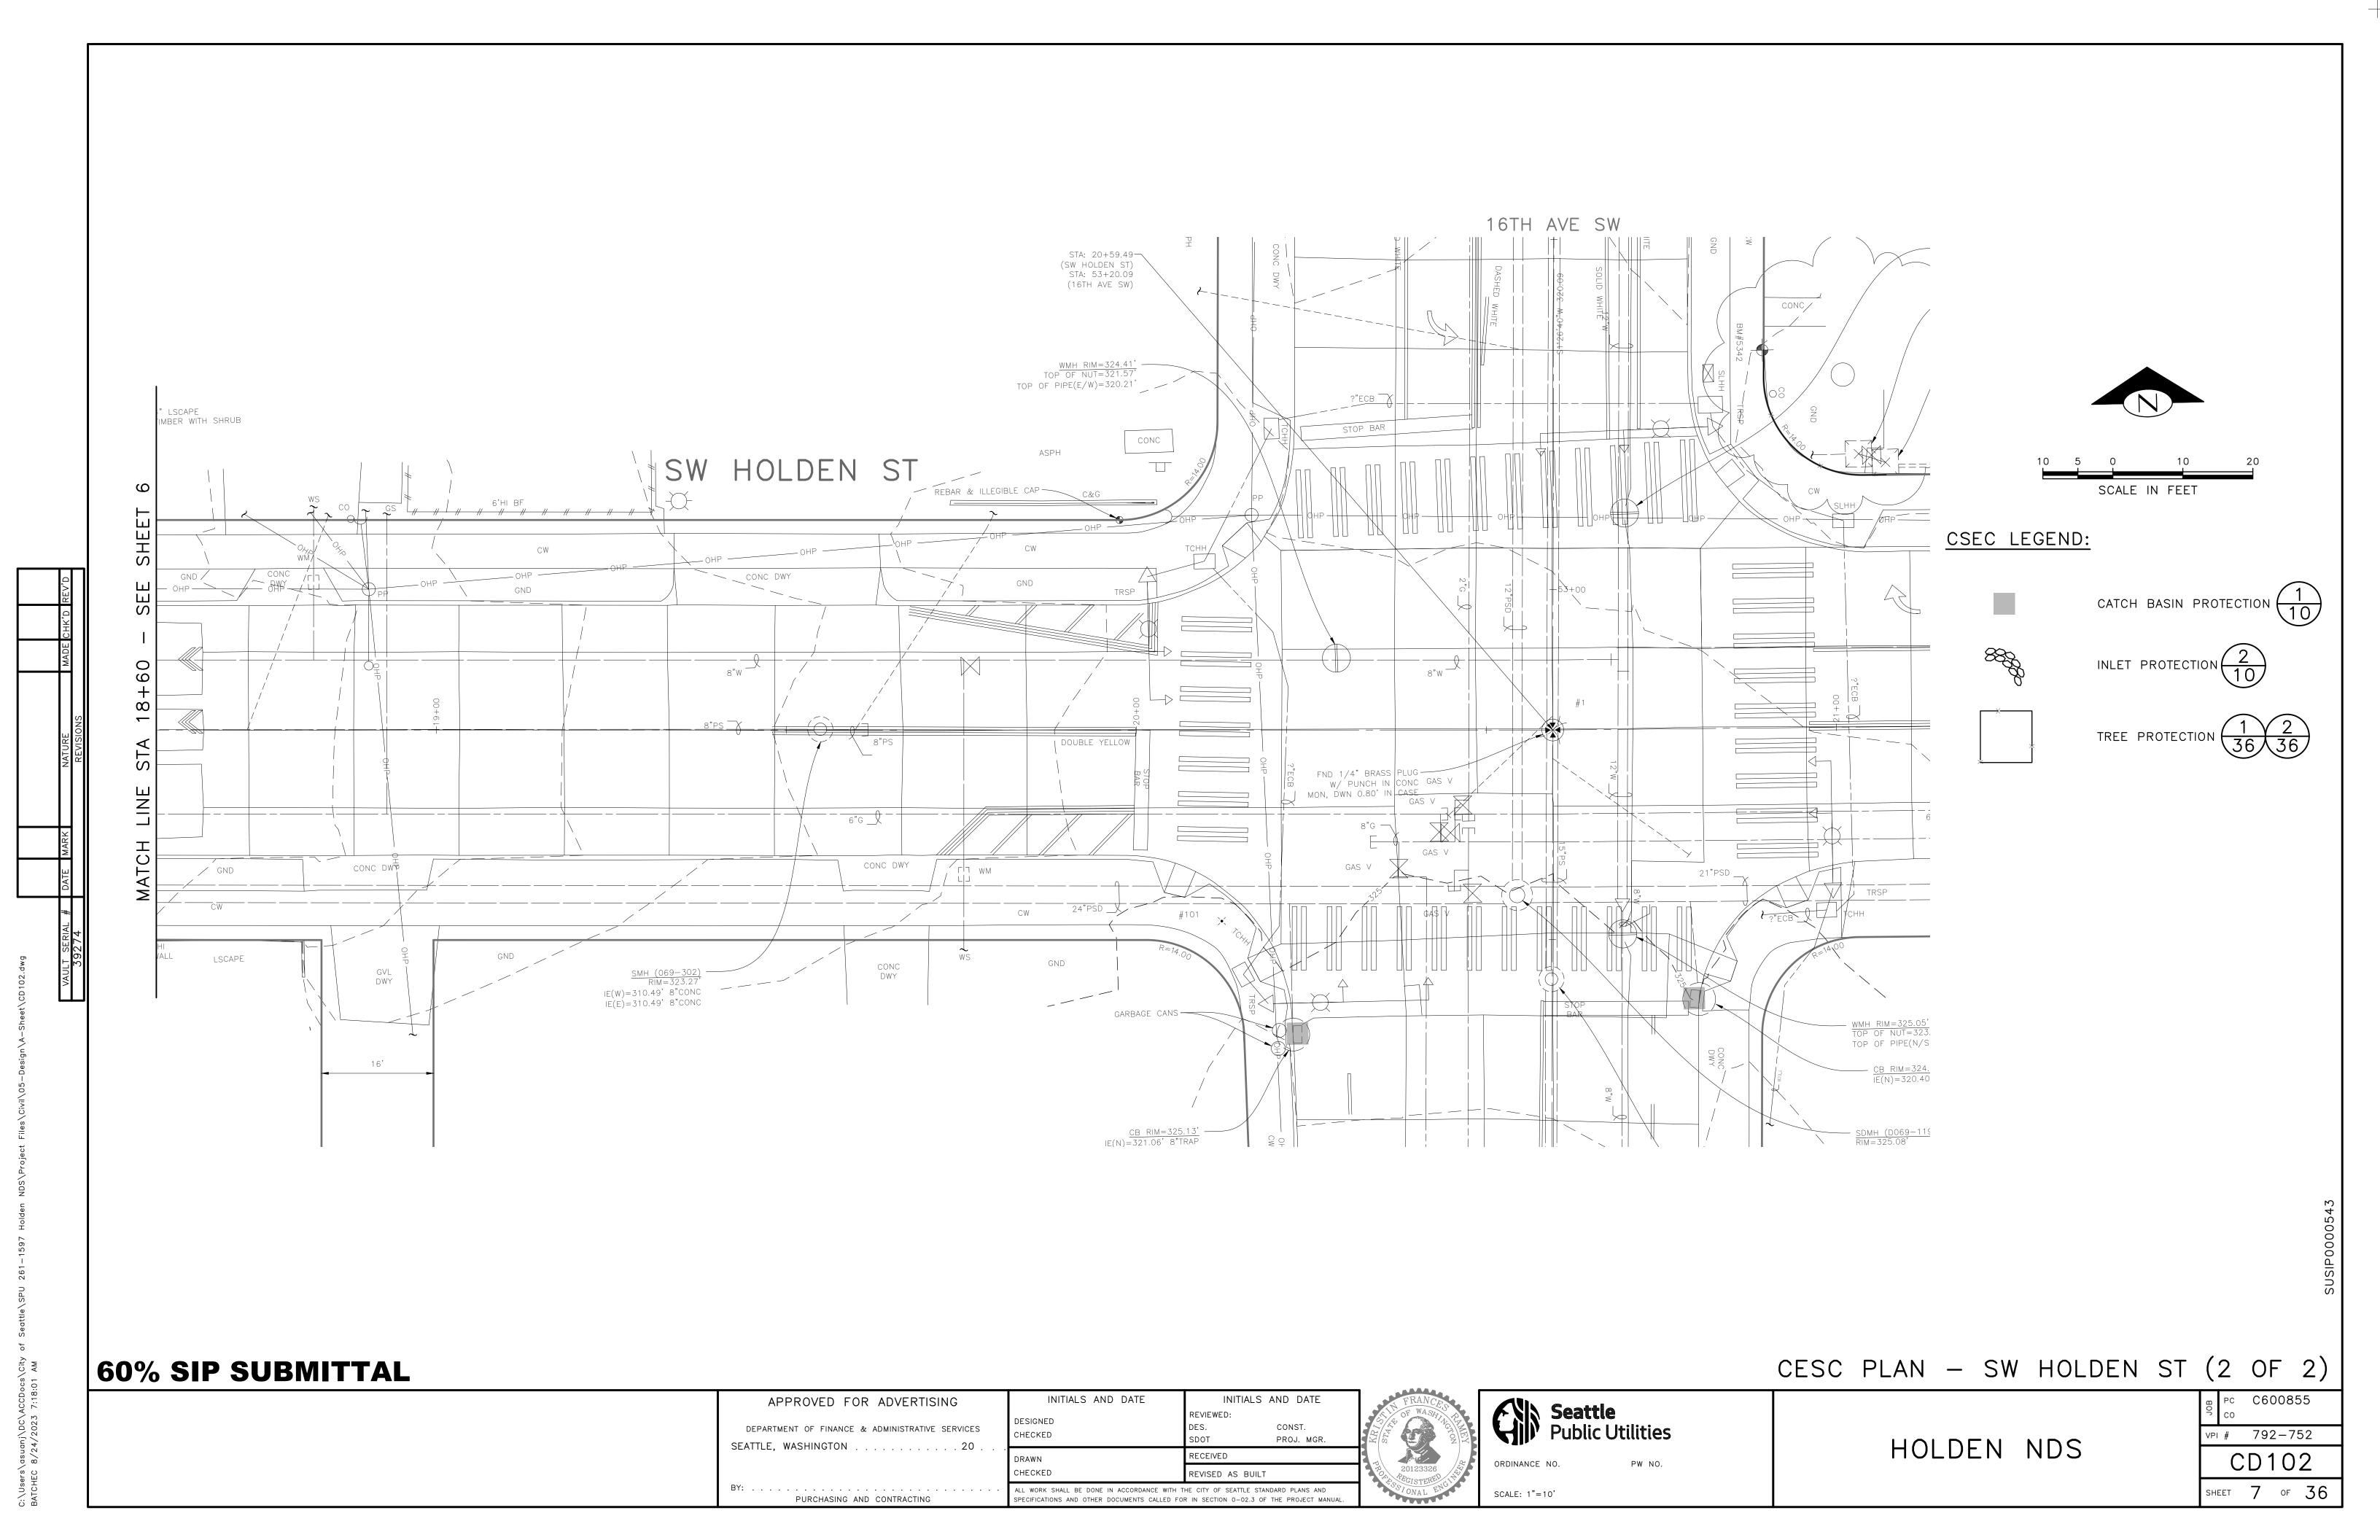
G - 003


SHEET 3 OF 36







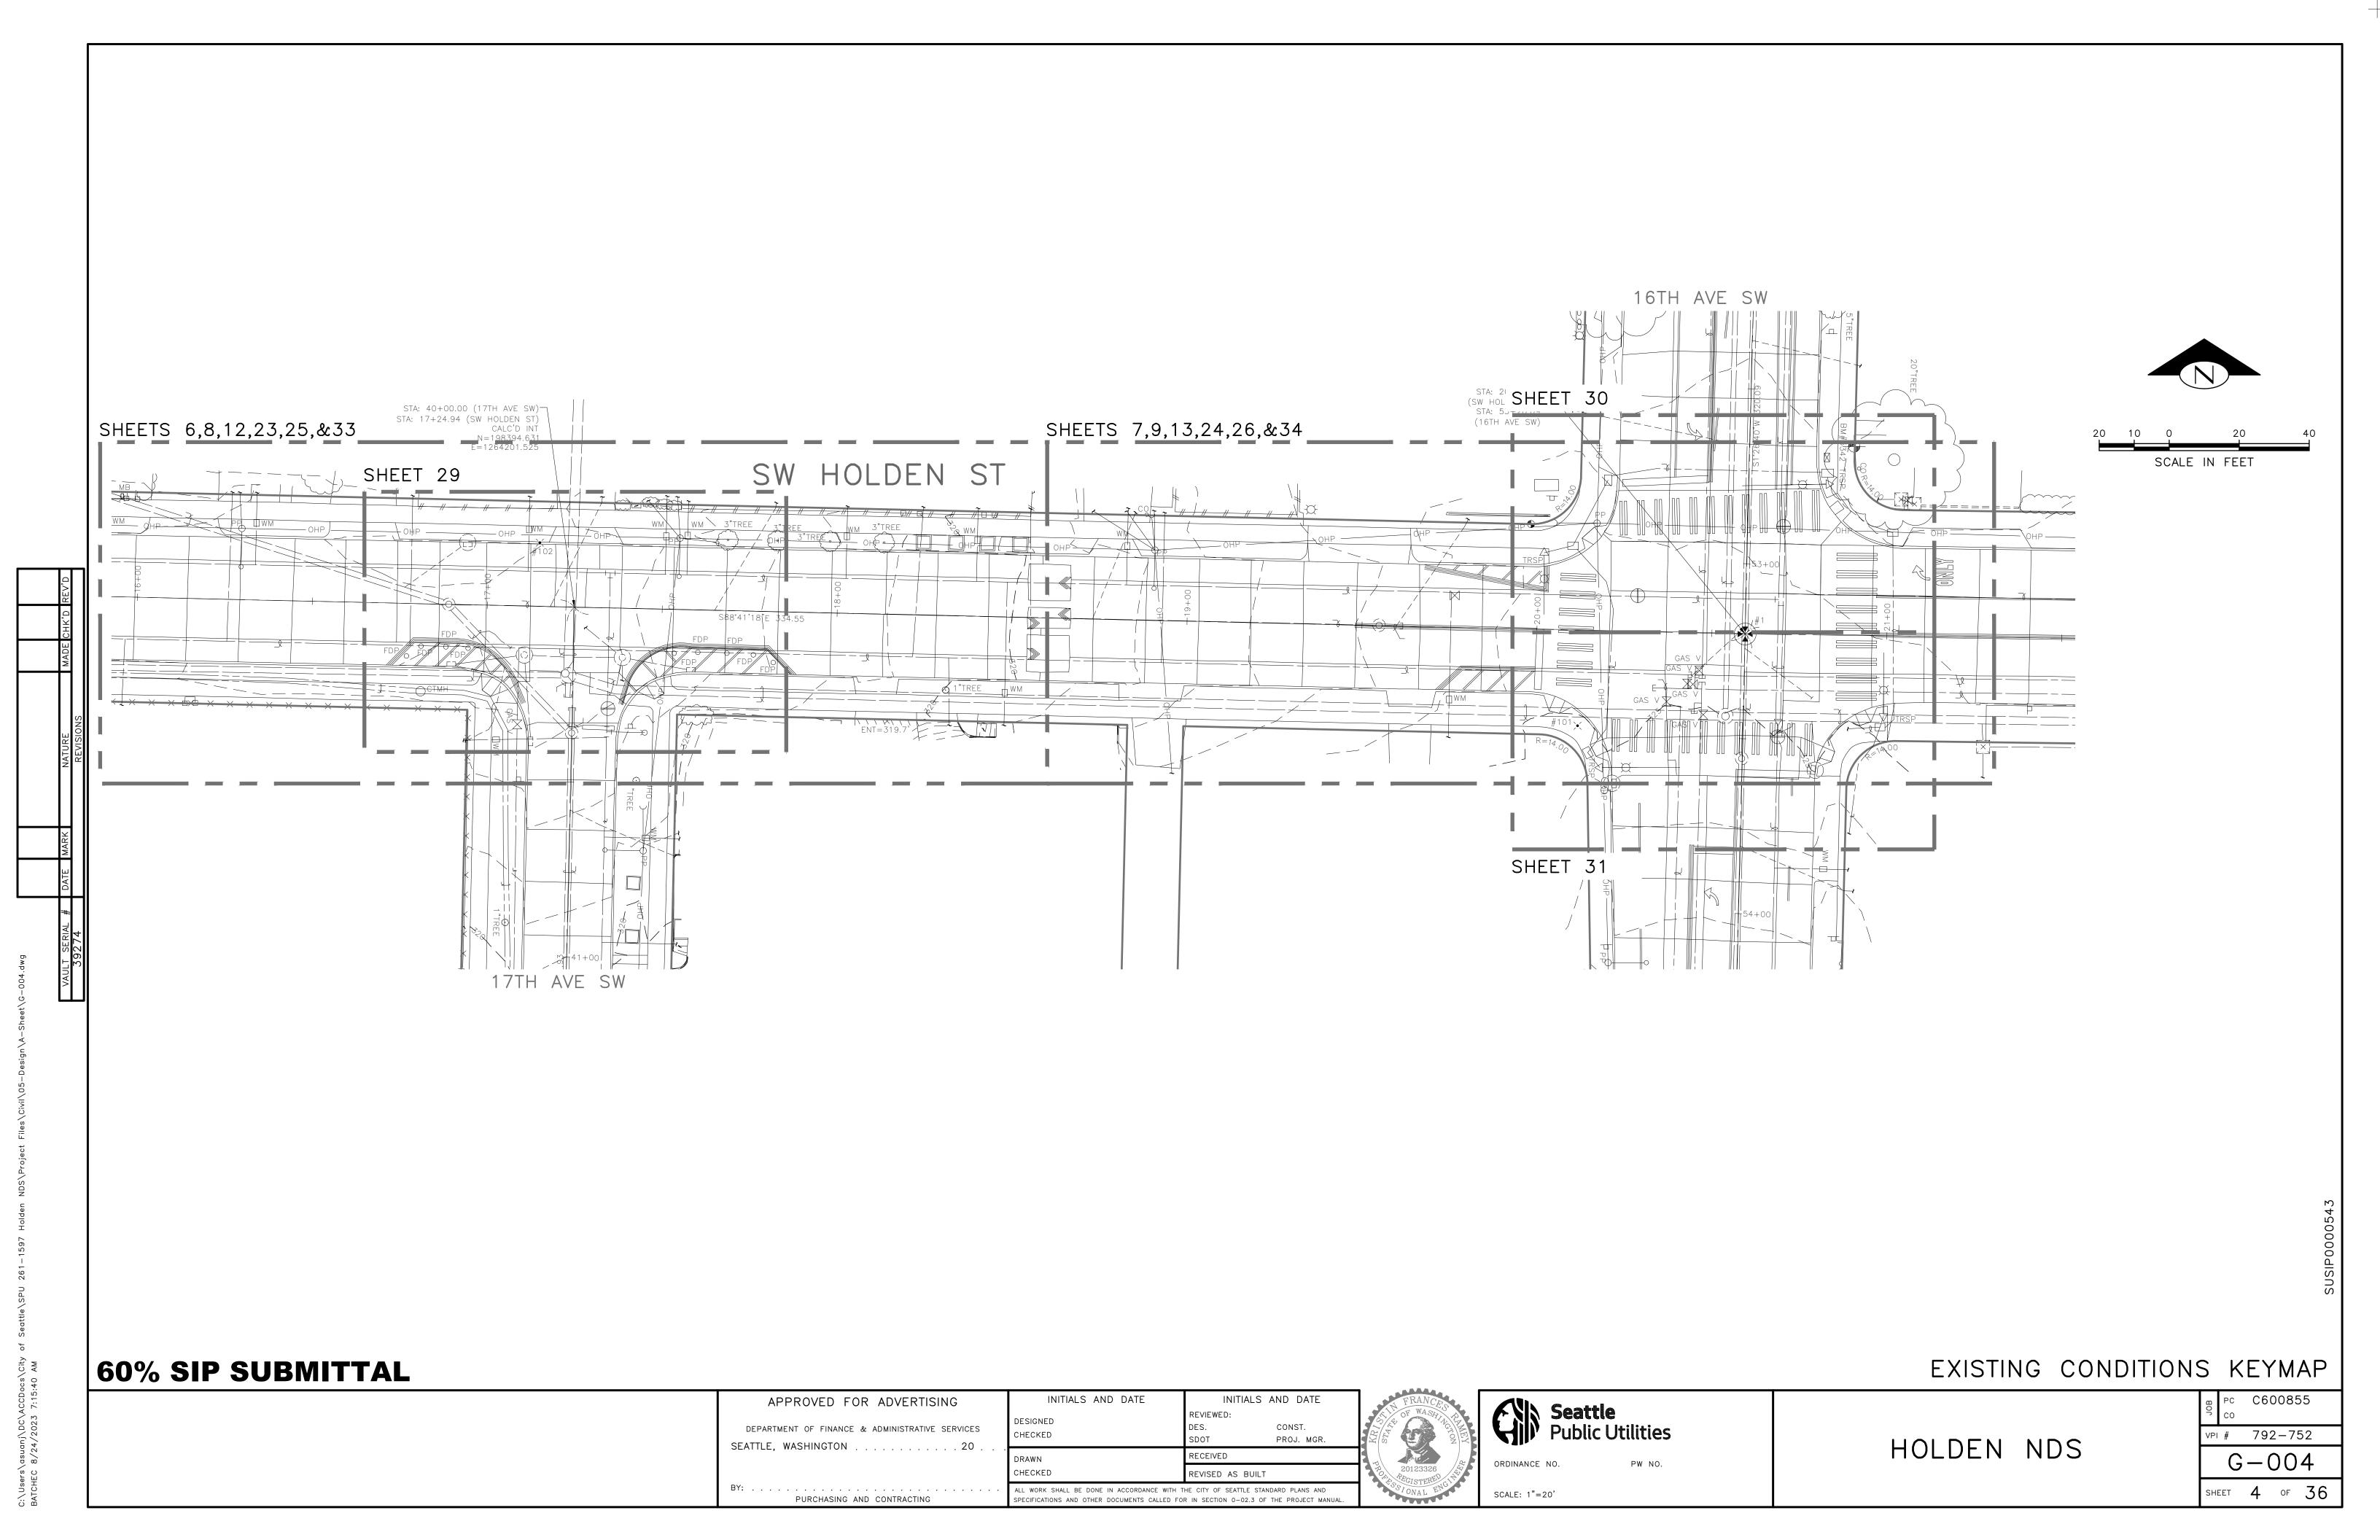


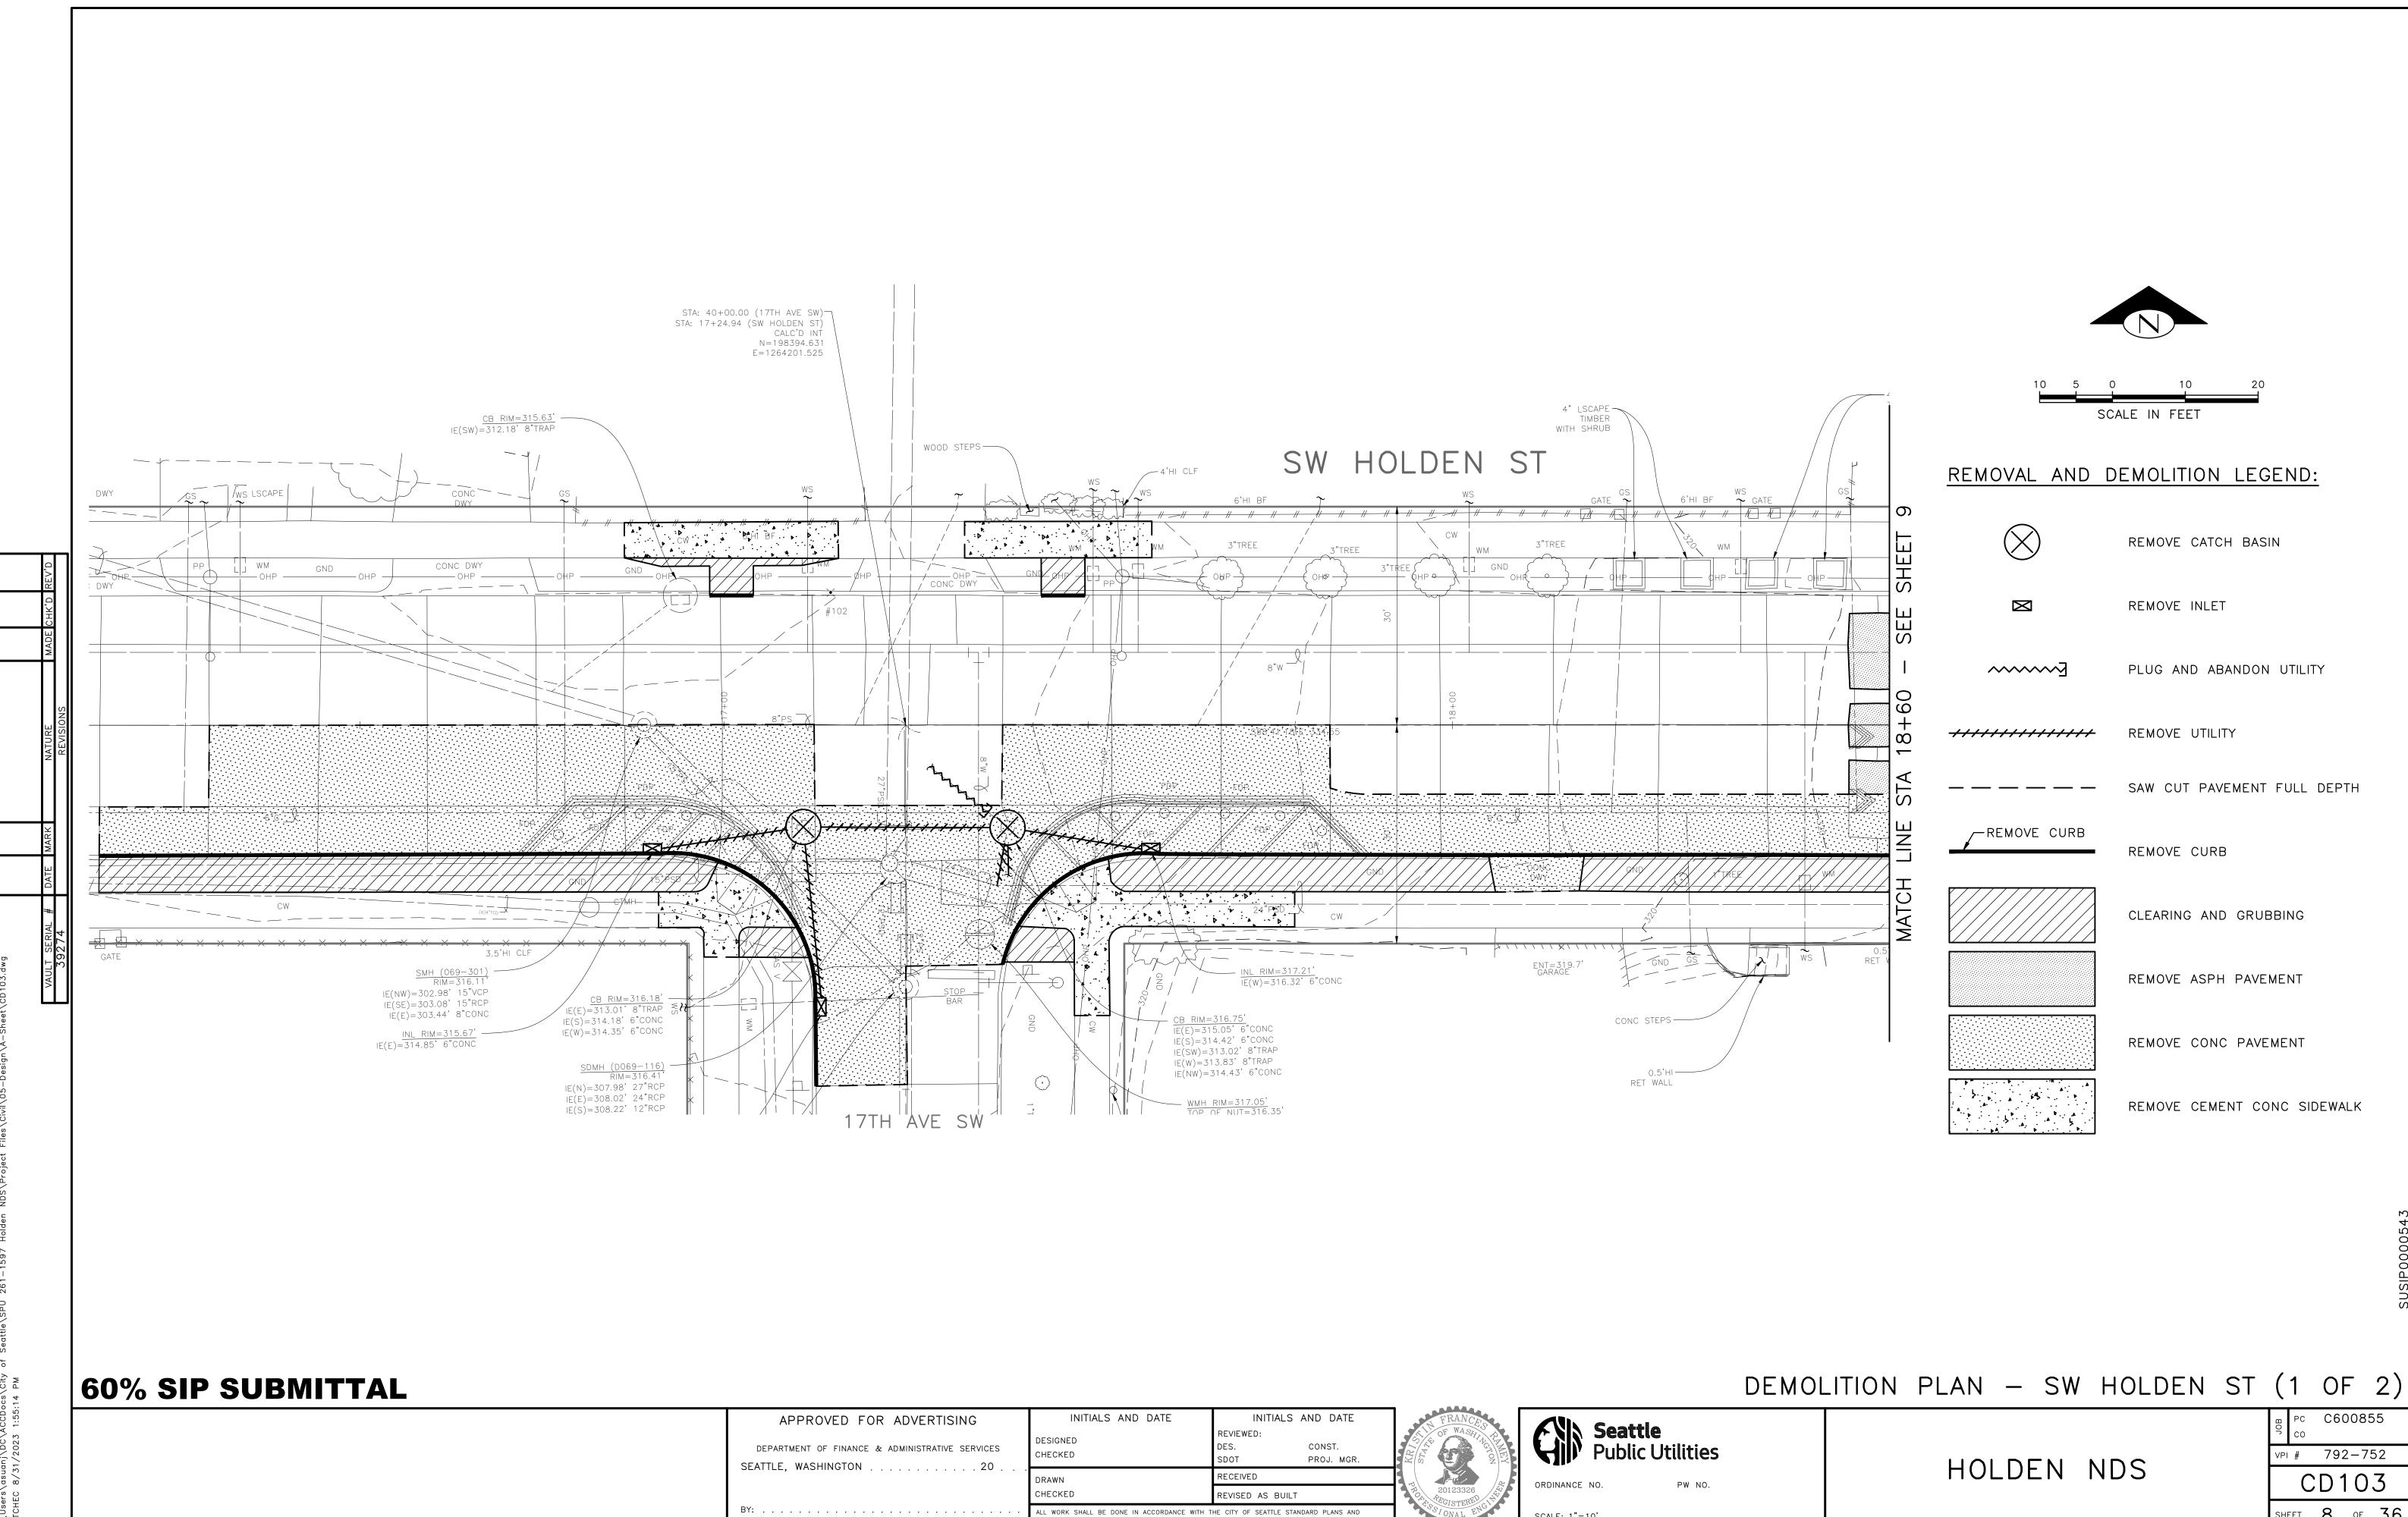



PURCHASING AND CONTRACTING

SCALE: 1"=10'


SHEET 8 OF 36

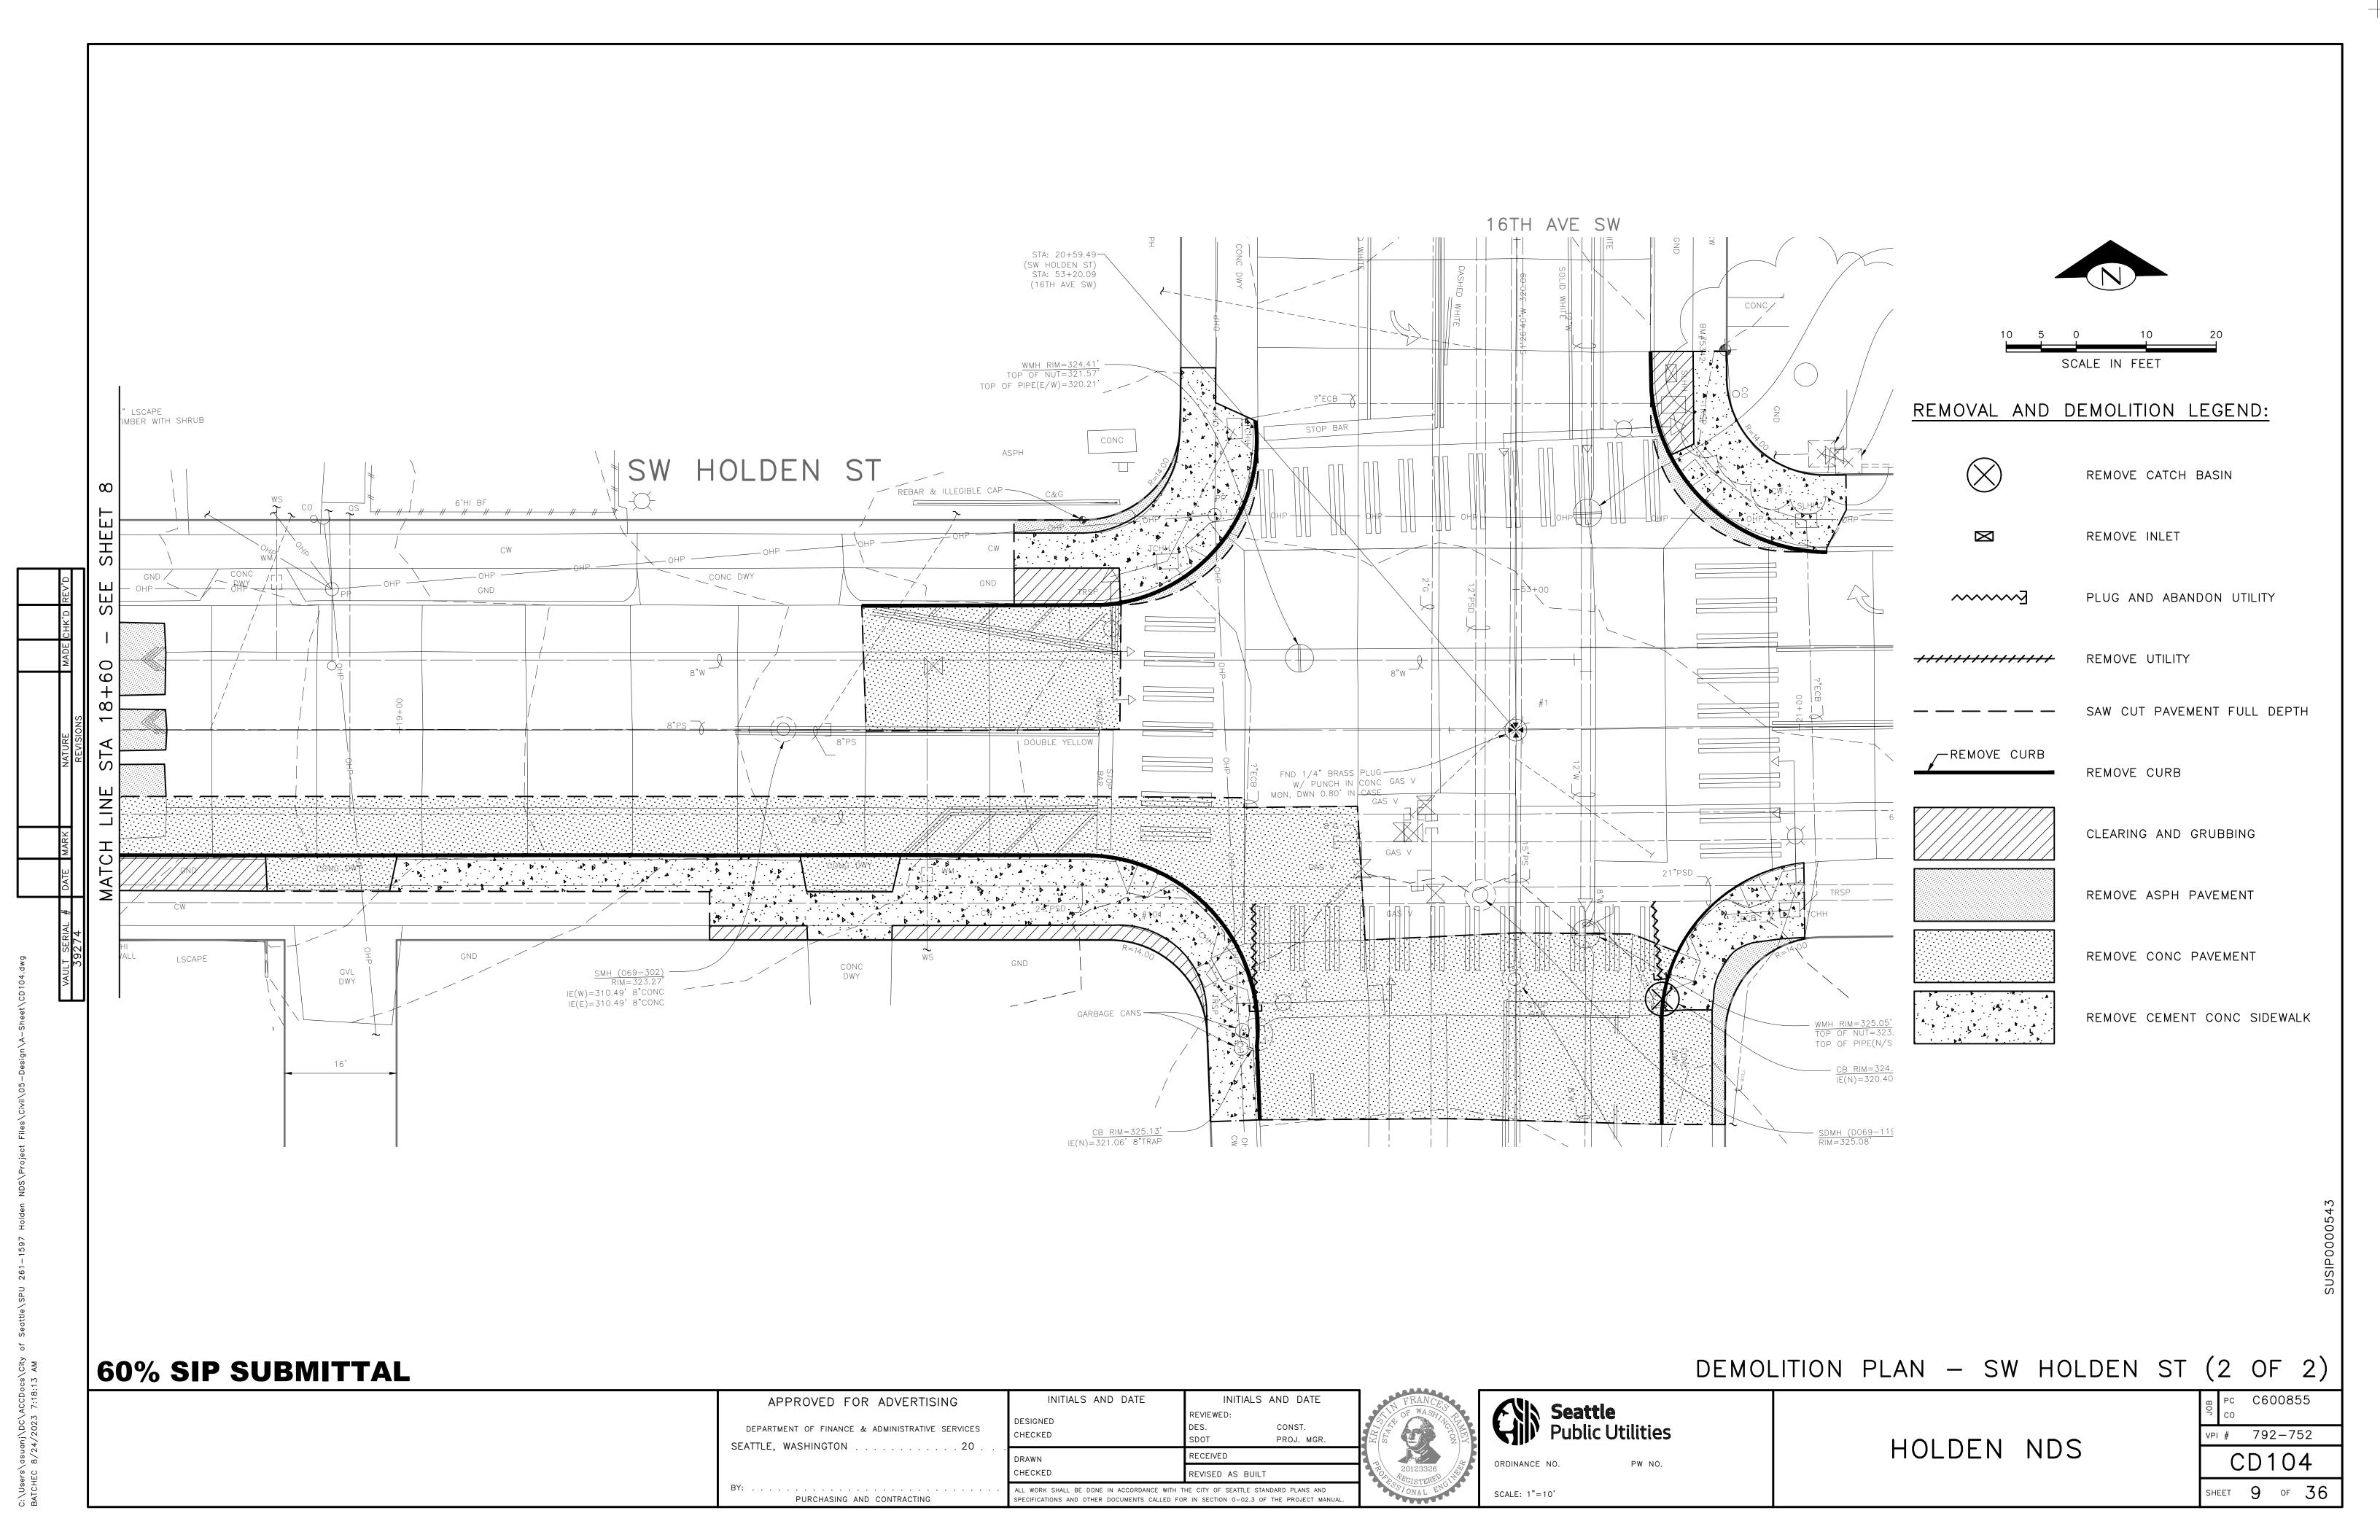

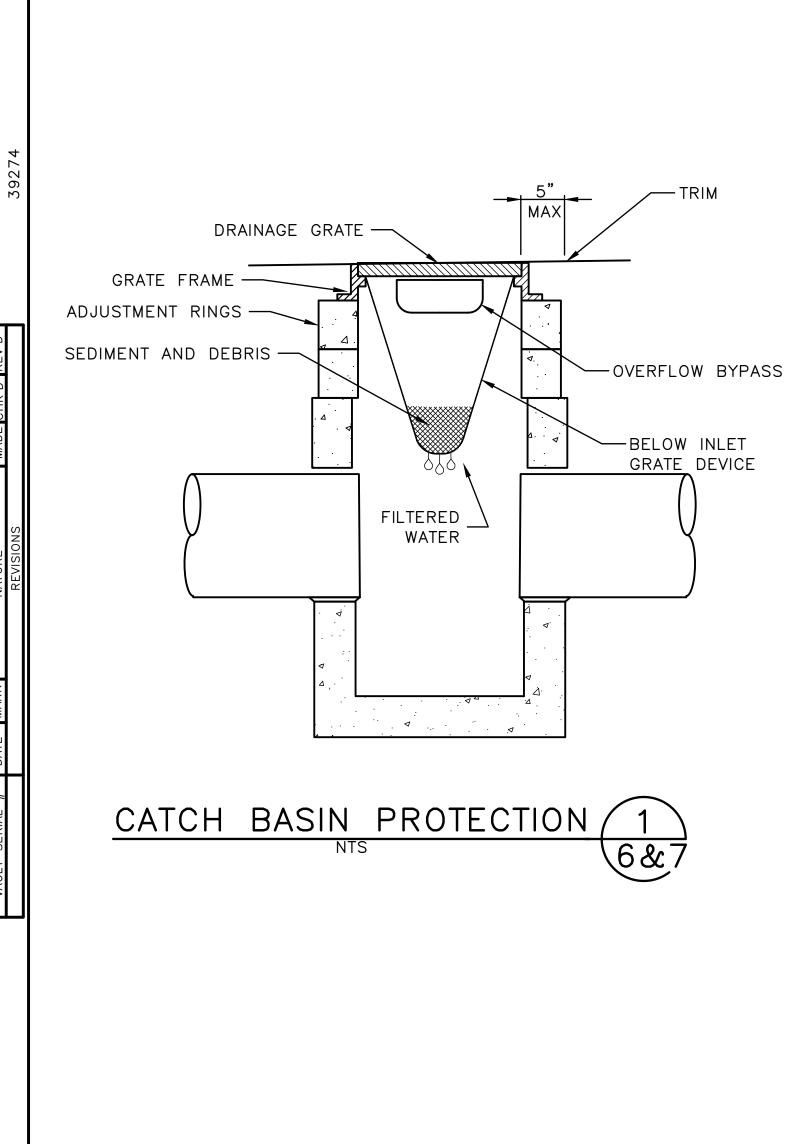

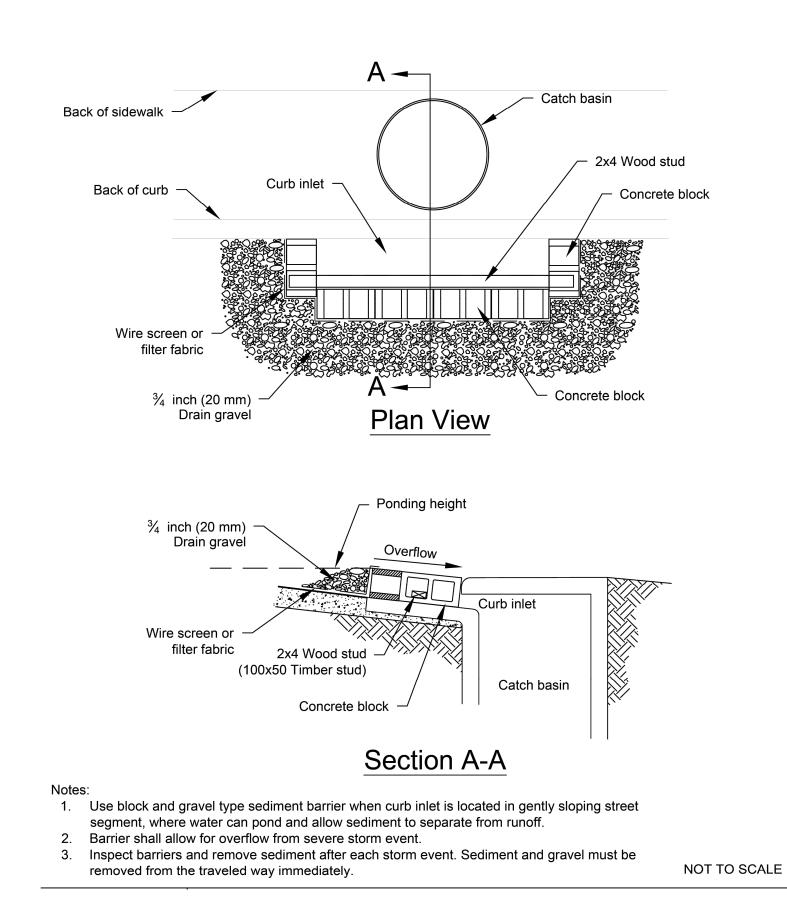

Block and Gravel Curb Inlet Protection

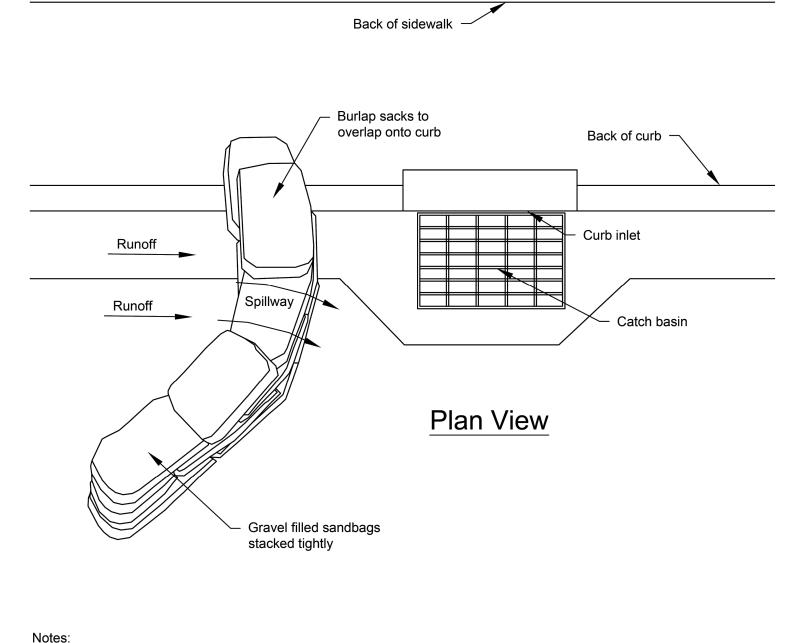

Place curb type sediment barriers on gently sloping street segments, where water can pond and allow sediment to separate from runoff.

2. Sandbags of either burlap or woven 'geotextile' fabric, are filled with gravel, layered

3. Leave a one sandbag gap in the top row to provide a spillway for overflow. 4. Inspect barriers and remove sediment after each storm event. Sediment and gravel must be removed from the traveled way immediately.

NOT TO SCALE

Curb and Gutter Barrier

NOTES:


- 1. MINIMUM 12" OVERLAP OF ALL SEAMS REQUIRED.
- 2. BARRIER REQUIRED @ TOE OF STOCK PILE. 3. COVERING MAINTAINED TIGHTLY IN PLACE BY USING SANDBAGS OR TIRES ON ROPES WITH A MAXIMUM 1' GRID SPACING IN ALL

SHEETING FOR STOCKPILES 3

INLET PROTECTION NTS

60% SIP SUBMITTAL

INITIALS AND DATE INITIALS AND DATE APPROVED FOR ADVERTISING DESIGNED CONST. DEPARTMENT OF FINANCE & ADMINISTRATIVE SERVICES CHECKED PROJ. MGR. SEATTLE, WASHINGTON 20 . DRAWN CHECKED REVISED AS BUILT PURCHASING AND CONTRACTING

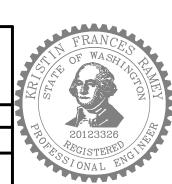



SCALE: AS NOTED

HOLDEN NDS

CESC DETAILS C600855 VPI # 792-752

- MINIMUM 12" OVERLAP

- BARRIER REQUIRED

@ TOE OF SLOPE


OF SEAMS

CD201

SHEET 10 OF 36

NOTE:

1. FOR ADDITIONAL LEGEND INFORMATION, SEE COS STD PLANS (003 SERIES) FOR EXISTING AND PROPOSED STANDARD SYMBOLS AND LEGEND

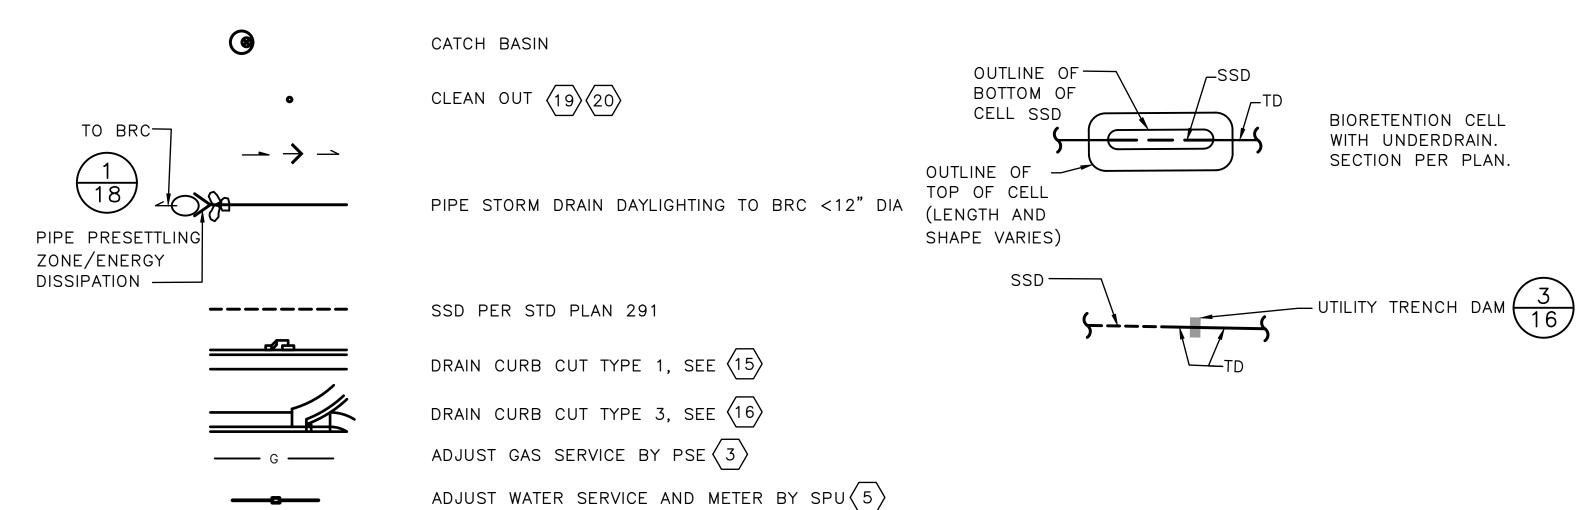

CONSTRUCTION NOTES FOR DRAINAGE AND UTILITY SHEETS


- CONNECT NEW PIPE TO EXISTING CB, MH OR CB CONNECTION PIPE. SEE SECTIONS 7-05.3. PROTECT IN PLACE EX CB OR MH. THE CONDITION OF THE EXISTING CB MUST BE VERIFIED FOR APPROVAL PRIOR TO INSTALLATION.
- $\fbox{2}$ CUT-IN TEE. CONNECT TO EX PIPE OR STRUCTURE. TEES MUST BE OFFSET FROM ONE ANOTHER 3-FT MINIMUM. SEE PROFILE FOR INVERT ELEV, SEE SECTION 7-17.3.
- CONTRACTOR MUST COORDINATE REROUTE AND RECONNECTION OF GAS SERVICE WITH PUGET SOUND ENERGY (PSE).
- PROTECT EXISTING UTILITY. PRIOR TO START OF STORM DRAIN INSTALL ATION CONTRACTOR TO SETUP. INSTALLATION, CONTRACTOR TO POTHOLE UTILITY TO VERIFY NO CONFLICT BETWEEN UTILITY AND STORM DRAIN.
- ASSIST SPU WATER OPERATIONS WATER SERVICE. SERVICE AND METER TO BE RELOCATED BY SPU WITH CONTRACTOR SUPPORT. CONTRACTOR SUPPORT TO INCLUDE ALL NECESSARY EXCAVATIONS, PROTECTIVE MEASURES, BACKFILL, SURVEY CONTROL AND TRAFFIC CONTROL.
- $\langle 6 \rangle$ INSTALL PIPE, INLET CONN, DI, CL 50, 8".
- $\overline{\langle 7 \rangle}$ INSTALL PIPE, CB CONN, DI, CL 50, 8".
- (8) INSTALL PIPE, PSD, DI, CL 50, 8".

- 9 INSTALL PIPE, SSD, 6".
- $\langle 10 \rangle$ INSTALL PIPE, TIGHTLINED SSD, 6".
- $\langle 11 \rangle$ TYPE A BIORETENTION WEIR
- (12) TYPE B BIORETENTION WEIR
- (13) PIPE END CAP
- $\langle 14 \rangle$ INSTALL PIPE, CULVERT, DI, CL 50, 8".
- DRAIN CURB CUT TYPE 1 WITH DIMENSIONS PER STD PLAN 295B.
- DRAIN CURB CUT TYPE 3 WITH DIMENSIONS PER STD. PLAN 295B.
- (17) JB TO UTILIZE BEEHIVE GRATE PER STANDARD PLAN 269.
- (18) ADJUST EXISTING MH, CB, OR VC
- $\langle 19
 angle$ bioretention underdrain clean-out per STD plan 281.
- $\langle 20 \rangle$ CLEAN OUT PER STD PLAN 280.

UTILITY SERVICE PROFILE REFERENCE

NOTE:

1. EXISTING AND ADJUSTED WATER AND GAS SERVICE SYMBOLS SHOWN ON PROFILE ARE SHOWN LARGER THAN ACTUAL SIZE FOR VISIBILITY. SEE SURVEY FOR ACTUAL SIZE.

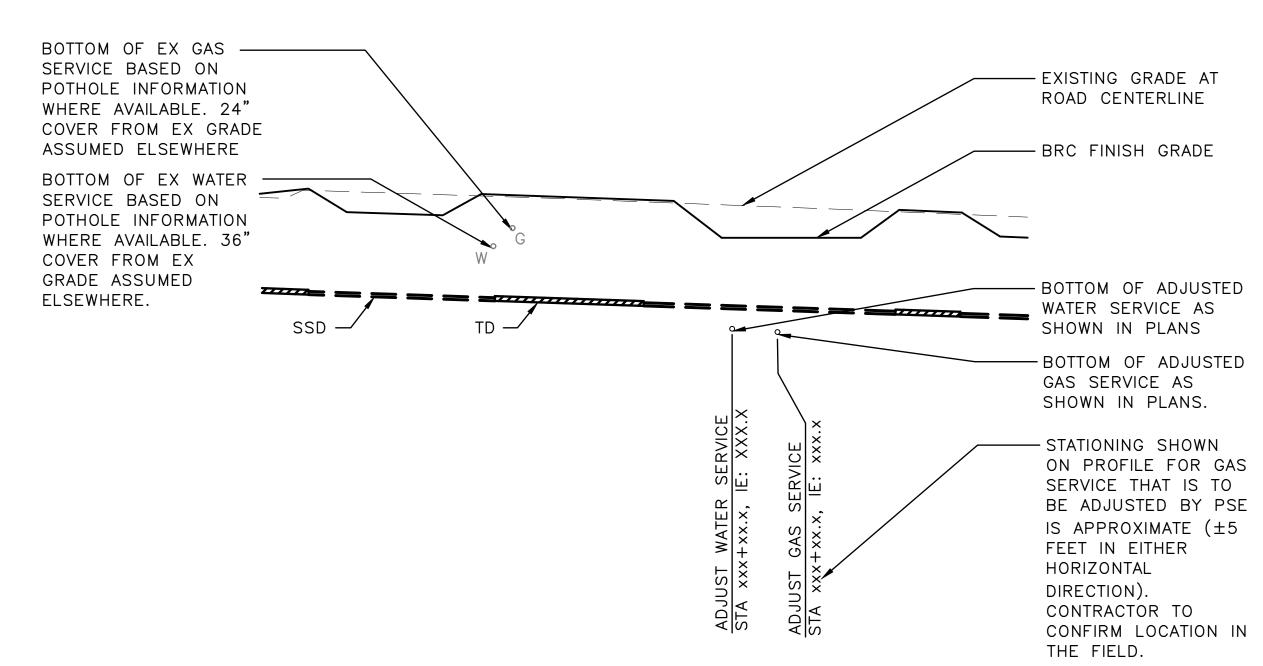

ABBREVIATIONS LEGEND

NOTE:

1. FOR ADDITIONAL ABBREVIATIONS, SEE COS STD PLANS (002 SERIES)

HIGH PERFORMANCE BIORETENTION SOIL

CRITICAL ROOT ZONE OF TREE AS DETERMINED BY ARBORIST WHICH MAY DIFFER FROM ZONE B DEFINED IN STD PLAN 133.

MODIFIED

SUBSURFACE DRAIN/UNDERDRAIN PIPE

TIGHTLINED SSD/UNDERDRAIN PIPE

TOP OF CURB

TOP OF GRADE

UNLESS NOTED OTHERWISE

60% SIP SUBMITTAL

GRADING AND STORM DRAIN LEGEND AND NOTES

INITIALS AND DATE APPROVED FOR ADVERTISING INITIALS AND DATE DESIGNED CONST. DEPARTMENT OF FINANCE & ADMINISTRATIVE SERVICES CHECKED PROJ. MGR. SEATTLE, WASHINGTON 20 DRAWN CHECKED EVISED AS BUILT PURCHASING AND CONTRACTING







HOLDEN NDS

C600855 PI # 792-752 CU001

SHEET 11 OF 36

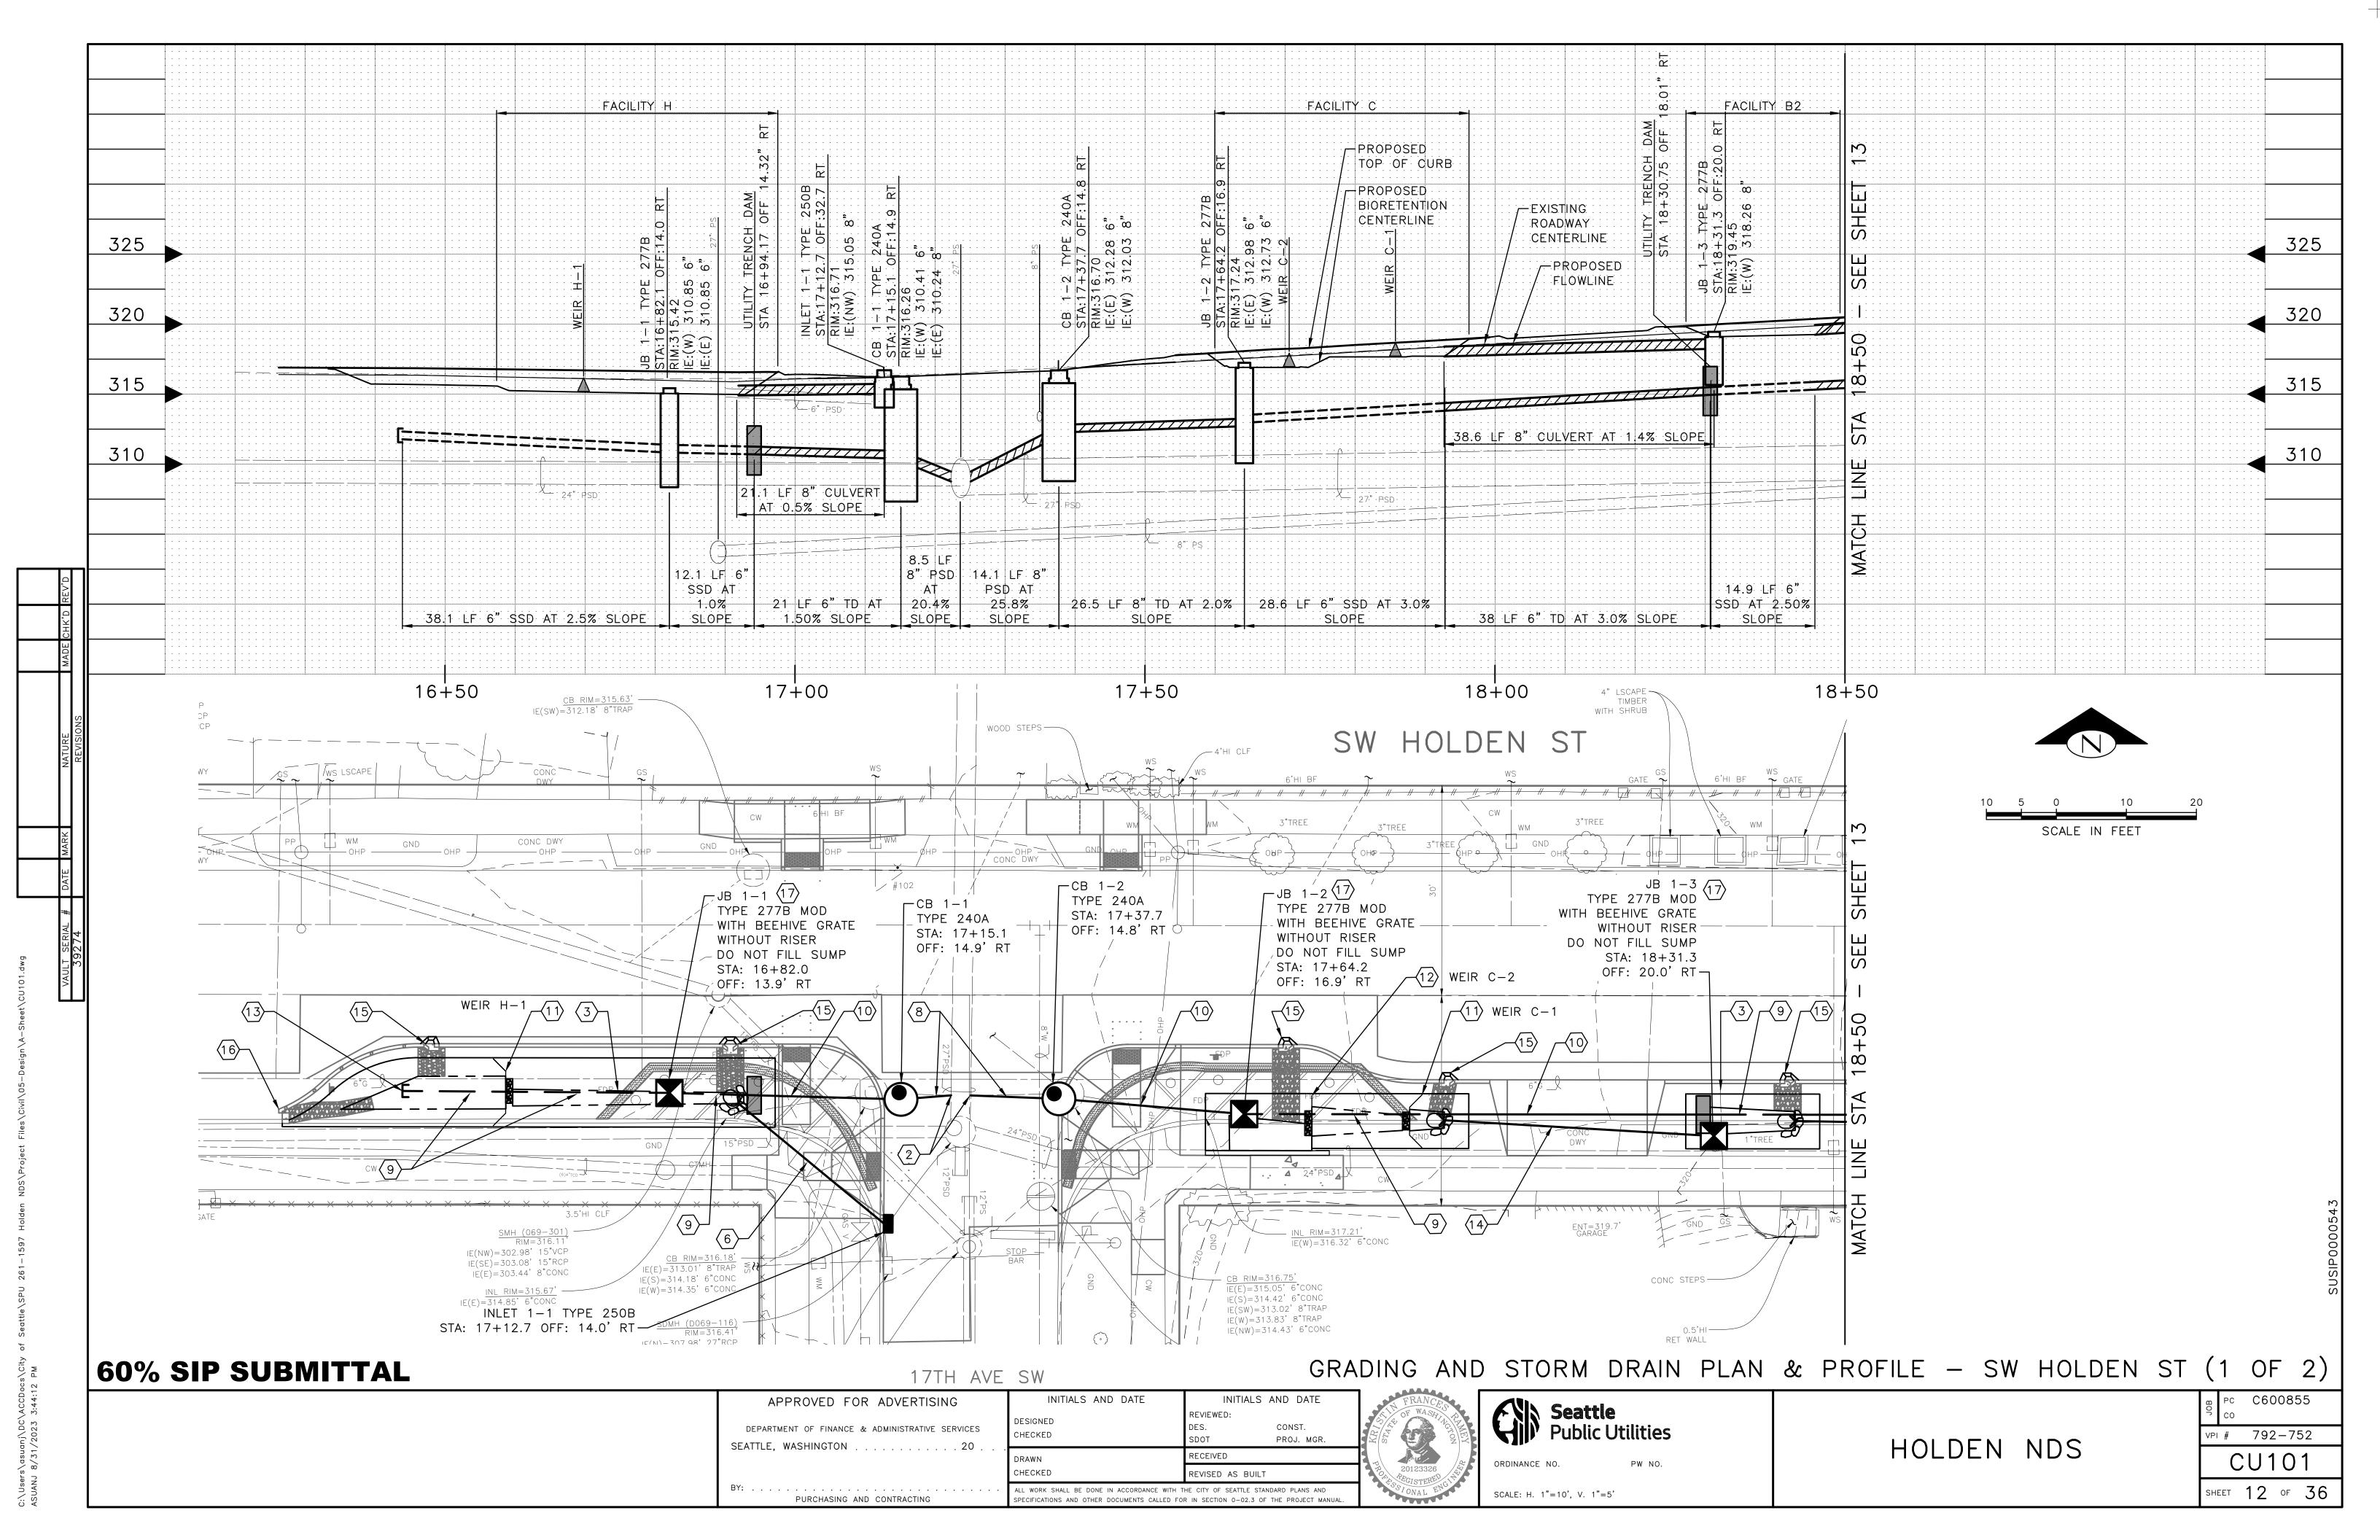

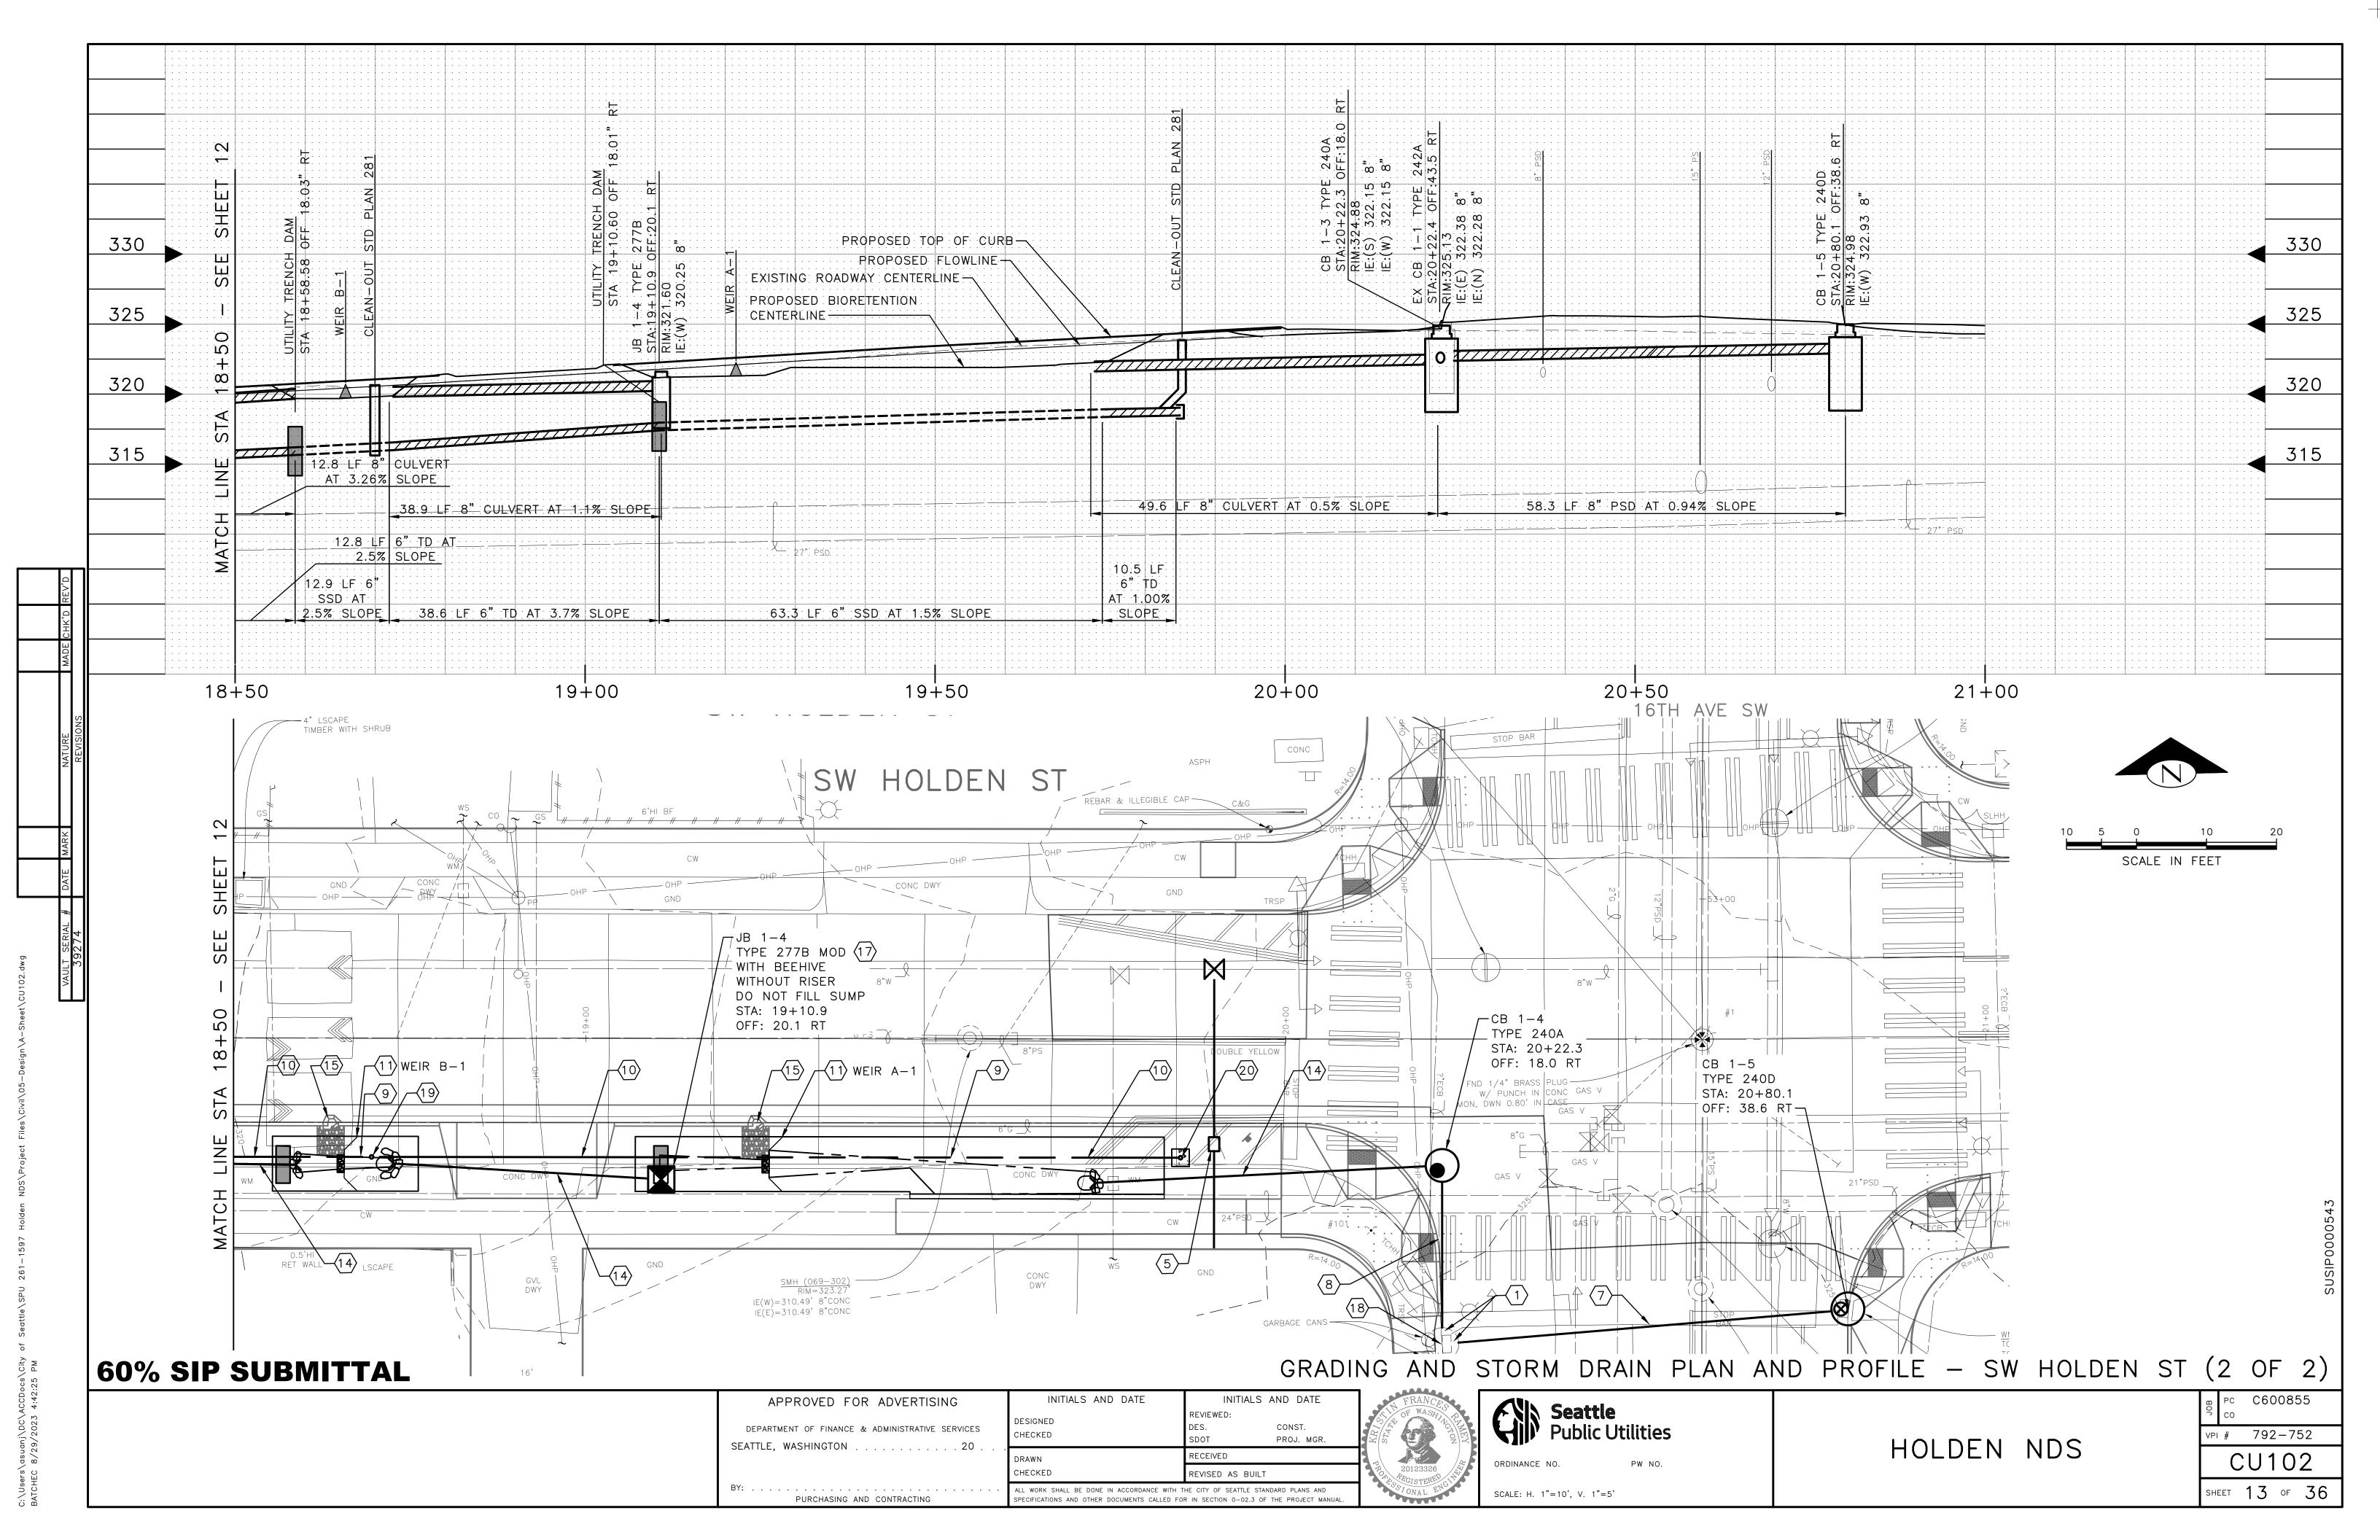

APPROX. EXISTING FACE OF CURB BOTTOM AREA, SLOPE, AND ELEVATION PER PLAN-----

60% SIP SUBMITTAL

BIORETENTION AT CURB AND GUTTER

LEGEND:

HIGH PERFORMANCE BIORETENTION SOIL MINERAL AGGREGATE TYPE 26

CURB AND ROADWAY

RESTORATION PER PLAN

-SAWCUT EXISTING

INITIALS AND DATE

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11,12,21,&22

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TEXISTING CONCRETE

MULCH, ARBORIST WOOD CHIP MULCH MULCH, COURSE

COMPOST

BIORETENTION FACILITY KEY NOTES:

- NEW SIDEWALK, WHERE APPLICABLE, PER PLAN
- BOTTOM WIDTH OF FACILITY VARIES.
- MULCH TYPE VARIES. SEE PLANTING PLANS.
- SEE LANDSCAPE DETAILS AND PLANS FOR PLANTINGS IN BIORETENTION FACILITIES. PLACEMENT OF STREET TREES VARIES. SEE PLANTING PLAN FOR LOCATION.
- PSE TO ADJUST AND RECONNECT EXISTING GAS SERVICES WHERE SERVICES ARE NOTED TO BE ADJUSTED ON THE PLANS. GAS SERVICES WITHIN FACILITY SECTION ARE TO BE RELOCATED BELOW UNDERDRAIN TRENCH. GAS SERVICES OUTSIDE OF FACILITY DEPRESSION (E.G. AT CROSSINGS BETWEEN FACILITIES) ARE TO HAVE MINIMUM 24-INCHES OF COVER FROM FINISH SURFACE GRADE. PSE TO ADJUST GAS SERVICES PRIOR TO CONSTRUCTION OF BIORETENTION FACILITIES AND UNDERDRAIN. LOCATE GAS SERVICES AND MAINS PRIOR TO CONSTRUCTION.
- SCARIFY SUBGRADE AS SPECIFIED IN SPEC SECTION 7-21.3(2)B IN THE AREA SUBJECT TO TEMPORARY PONDING BEFORE BIORETENTION SOIL INSTALLATION.
- EXISTING WATER SERVICE AND METERS TO BE RELOCATED BY SPU WITH CONTRACTOR SUPPORT WHERE SHOWN ON CIVIL GRADING AND STORM DRAIN PLANS.
- SOIL UNDER SHOULDERS OR PAVED AREAS MUST BE UNDISTURBED NATIVE SOIL OR APPROVED SOIL COMPACTED TO 95% DENSITY.
- PROVIDE ONE INCH GAP BETWEEN TOP OF WALKS, CURBS, PAVEMENTS AND DRIVEWAYS AND TOP OF ARBORIST WOODCHIP MULCH, WHERE OCCURS.
- TYPICAL MAXIMUM SLOPE ALLOWED IS 2.5H=1V, 3H=1V MAX WHEN WITHIN 50-FEET OF INTERSECTIONS.

UNDERDRAIN TRENCH / <u>14,</u>15,&17

STORM DETAILS (1 OF 4)

SCALE: AS NOTED


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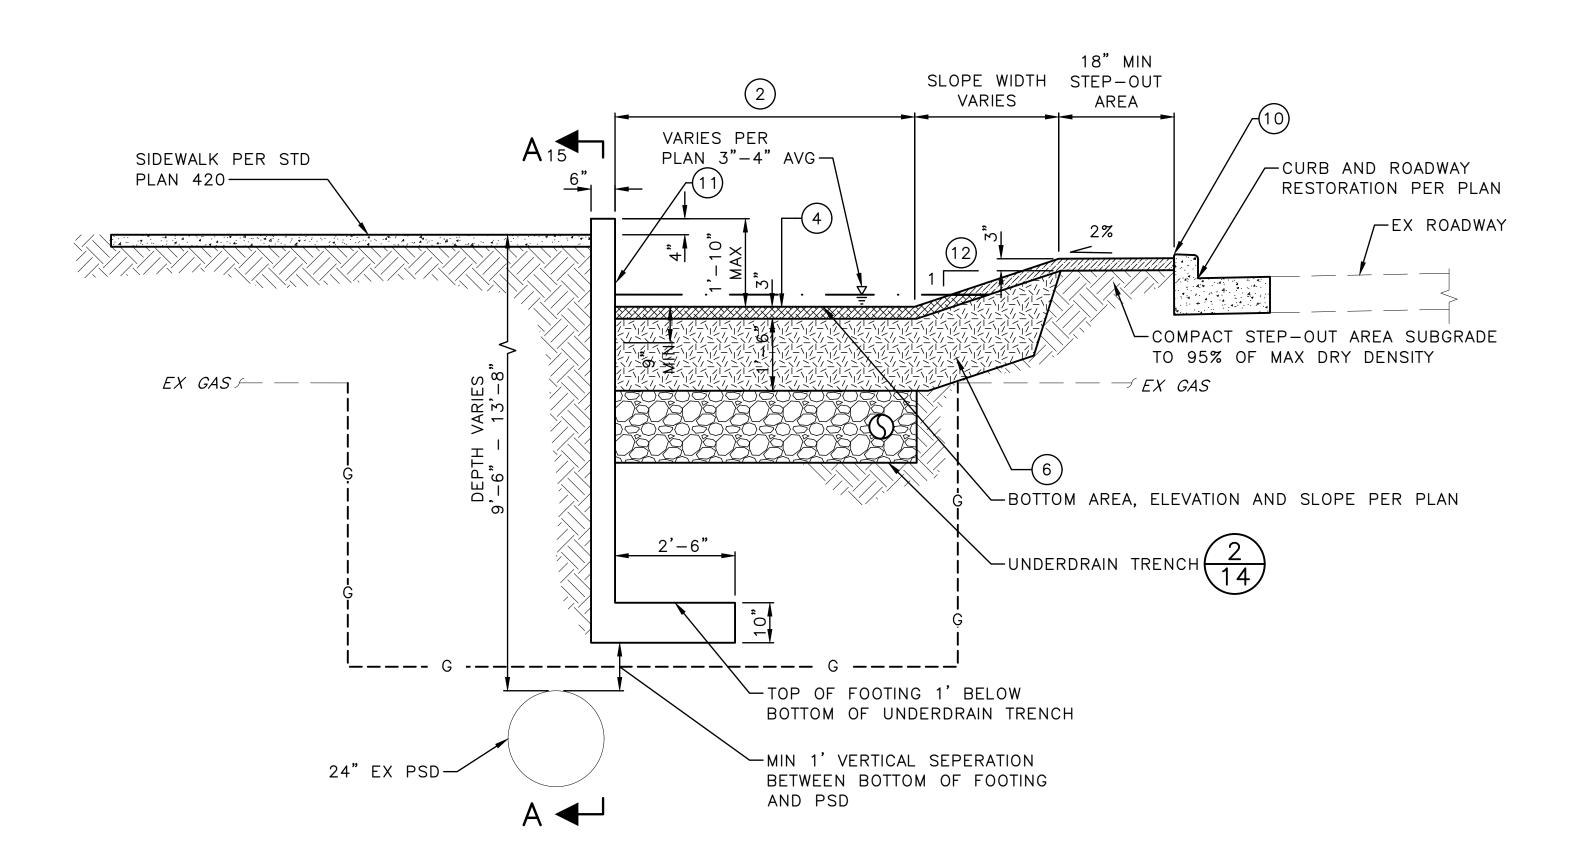
CU201 SHEET 14 OF 36

6" SSD PER COS STD PLAN NO 291 ALIGN SLOTS AT BOTTOM OF PIPE— MATCH CELL BOTTOM WIDTH VARIES

Seattle Public Utilities



SECTION A-A

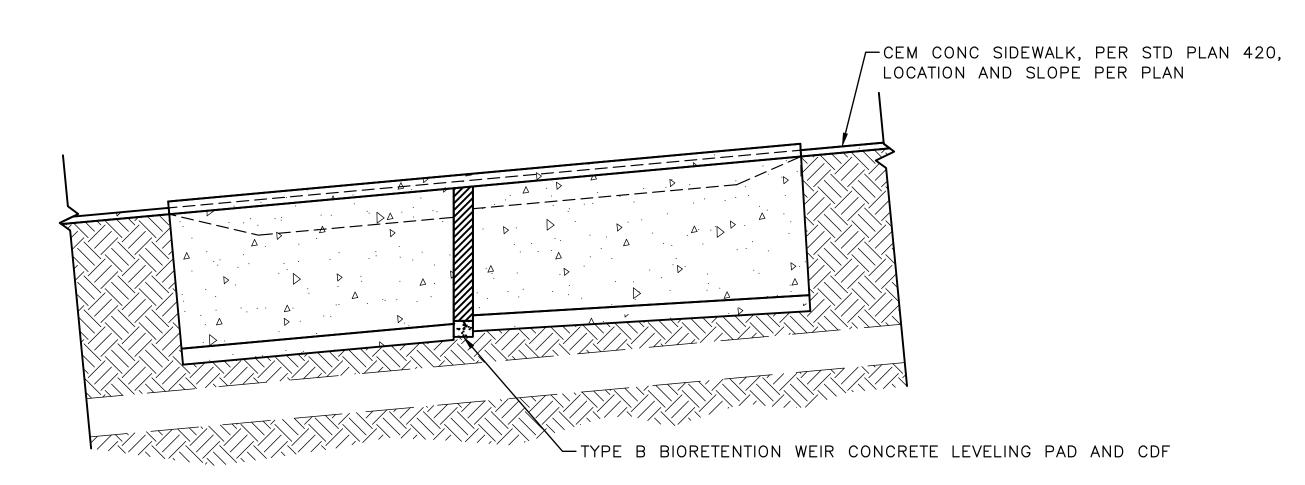

BIORETENTION WITH VERTICAL WALLED SIDE (

60% SIP SUBMITTAL

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	CHECKED	REVISED AS BUILT
BY:	ALL WORK SHALL BE DONE IN ACCORDANCE WITH T SPECIFICATIONS AND OTHER DOCUMENTS CALLED FO	



Seattle Public Utilities

ORDINANCE NO.

HOLDEN NDS

VPI # 792-752 CU202

BIORETENTION WITH VERTICAL WALLED SIDE KEY NOTES:

- (1) NEW SIDEWALK, WHERE APPLICABLE, PER PLAN.
- 2) BOTTOM WIDTH OF FACILITY VARIES.
- (3) MULCH TYPE VARIES. SEE PLANTING PLANS.
- SEE LANDSCAPE DETAILS AND PLANS FOR PLANTINGS IN BIORETENTION FACILITIES. PLACEMENT OF STREET TREES VARIES. SEE PLANTING PLAN FOR LOCATION.
- PSE TO ADJUST AND RECONNECT EXISTING GAS SERVICES WHERE SERVICES ARE NOTED TO BE ADJUSTED ON THE PLANS. GAS SERVICES WITHIN FACILITY SECTION ARE TO BE RELOCATED BELOW UNDERDRAIN TRENCH. GAS SERVICES OUTSIDE OF FACILITY DEPRESSION (E.G. AT CROSSINGS BETWEEN FACILITIES) ARE TO HAVE MINIMUM 24-INCHES OF COVER FROM FINISH SURFACE GRADE. PSE TO ADJUST GAS SERVICES PRIOR TO CONSTRUCTION OF BIORETENTION FACILITIES AND UNDERDRAIN. LOCATE GAS SERVICES AND MAINS PRIOR TO CONSTRUCTION.
- SCARIFY SUBGRADE AS SPECIFIED IN SPEC SECTION 7-21.3(2)B IN THE AREA SUBJECT TO TEMPORARY PONDING BEFORE BIORETENTION SOIL INSTALLATION.
- EXISTING WATER SERVICES AND METERS TO BE RELOCATED BY SPU WITH CONTRACTOR SUPPORT WHERE SHOWN ON CIVIL GRADING AND STORM DRAIN PLANS.
- SOIL UNDER SHOULDERS OR PAVED AREAS MUST BE UNDISTURBED NATIVE SOIL OR APPROVED SOIL COMPACTED TO 95% DENSITY.
- 10 PROVIDE MIN ONE INCH GAP BETWEEN TOP OF WALKS, CURBS, PAVEMENTS AND DRIVEWAYS AND TOP OF ARBORIST WOODCHIP MULCH, WHERE OCCURS.
- WALL DETAILS TO BE PROVIDED AT 90% DESIGN SUBMITTAL.
- TYPICAL MAXIMUM SLOPE ALLOWED IS 2.5H=1V, 3H=1V MAX WHEN WITHIN 50-FEET OF INTERSECTIONS.

LEGEND:

BIORETENTION SOIL MIX

PEA GRAVEL OR SELF-COMPACTING MATERIAL


MINERAL AGGREGATE TYPE 2


MINERAL AGGREGATE TYPE 22

COMPOST

STORM DETAILS (2 OF 4)

SHEET 15 OF 36

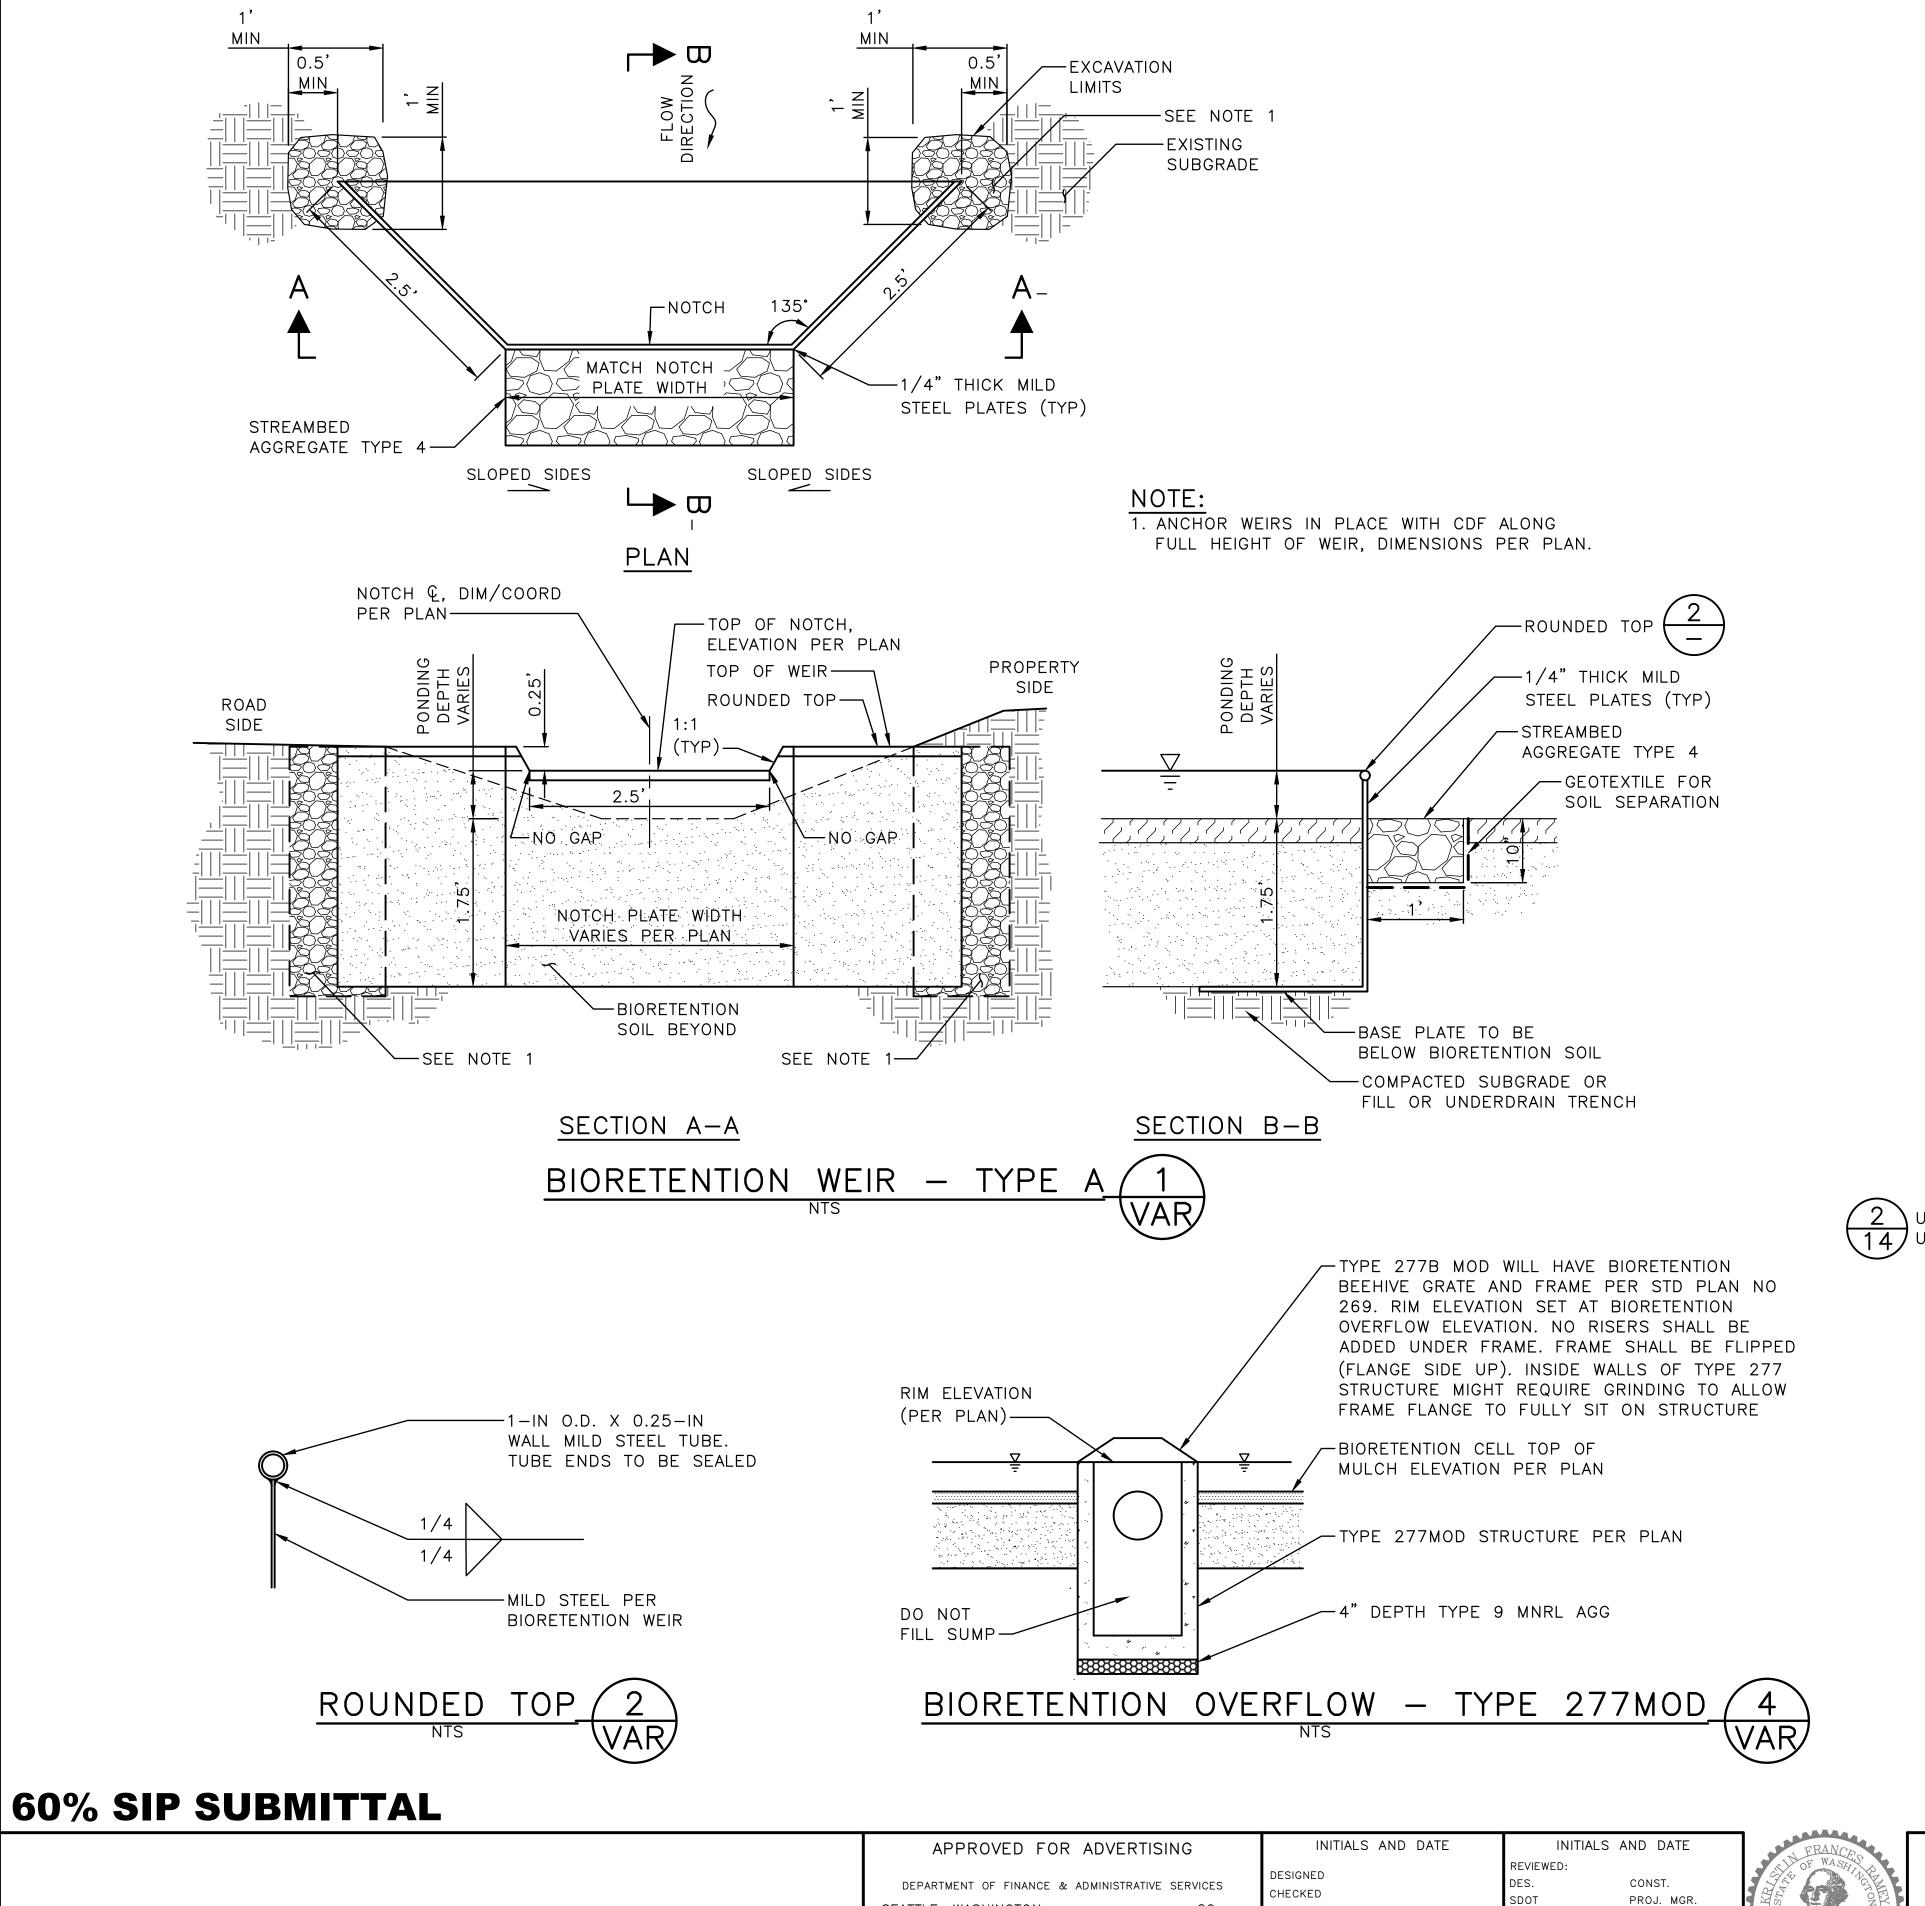

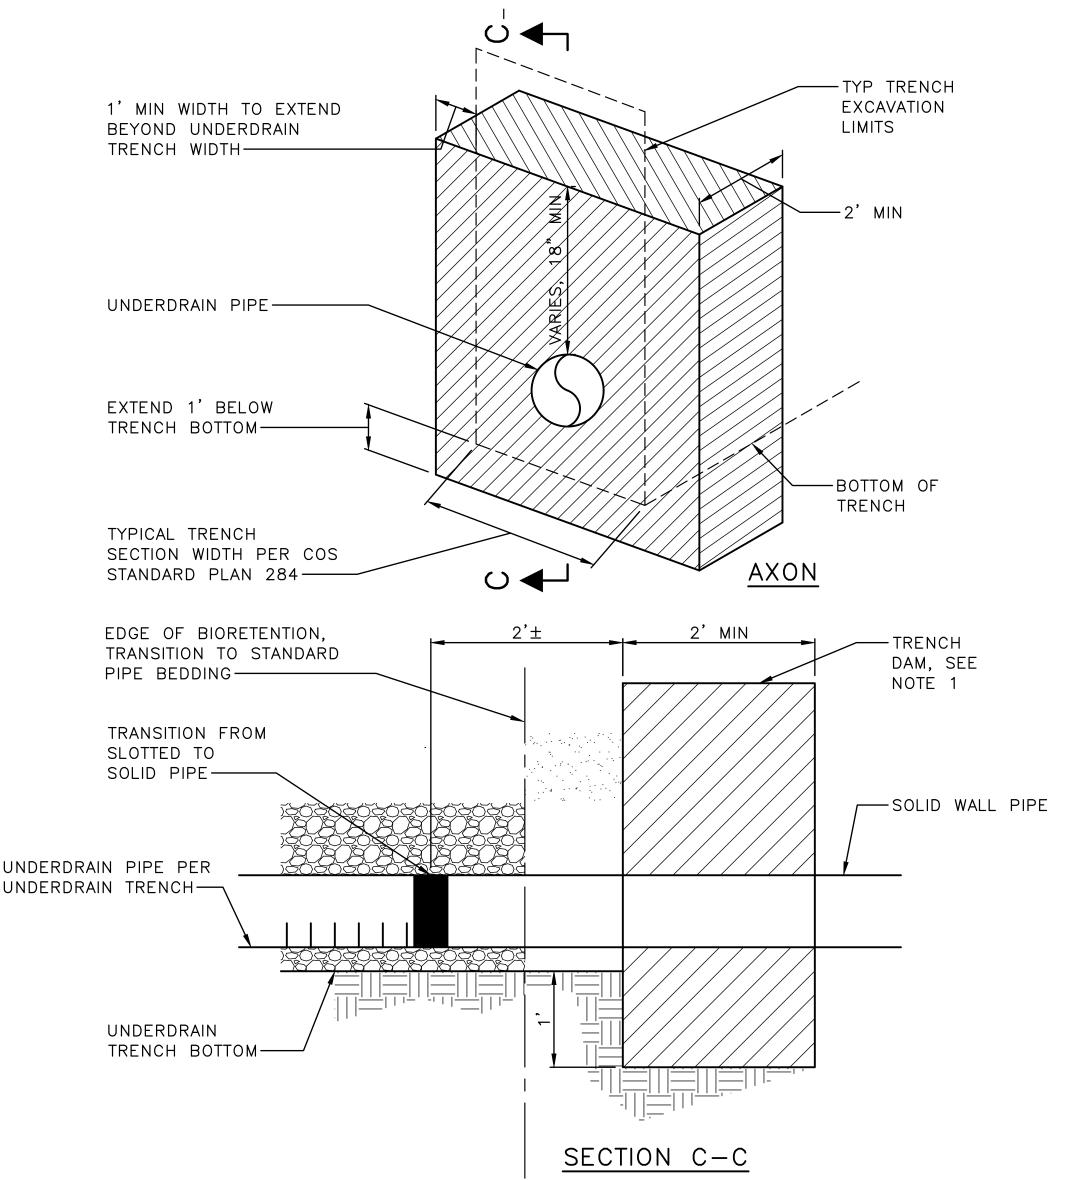

NOTE:

1. TRENCH DAM BACKFILL SHALL BE A MATERIAL WITH HYDRAULIC CONDUCTIVITY LESS THAN $4X10^-6$ INCHES/SECOND ACCORDING TO ASTM D-5084 AND NON-PERMISSIVE MATERIAL. MATERIAL SUCH AS CONTROLLED DENSITY FILL, NATIVE SOIL EXCAVATED ON SITE THAT HAS A MINIMUM OF 20 PERCENT PASSING #200 SIEVE SCREEN, OR OTHER MATERIAL APPROVED BY ENGINEER.

TYPICAL UTILITY TRENCH DAM_

BIORETENTION DETAILS/SECTIONS

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C600855 792-752 CU203


SHEET 16 OF 36


SEATTLE, WASHINGTON 20

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SCALE: AS NOTED



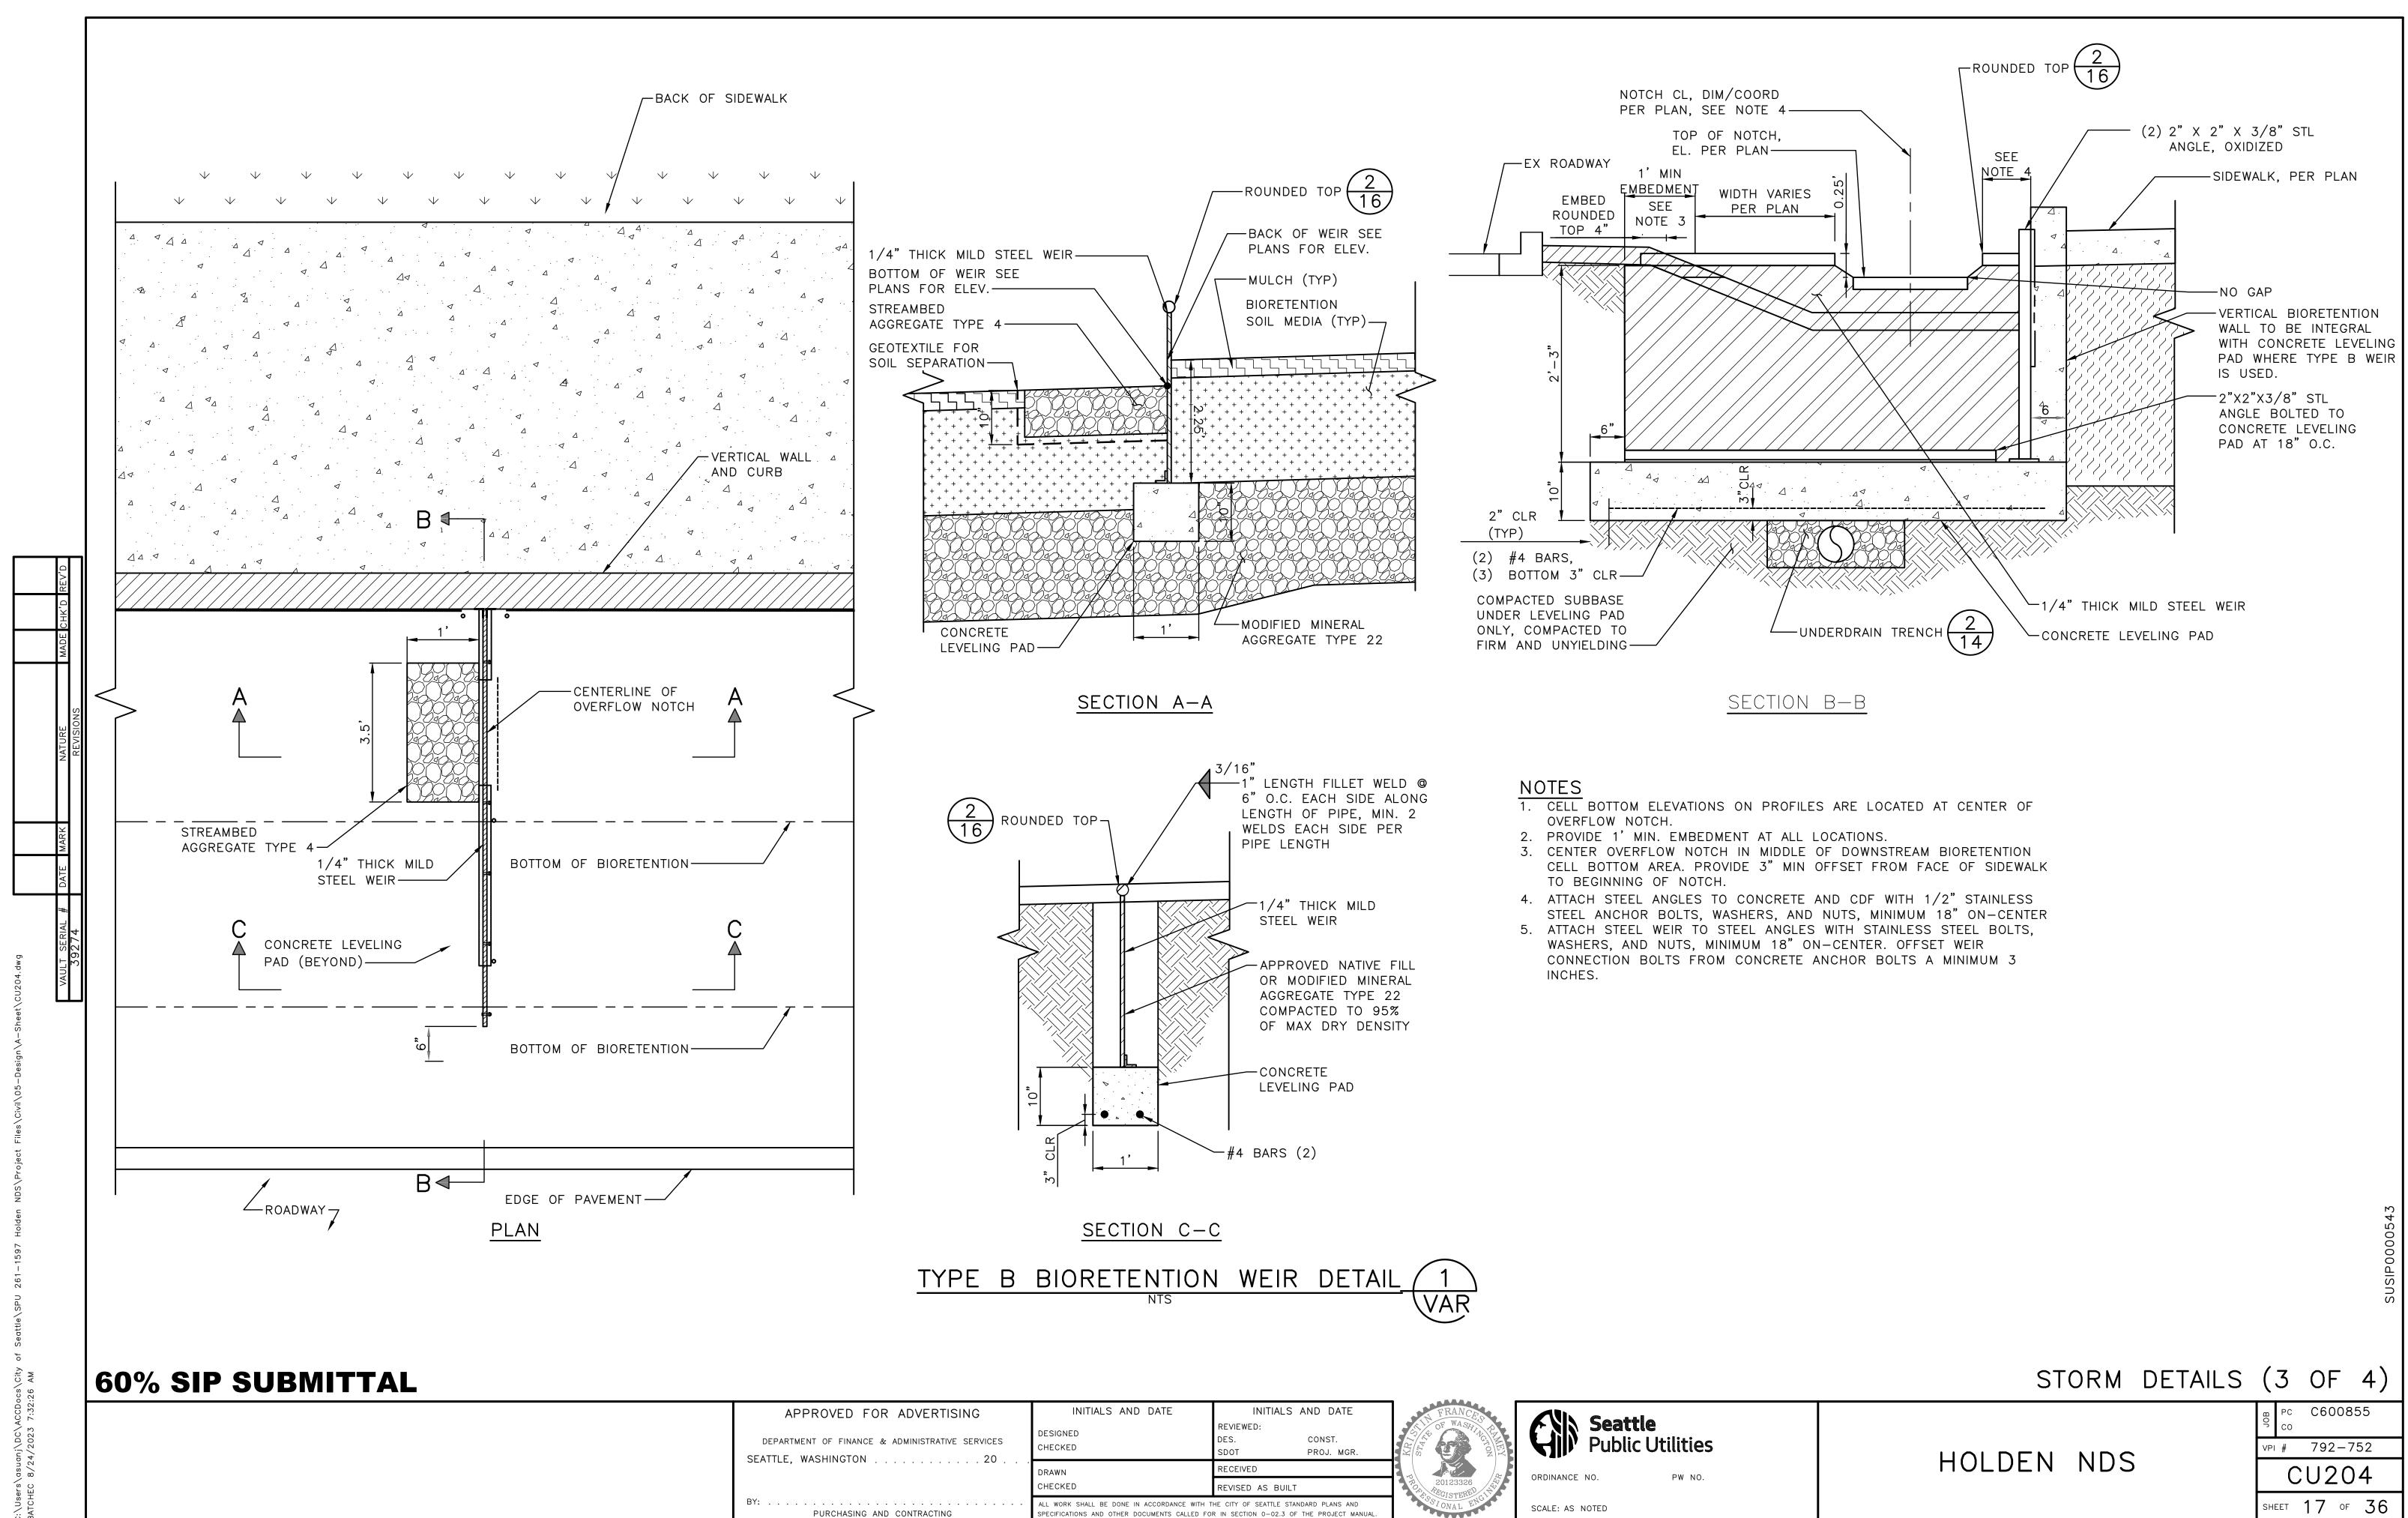

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60% SIP SUBMITTAL

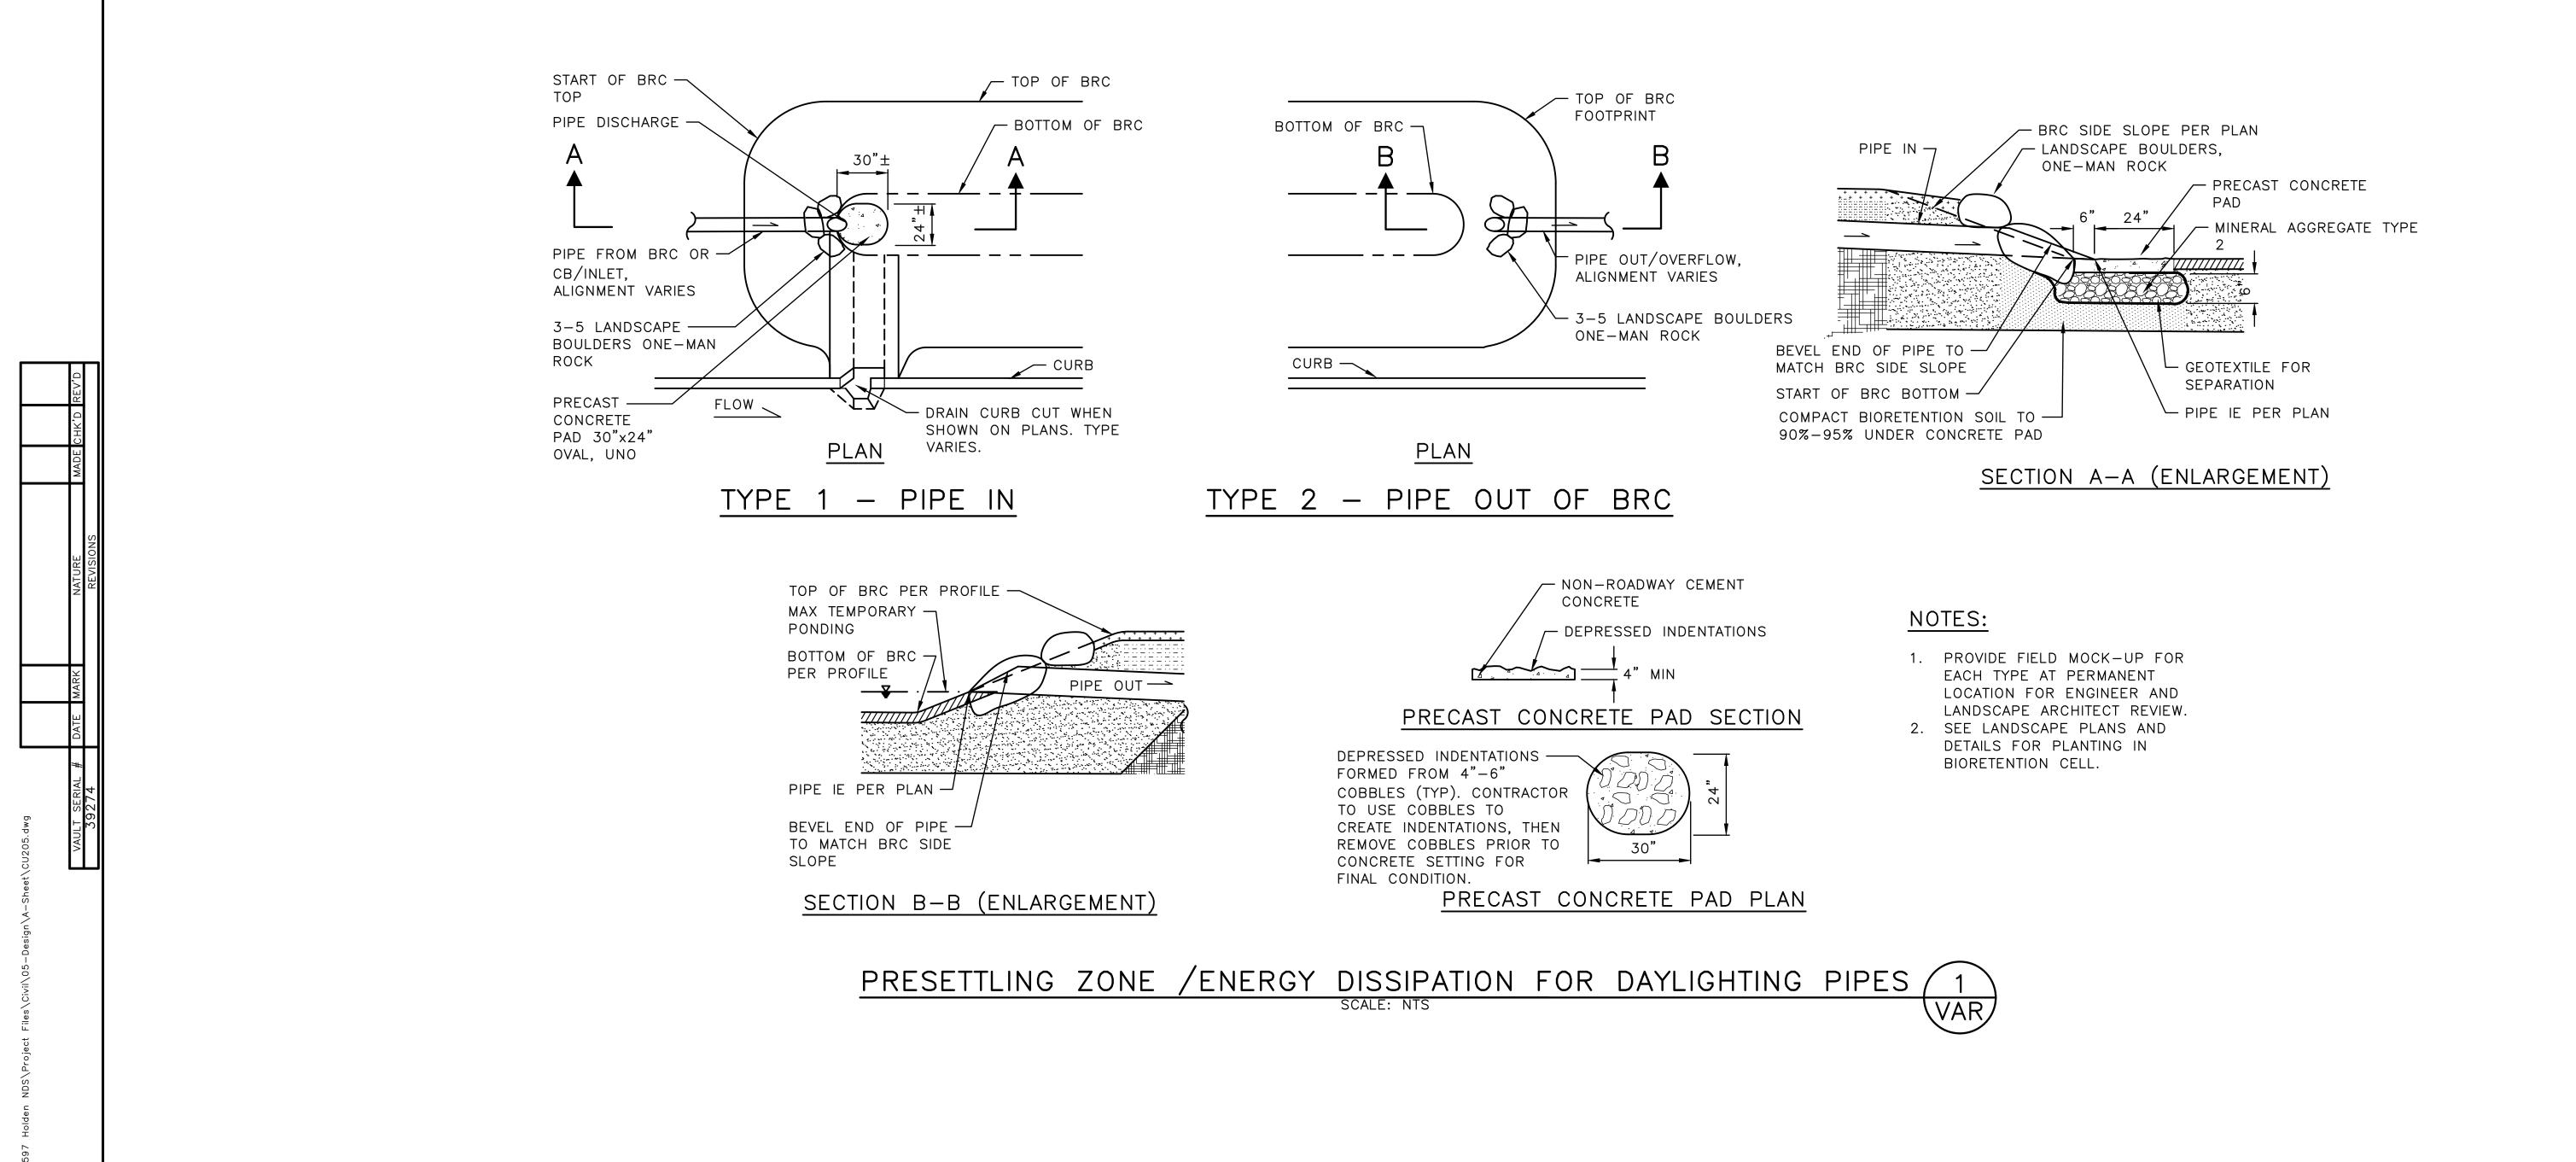Seattle
Public Utilities

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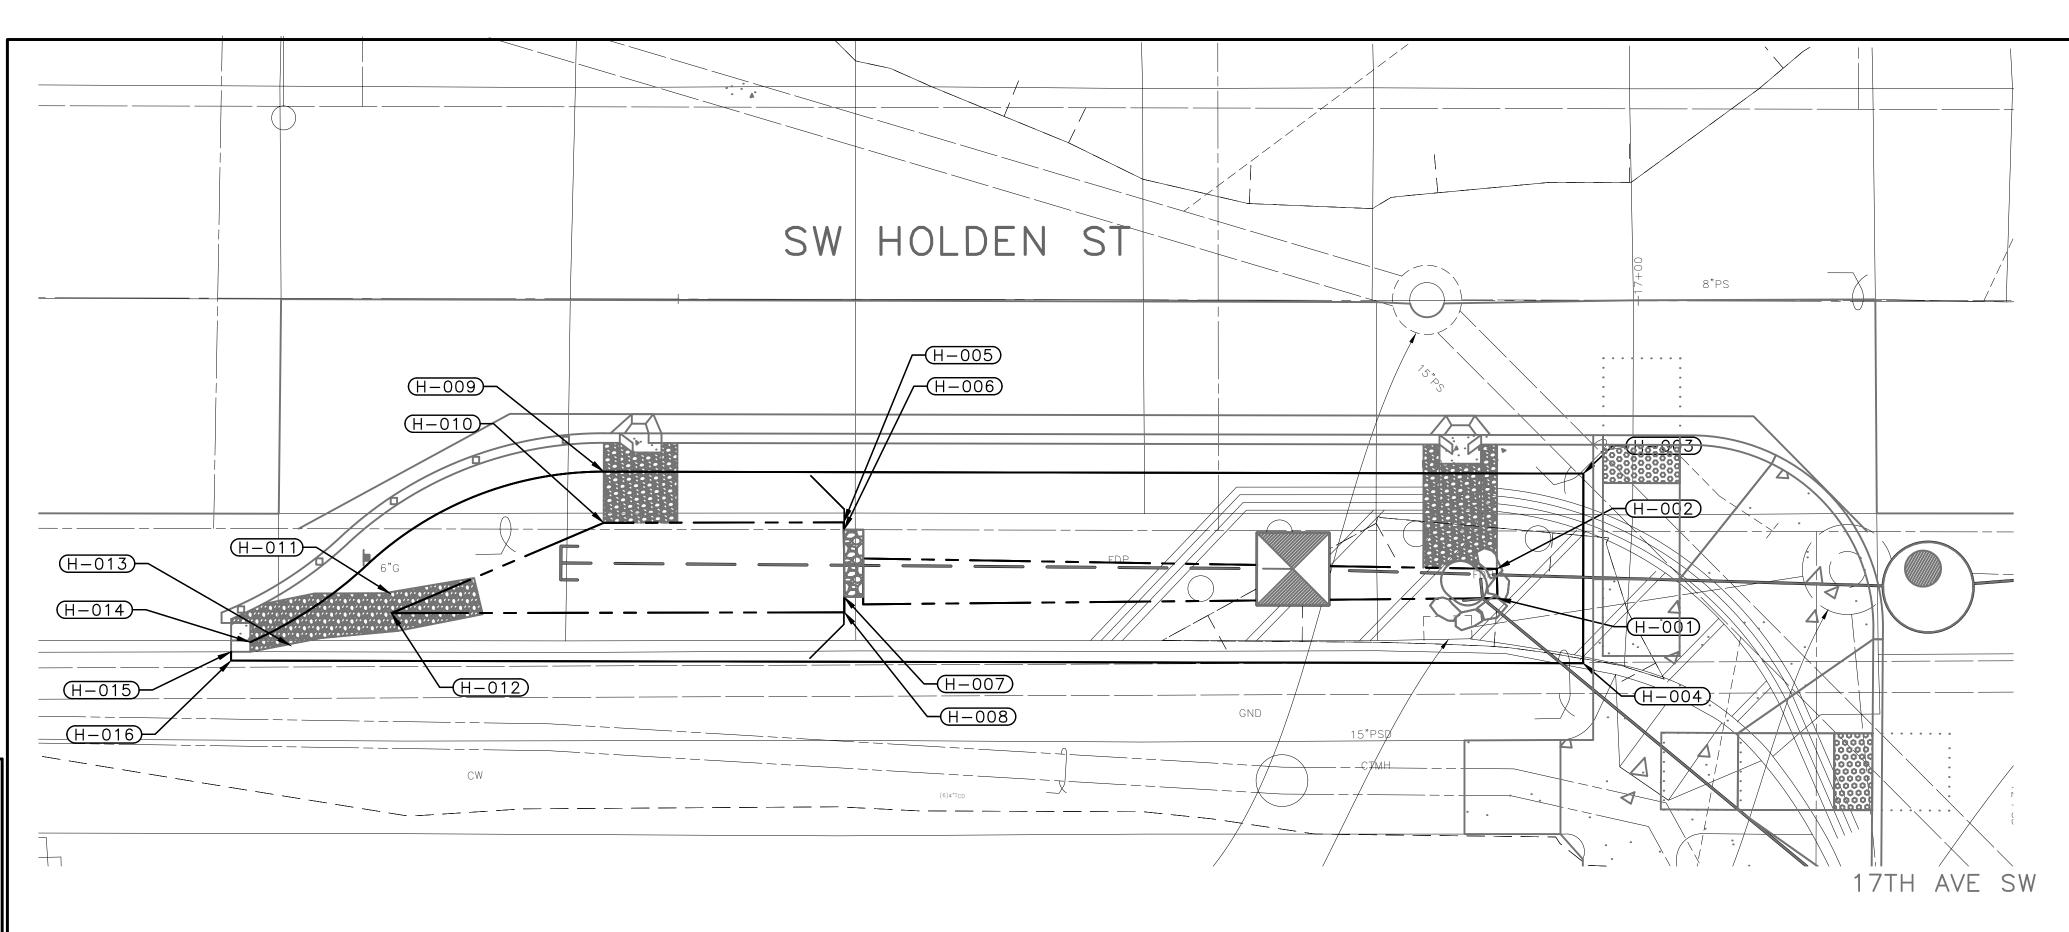
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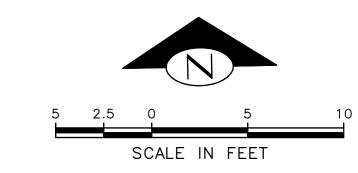
HOLDEN NDS

C600855 792-752 CU205

SHEET 18 OF 36


STORM DETAILS (4 OF 4)





GENERAL NOTES

- 1. SEE SHEET 12 FOR STORM INFRASTRUCTURE AND GRADING.
- 2. SEE SHEETS 23, 29, AND 33 FOR ADDITIONAL GRADING AND RESTORATION INFORMATION OUTSIDE BIORETENTION AREAS.
- 3. START AND END CELL ELEVATIONS ARE TOP OF MULCH ELEVATION AT CENTERLINE OF BIORETENTION
- 4. SLOPE LABEL ARROWS POINT DOWN SLOPE
- 5. MODULAR SUBSURFACE SOIL CELL SYSTEM NOT SHOW FOR CLARITY
- 6. BIORETENTION WEIRS SHALL BE INSTALLED PERPENDICULAR TO ROADWAY CENTERLINE.
- 7. BIORETENTION WEIR TYPE A PER
- 8. BIORETENTION WEIR TYPE B PER
- 9. BIORETENTION BOTTOM AREA CROSS SLOPE (PERPENDICULAR TO ROADWAY CENTERLINE) IS ZERO (FLAT), TYPICAL

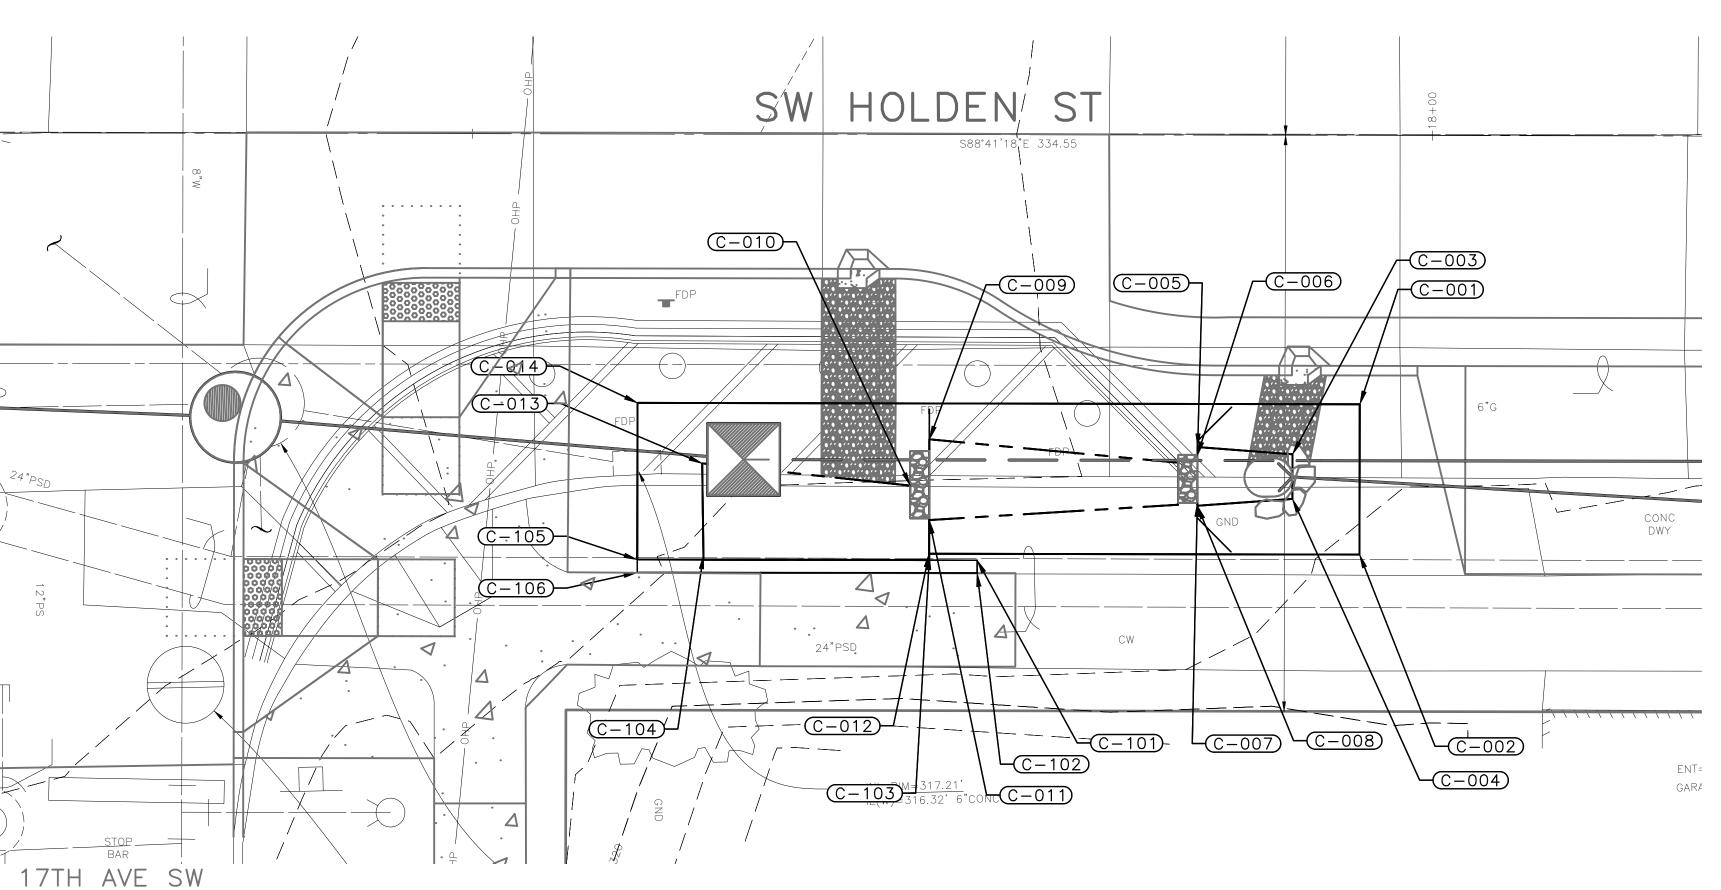

WEIR TABLE

	14/1 117	WEIR		NOTCH CL STA,	TOP OF
WEIR		TYPE	PLATE WIDTH	OFF	NOTCH EL
	H-1	Α	8	STA 16+58.7, 13.9'RT	315.42
	C-1	Α	8	STA 17+73.84, 18.2'RT	318.04
	C-2	В	7	STA 17+87.80, 17.9'RT	317.91

BIC	NTROL TABLE		
POINT	ELEV	STATION/OFFSET	DESCRIPTION
C-101	318.47	STA 17+76.34, 22.16'RT	TOP OF WALL ELEV
C-102	318.48	STA 17+76.34, 22.83'RT	TOP OF WALL ELEV
C-103	316.91	STA 17+73.86, 21.96'RT	BOTTOM OF WALL ELEV
C-104	316.91	STA 17+62.08, 21.94'RT	BOTTOM OF WALL ELEV
C-105	317.97	STA 17+58.64, 22.16'RT	TOP OF WALL ELEV
C-106	317.96	STA 17+58.64, 22.83'RT	TOP OF WALL ELEV

BIORETENTION ENLARGEMENTS - SW HOLDEN ST (1 OF 2)



HOLDEN NDS

PC C600855 co VPI # 792-752

CU206

60% SIP SUBMITTAL

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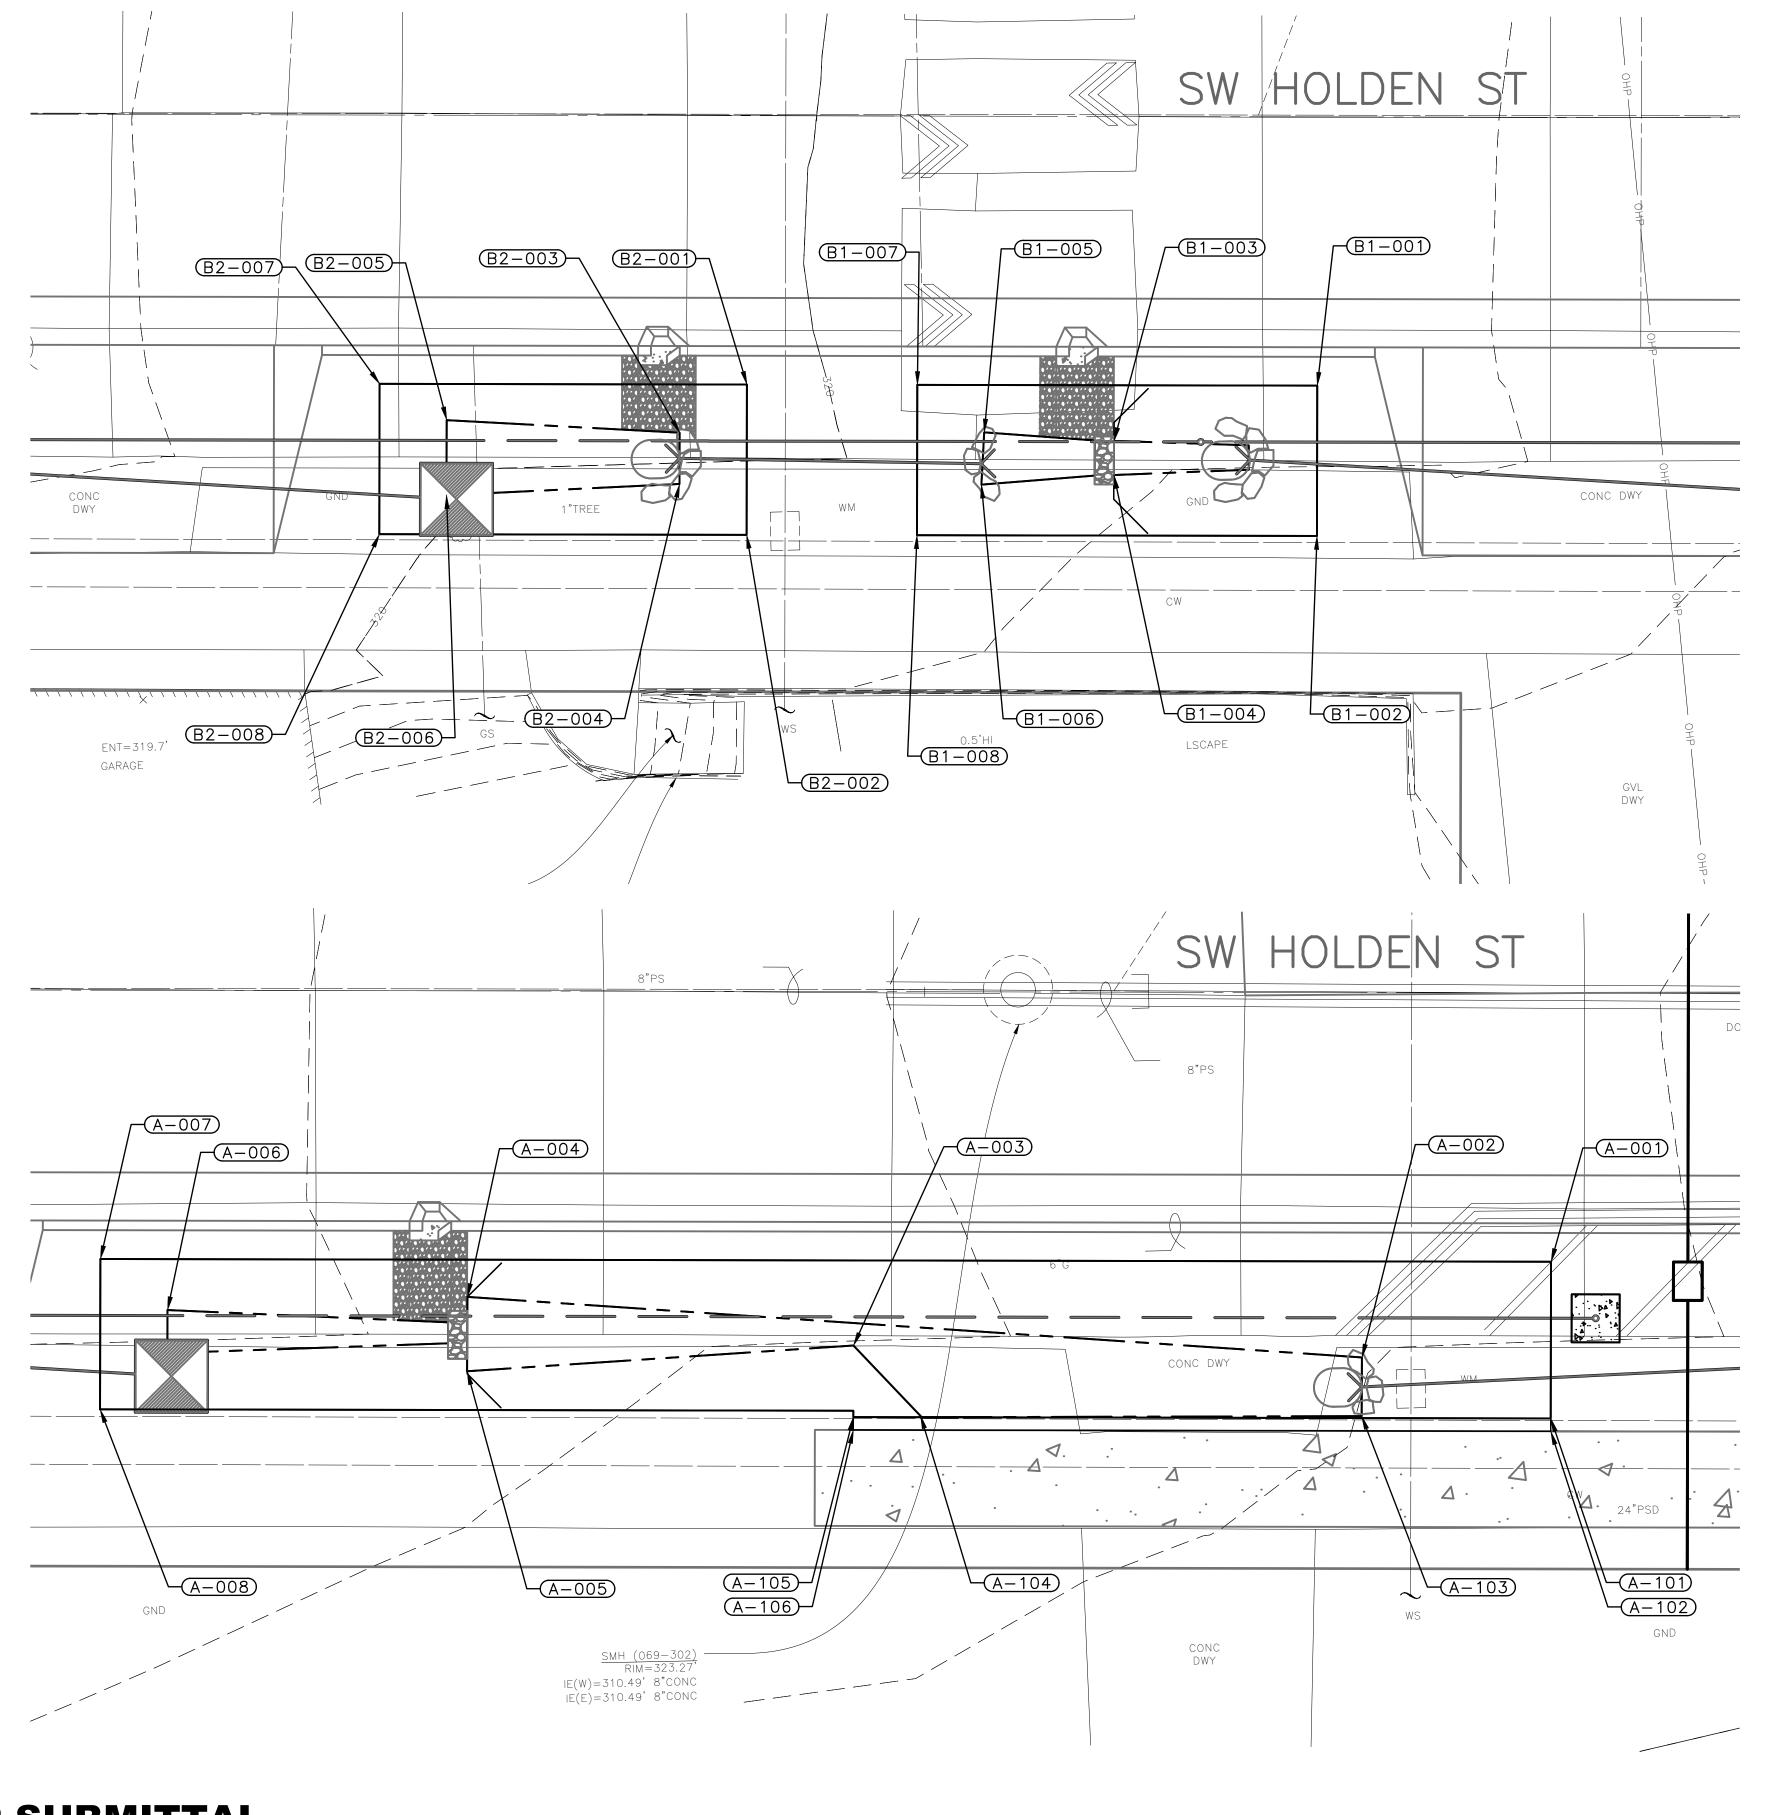
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ALL WORK SHALL BE DONE IN ACCORDANCE WITH THE CITY OF SEATTLE STANDARD PLANS AND SPECIFICATIONS AND OTHER DOCUMENTS CALLED FOR IN SECTION 0-02 3 OF THE PROJECT MANUAL SPECIFICATIONS AND OTHER DOCUMENTS CALLED FOR IN SECTION 0-02 3 OF THE PROJECT MANUAL

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SHEET 19 OF 36



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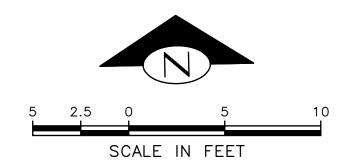
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PROJ. MGR.



GENERAL NOTES

- 1. SEE SHEET 13 FOR STORM INFRASTRUCTURE AND GRADING.
- 2. SEE SHEETS 24 AND 34 FOR ADDITIONAL GRADING AND RESTORATION INFORMATION OUTSIDE BIORETENTION AREAS.
- 3. START AND END CELL ELEVATIONS ARE TOP OF MULCH
- ELEVATION AT CENTERLINE OF BIORETENTION
- 4. SLOPE LABEL ARROWS POINT DOWN SLOPE
- 5. MODULAR SUBSURFACE SOIL CELL SYSTEM NOT SHOW FOR CLARITY
- 6. BIORETENTION WEIRS SHALL BE INSTALLED PERPENDICULAR TO ROADWAY CENTERLINE.
- 7. BIORETENTION WEIR TYPE A PER
- 8. BIORETENTION WEIR TYPE B PER
- 9. BIORETENTION BOTTOM AREA CROSS SLOPE (PERPENDICULAR TO ROADWAY CENTERLINE) IS ZERO (FLAT), TYPICAL

WEIR TABLE

	WEIR	WEIR	NOTCH	NOTCH CL STA,	TOP OF
WEIR		TYPE	PLATE WIDTH	OFF	NOTCH EL
	A-1	Α	8	STA 16+58.7, 13.9'RT	321.97
	B-1	Α	8	STA 18+65.51, 17.9'RT	320.04

BIORETENTION WALL CONTROL TABLE			
POINT	ELEV	STATION/OFFSET	DESCRIPTION
A-101	324.36	STA 19+82.65, 22.16'RT	TOP OF WALL ELEV
A-102	324.36	STA 19+82.65, 22.83'RT	TOP OF WALL ELEV
A-103	321.91	STA 19+72.80, 22.06'RT	BOTTOM OF WALL ELEV
A-104	321.91	STA 19+49.82, 22.06'RT	BOTTOM OF WALL ELEV
A-105	323.37	STA 19+46.32, 22.16'RT	TOP OF WALL ELEV
A-106	323.37	STA 19+46.32, 22.83'RT	TOP OF WALL ELEV

60% SIP SUBMITTAL

BIORETENTION ENLARGEMENTS - SW HOLDEN ST (2 OF 2)



ORDINANCE NO.

HOLDEN NDS

792-752 CU207

SHEET 20 OF 36

BIORETENTION GRADING CONTROL TABLE				
POINT	ELEV	STATION/OFFSET	DESCRIPTION	
B1-001	321.16	STA 18+76.09, 14.00'RT	_	
B1-002	321.29'	STA 18+76.09, 21.83'RT	_	
B1-003	319.70	STA 18+65.51, 16.90'RT	_	
B1-004	319.70	STA 18+65.51, 18.68'RT	_	
B1-005	319.68'	STA 18+58.75, 16.47'RT	_	
B1-006	319.68'	STA 18+58.61, 19.19'RT	_	
B1-007	320.57	STA 18+55.26, 14.00'RT	_	
B1-008	320.63	STA 18+55.26, 21.83'RT	_	

BIORETENTION GRADING CONTROL TABLE				
POINT	ELEV	STATION/OFFSET	DESCRIPTION	
B2-001	320.28	STA 18+46.39, 14.00'RT	_	
B2-002	320.37	STA 18+46.39, 21.83'RT	-	
B2-003	319.22	STA 18+42.89, 16.52'RT	I	
B2-004	319.22	STA 18+42.89, 19.19'RT	I	
B2-005	319.09	STA 18+30.76, 15.89'RT		
B2-006	319.12	STA 18+30.75, 19.79'RT	_	
B2-007	319.77	STA 18+27.26, 14.00'RT	-	
B2-008	319.84	STA 18+27.26, 21.83'RT	_	

BIOR	BIORETENTION GRADING CONTROL TABLE					
POINT	ELEV	STATION/OFFSET	DESCRIPTION			
C-001	318.86	STA 17+96.26, 14.00'RT	_			
C-002	318.97	STA 17+96.26, 21.83'RT	_			
C-003	317.71	STA 17+92.76, 16.62'RT	_			
C-004	317.71	STA 17+92.76, 18.94'RT	_			
C-005	317.71	STA 17+87.81, 16.25'RT	_			
C-006	317.69	STA 17+87.81, 16.66'RT	_			
C-007	317.71	STA 17+87.80, 19.16'RT	_			
C-008	317.71	STA 17+87.81, 19.31'RT	I			
C-009	317.55	STA 17+73.84, 15.87'RT	-			
C-010	317.05	STA 17+72.85, 18.29'RT	_			
C-011	317.35	STA 17+73.84, 20.08'RT	_			
C-012	316.93	STA 17+73.84, 21.83'RT	_			
C-013	317.00'	STA 17+62.01, 17.15'RT	_			
C-014	317.88	STA 17+58.64, 14.00'RT	_			


BIORETENTION GRADING CONTROL TABL				
POINT	ELEV	STATION/OFFSET	DESCRIPTION	
H-001	314.97	STA 16+92.70, 15.50'RT	_	
H-002	314.96	STA 16+92.67, 13.97'RT	_	
H-003	316.39'	STA 16+97.16, 9.00'RT	_	
H-004	316.52	STA 16+97.17, 18.88'RT	_	
H-005	315.61'	STA 16+58.65, 11.62'RT	_	
H-006	315.53	STA 16+58.67, 12.00'RT	_	
H-007	315.42	STA 16+58.67, 15.50'RT	_	
H-008	315.55	STA 16+58.70, 16.30'RT	_	
H-009	316.74	STA 16+46.14, 9.00'RT	_	
H-010	315.70	STA 16+46.15, 11.67'RT	_	
H-011	316.00'	STA 16+35.04, 15.37'RT	_	
H-012	315.72	STA 16+35.10, 16.39'RT	_	
H-013	316.00'	STA 16+29.86, 18.09'RT	_	
H-014	316.16	STA 16+27.75, 17.91'RT	_	

BIORETENTION GRADING CONTROL TABLE					
	POINT	ELEV	STATION/OFFSET	DESCRIPTION	
	H-015	316.88	STA 16+26.75, 18.42'RT	-	
	H-016	316.58	STA 16+26.75, 18.88'RT	_	

60% SIP SUBMITTAL

BIORETENTION GRADING CONTROL TABLES

INITIALS AND DATE APPROVED FOR ADVERTISING DESIGNED DEPARTMENT OF FINANCE & ADMINISTRATIVE SERVICES CHECKED SEATTLE, WASHINGTON 20 . DRAWN CHECKED REVISED AS BUILT PURCHASING AND CONTRACTING

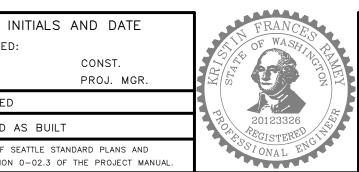



HOLDEN NDS

VPI # 792-752 CU208

SHEET 21 OF 36


NOTE:

1. FOR ADDITIONAL LEGEND INFORMATION, SEE COS STD PLANS (003 SERIES) FOR EXISTING AND PROPOSED STANDARD SYMBOLS AND LEGEND





DRAIN CURB CUT TYPE 3 6

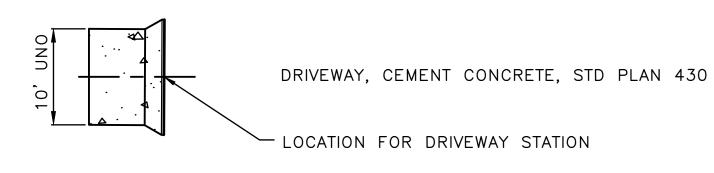

ROADWAY CEM CONC OVER 6" MNRL AGG TYPE 2 PER STD PLAN 402A

CEM CONC SIDEWALK W/ 25% POZZOLANS, PER STD PLAN 420

6" MNRL AGG TYPE 2



CURB RAMPS, TYPES VARY. SEE CURB RAMP SHEETS

TYPE 410C CURB /1

CONSTRUCTION NOTES FOR CIVIL PAVING SHEETS

* NOTE ALL DEPTHS FOR PAVEMENT AND MNRL AGG ARE COMPACTED DEPTHS.

INSTALL CURB CEMENT CONCRETE, W/ 25% POZZOLANS, STD PLAN 410B.

INSTALL MODIFIED TYPE 410C CURB. CEMENT CONCRETE, W/ 25% POZZOLANS, SEE DETAIL 1 ON SHEET 20.



MATCH EXISTING CONCRETE JOINT.



DRAIN CURB CUT TYPE 1 WITH DIMENSIONS PER STD PLAN 295B.



DRAIN CURB CUT TYPE 1 MODIFIED, SEE DETAIL 3 SHEET 28.



DRAIN CURB CUT TYPE 3 WITH DIMENSIONS PER STD PLAN 295D.



MATCH EXISTING SIDEWALK

DRIVEWAY, CEMENT CONCRETE, 6", STD PLAN 430A.



INSTALL SPEED HUMP, STD PLAN 436B.



INSTALL NO PARKING SIGN, STD PLAN 621A AND 621B.



INSTALL OBJECT MARKER, STD PLAN 621A AND 621B.



INSTALL LANE MARKER TYPE 2A, STD PLAN 700.

CONTRACTOR TO COORDINATE REROUTE AND RECONNECTION OF GAS MAIN WITH PUGET SOUND ENERGY (PSE)

60% SIP SUBMITTAL

CIVIL PAVING LEGEND AND NOTES

INITIALS AND DATE INITIALS AND DATE APPROVED FOR ADVERTISING DESIGNED CONST. DEPARTMENT OF FINANCE & ADMINISTRATIVE SERVICES CHECKED PROJ. MGR. SEATTLE, WASHINGTON 20 DRAWN CHECKED EVISED AS BUILT

PURCHASING AND CONTRACTING



Seattle
Public Utilities

ABBREVIATIONS LEGEND

PLANS (002 SERIES)

SIGNAGE LEGEND

OM-3R OBJECT MARKER

R7-NP NO PARKING

BOC XXX.X

BOW XXX.X

BRC

CRZ

TOC

UNO

1. FOR ADDITIONAL ABBREVIATIONS INFORMATION, SEE COS STD

BACK OF CURB ELEVATION

BACK OF WALK ELEVATION

UNLESS NOTED OTHERWISE

CRITICAL ROOT ZONE OF TREE AS DETERMINED BY ARBORIST WHICH DIFFERS FROM ZONE B DEFINED

INSTALL

BIORETENTION CELL

IN STD PLAN 133.

TOP OF CURB


TS-5 5-FOOT SIGN POST PER STD PLAN 625

TS-10 10-FOOT SIGN POST PER STD PLAN NO 625

HOLDEN NDS

C600855 VPI # 792-752

CP001

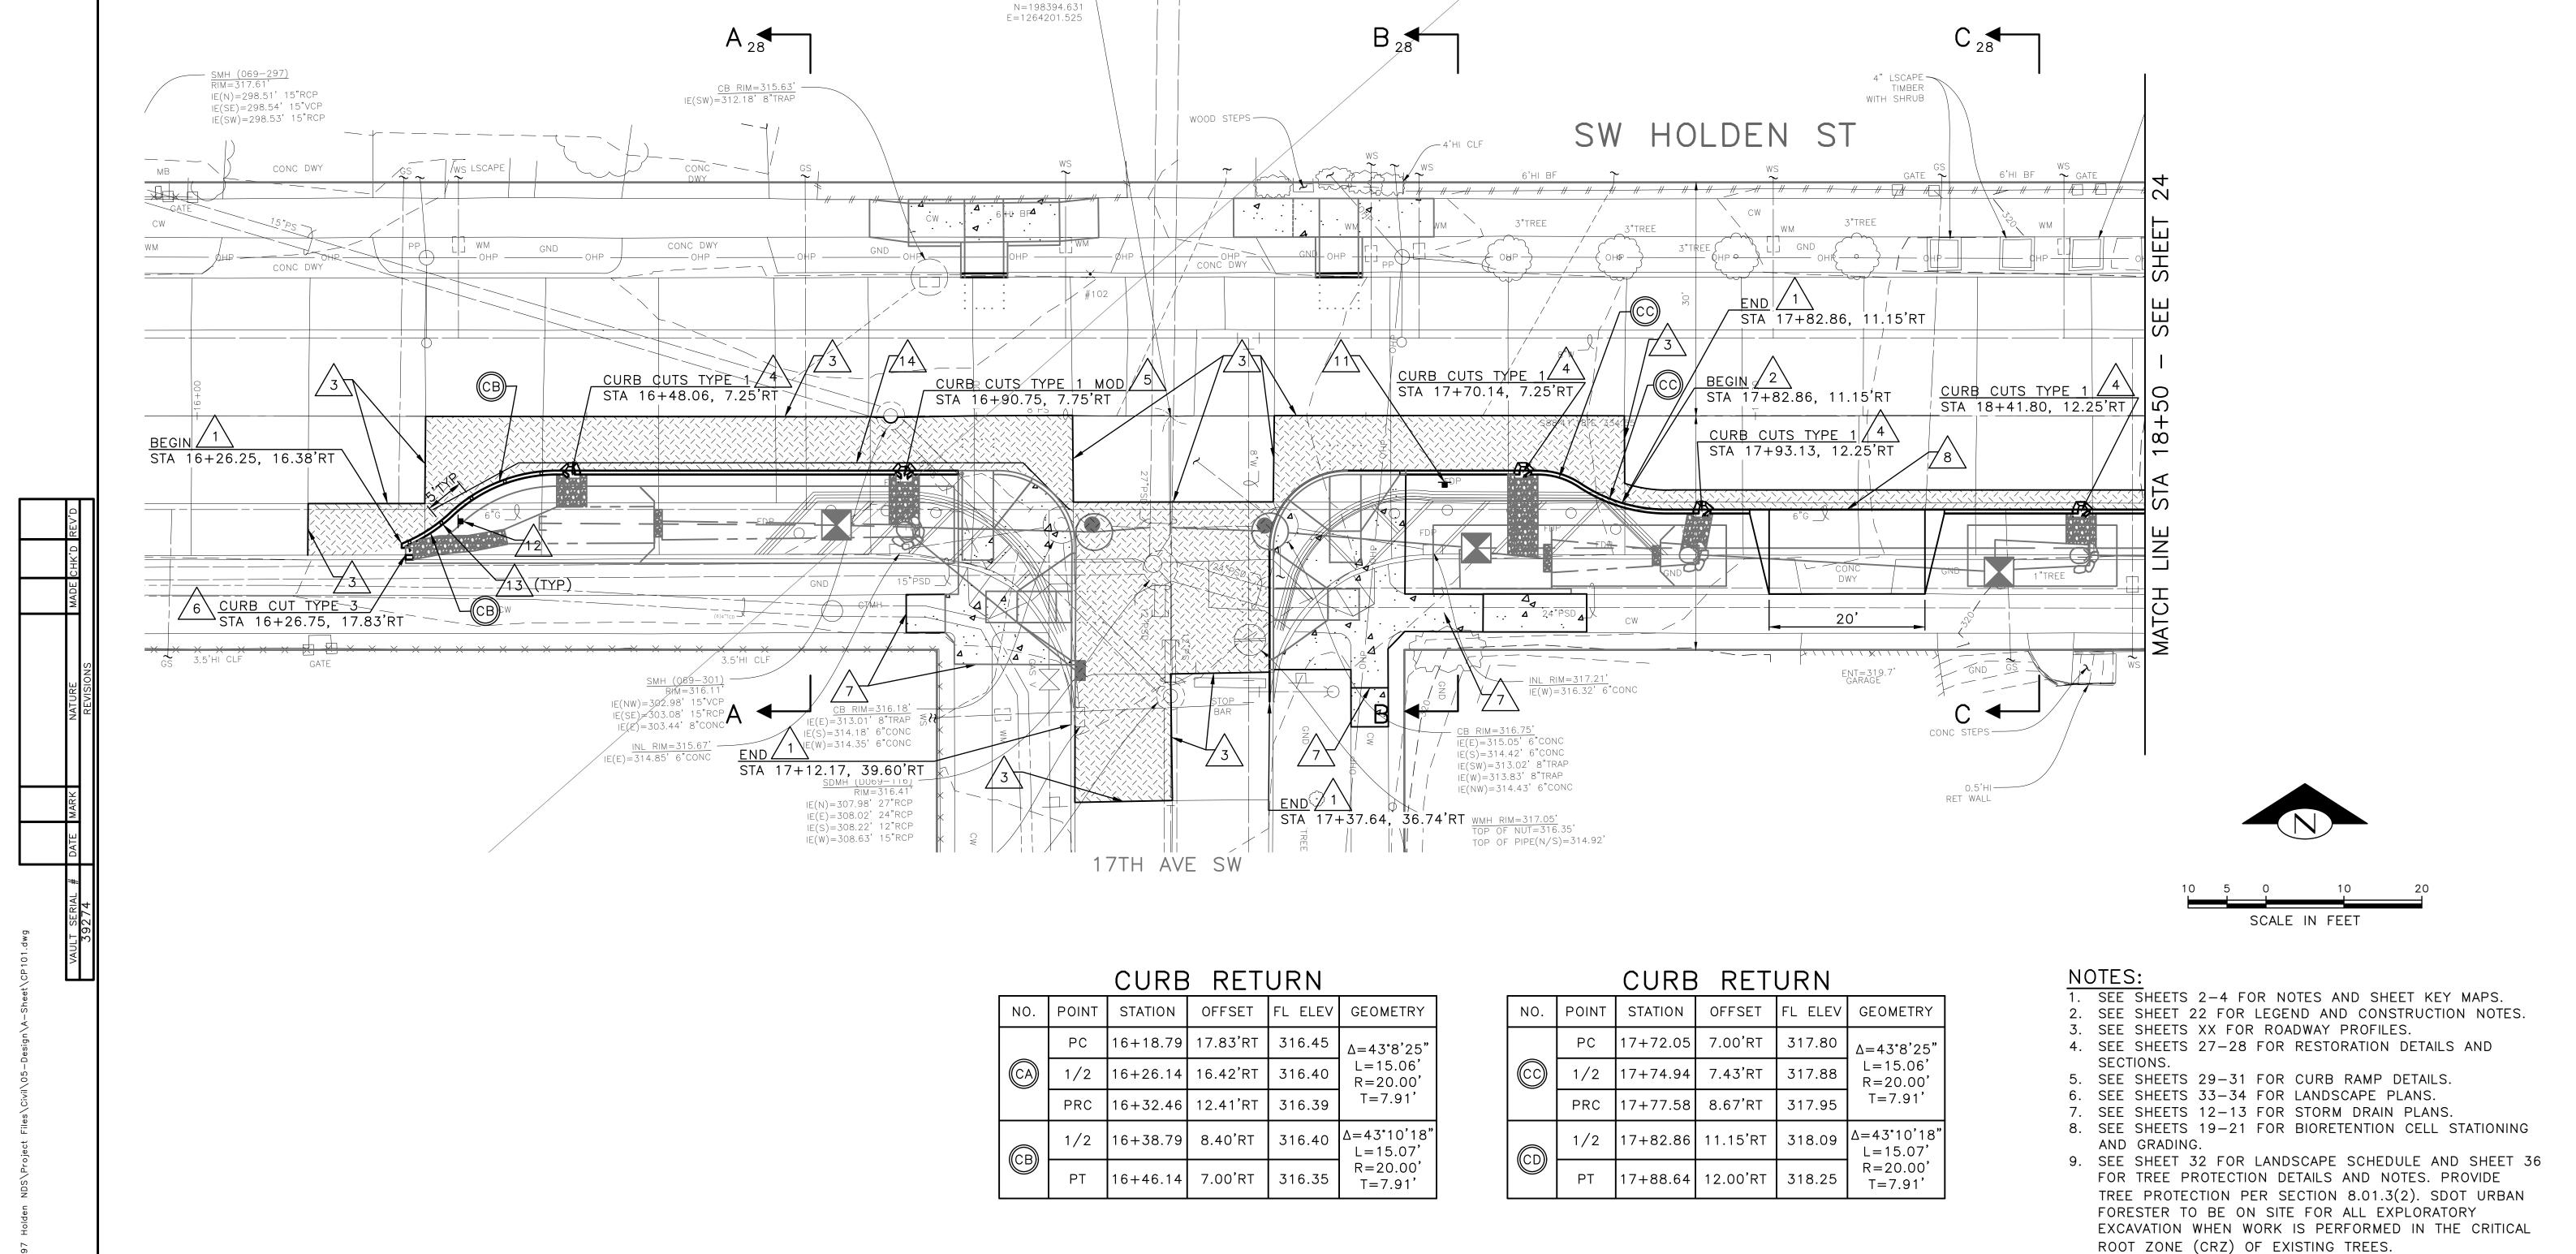

STA: 40+00.00 (17TH AVE SW) STA: 17+24.94 (SW HOLDEN ST)

CALC'D INŤ

RESTORATION PLAN - SW HOLDEN ST (1 OF 2)

Seattle Public Utilities ORDINANCE NO.

HOLDEN NDS

C600855 792-752 CP101 SHEET 23 OF 36


60% SIP SUBMITTAL


INITIALS AND DATE INITIALS AND DATE APPROVED FOR ADVERTISING DESIGNED CONST. DEPARTMENT OF FINANCE & ADMINISTRATIVE SERVICES CHECKED PROJ. MGR. SEATTLE, WASHINGTON 20 . DRAWN CHECKED REVISED AS BUILT

ALL WORK SHALL BE DONE IN ACCORDANCE WITH THE CITY OF SEATTLE STANDARD PLANS AND

PURCHASING AND CONTRACTING

SCALE: 1"=10'

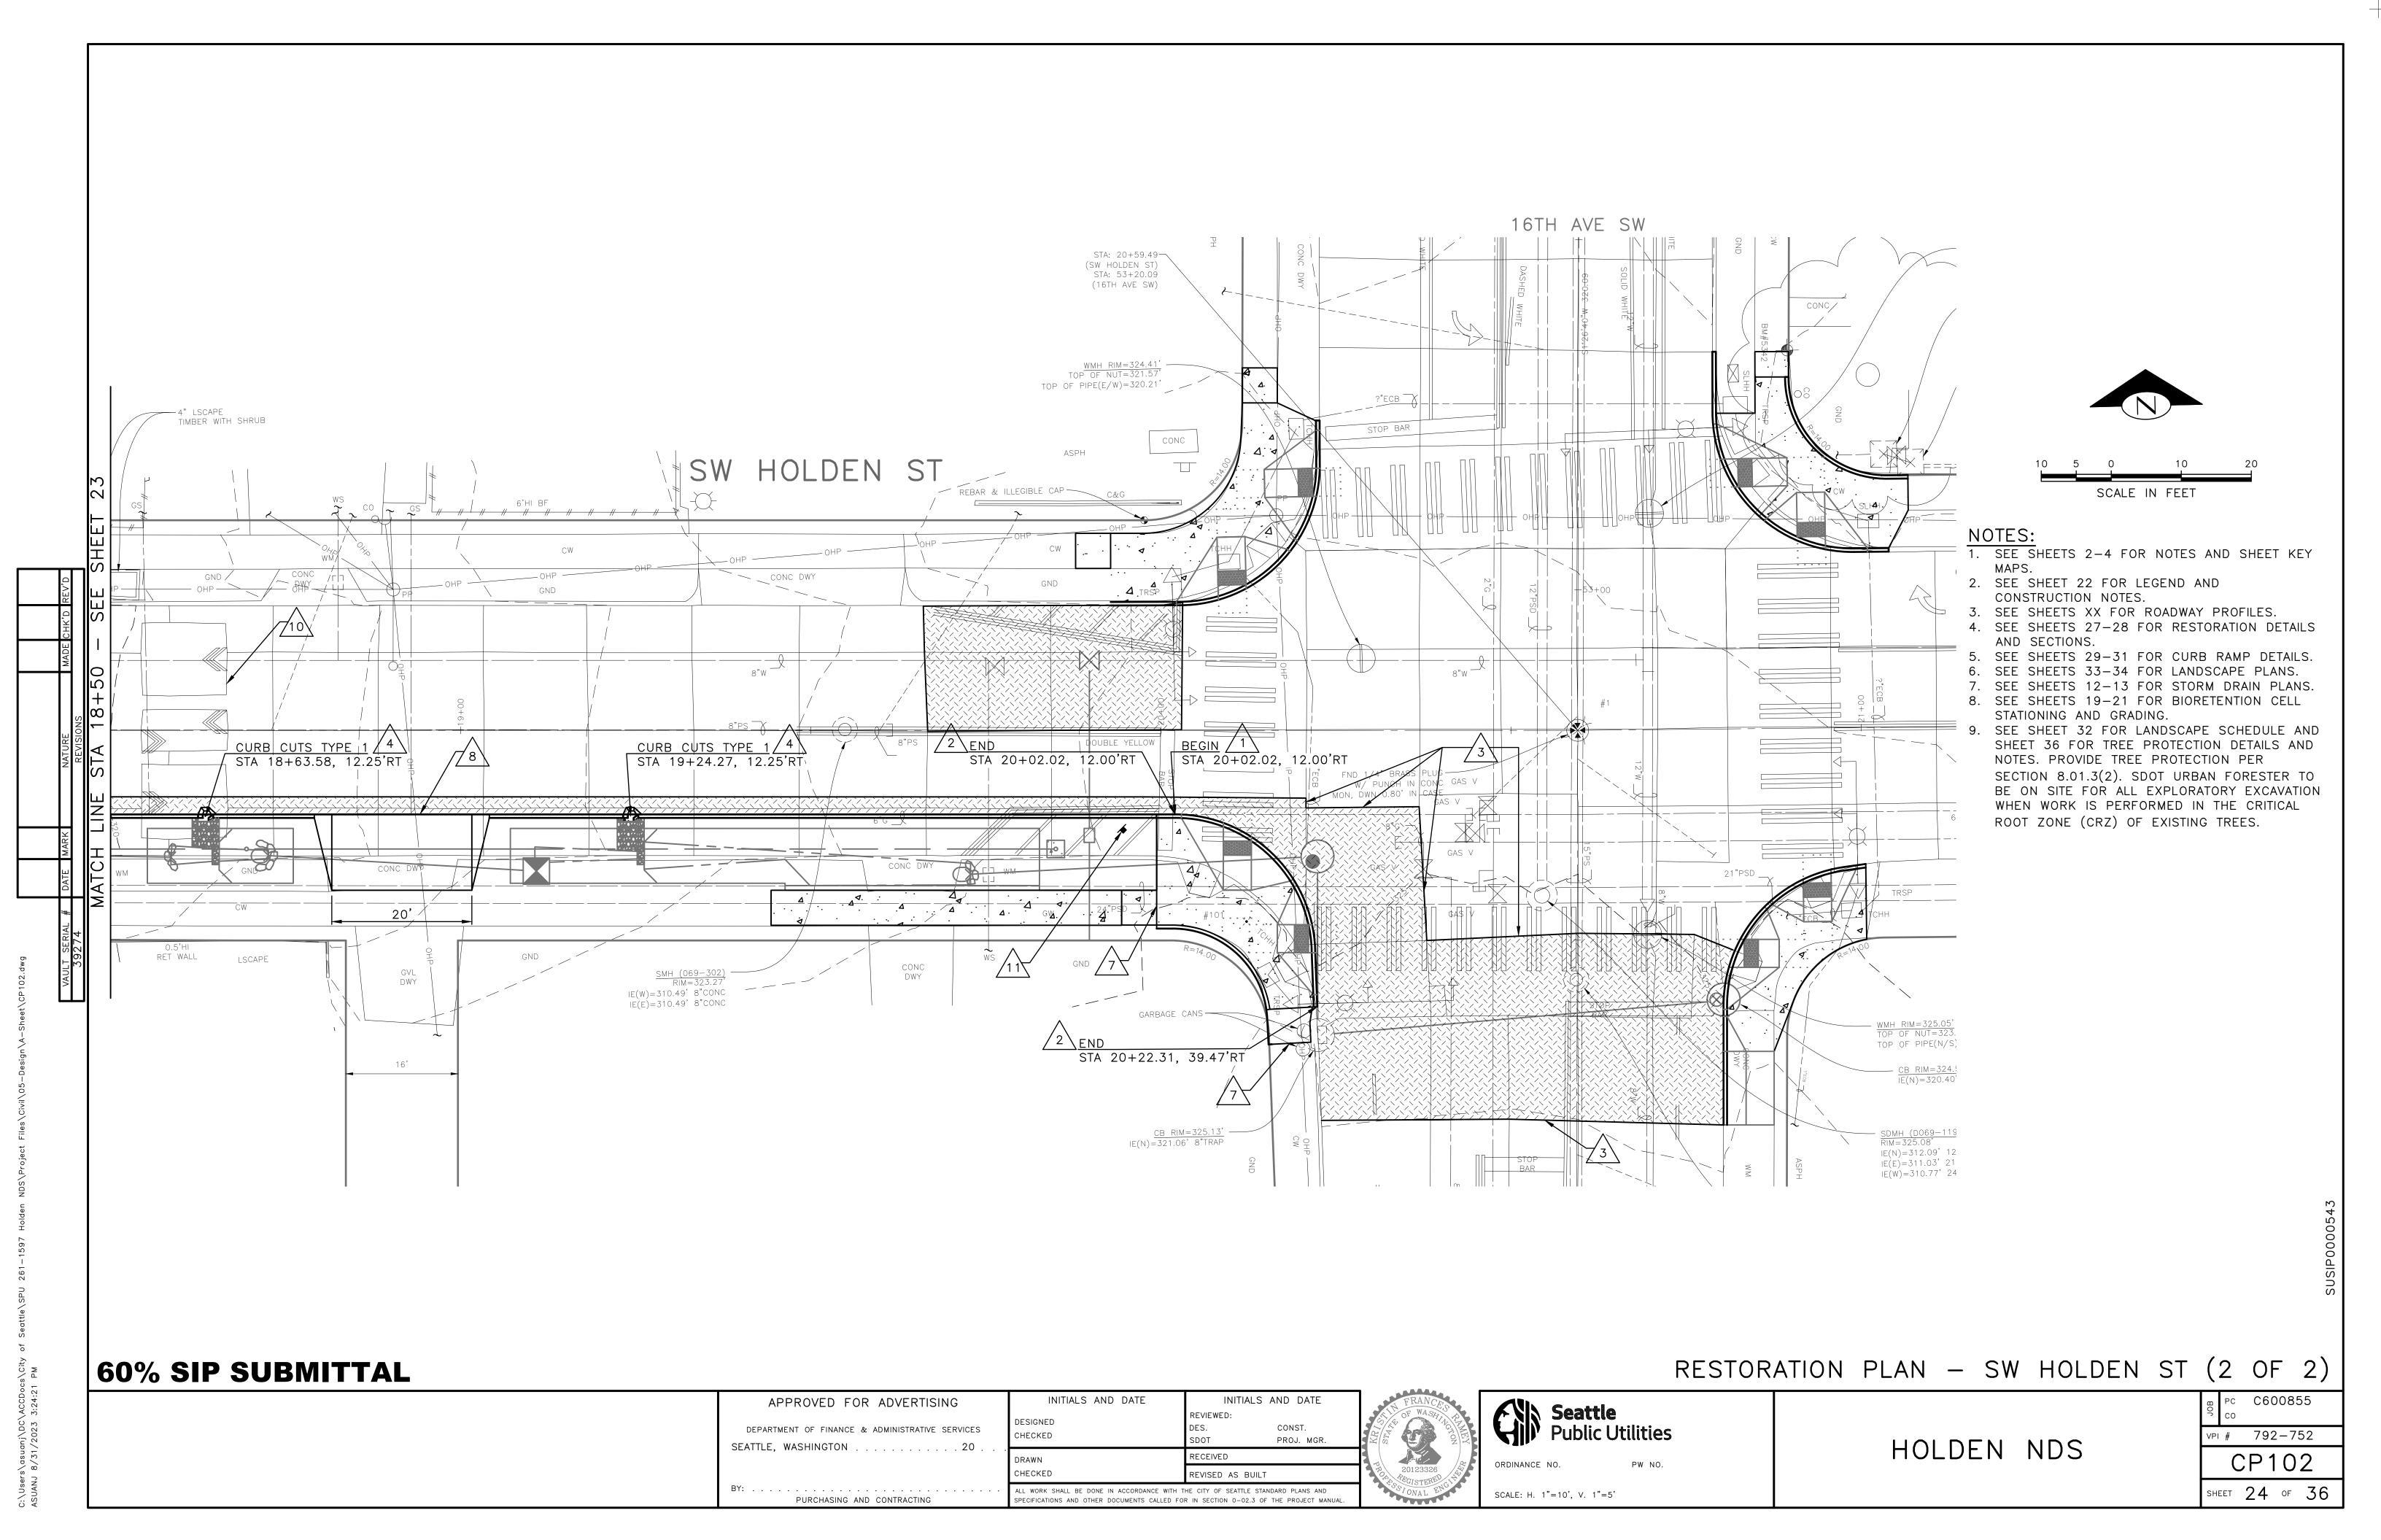

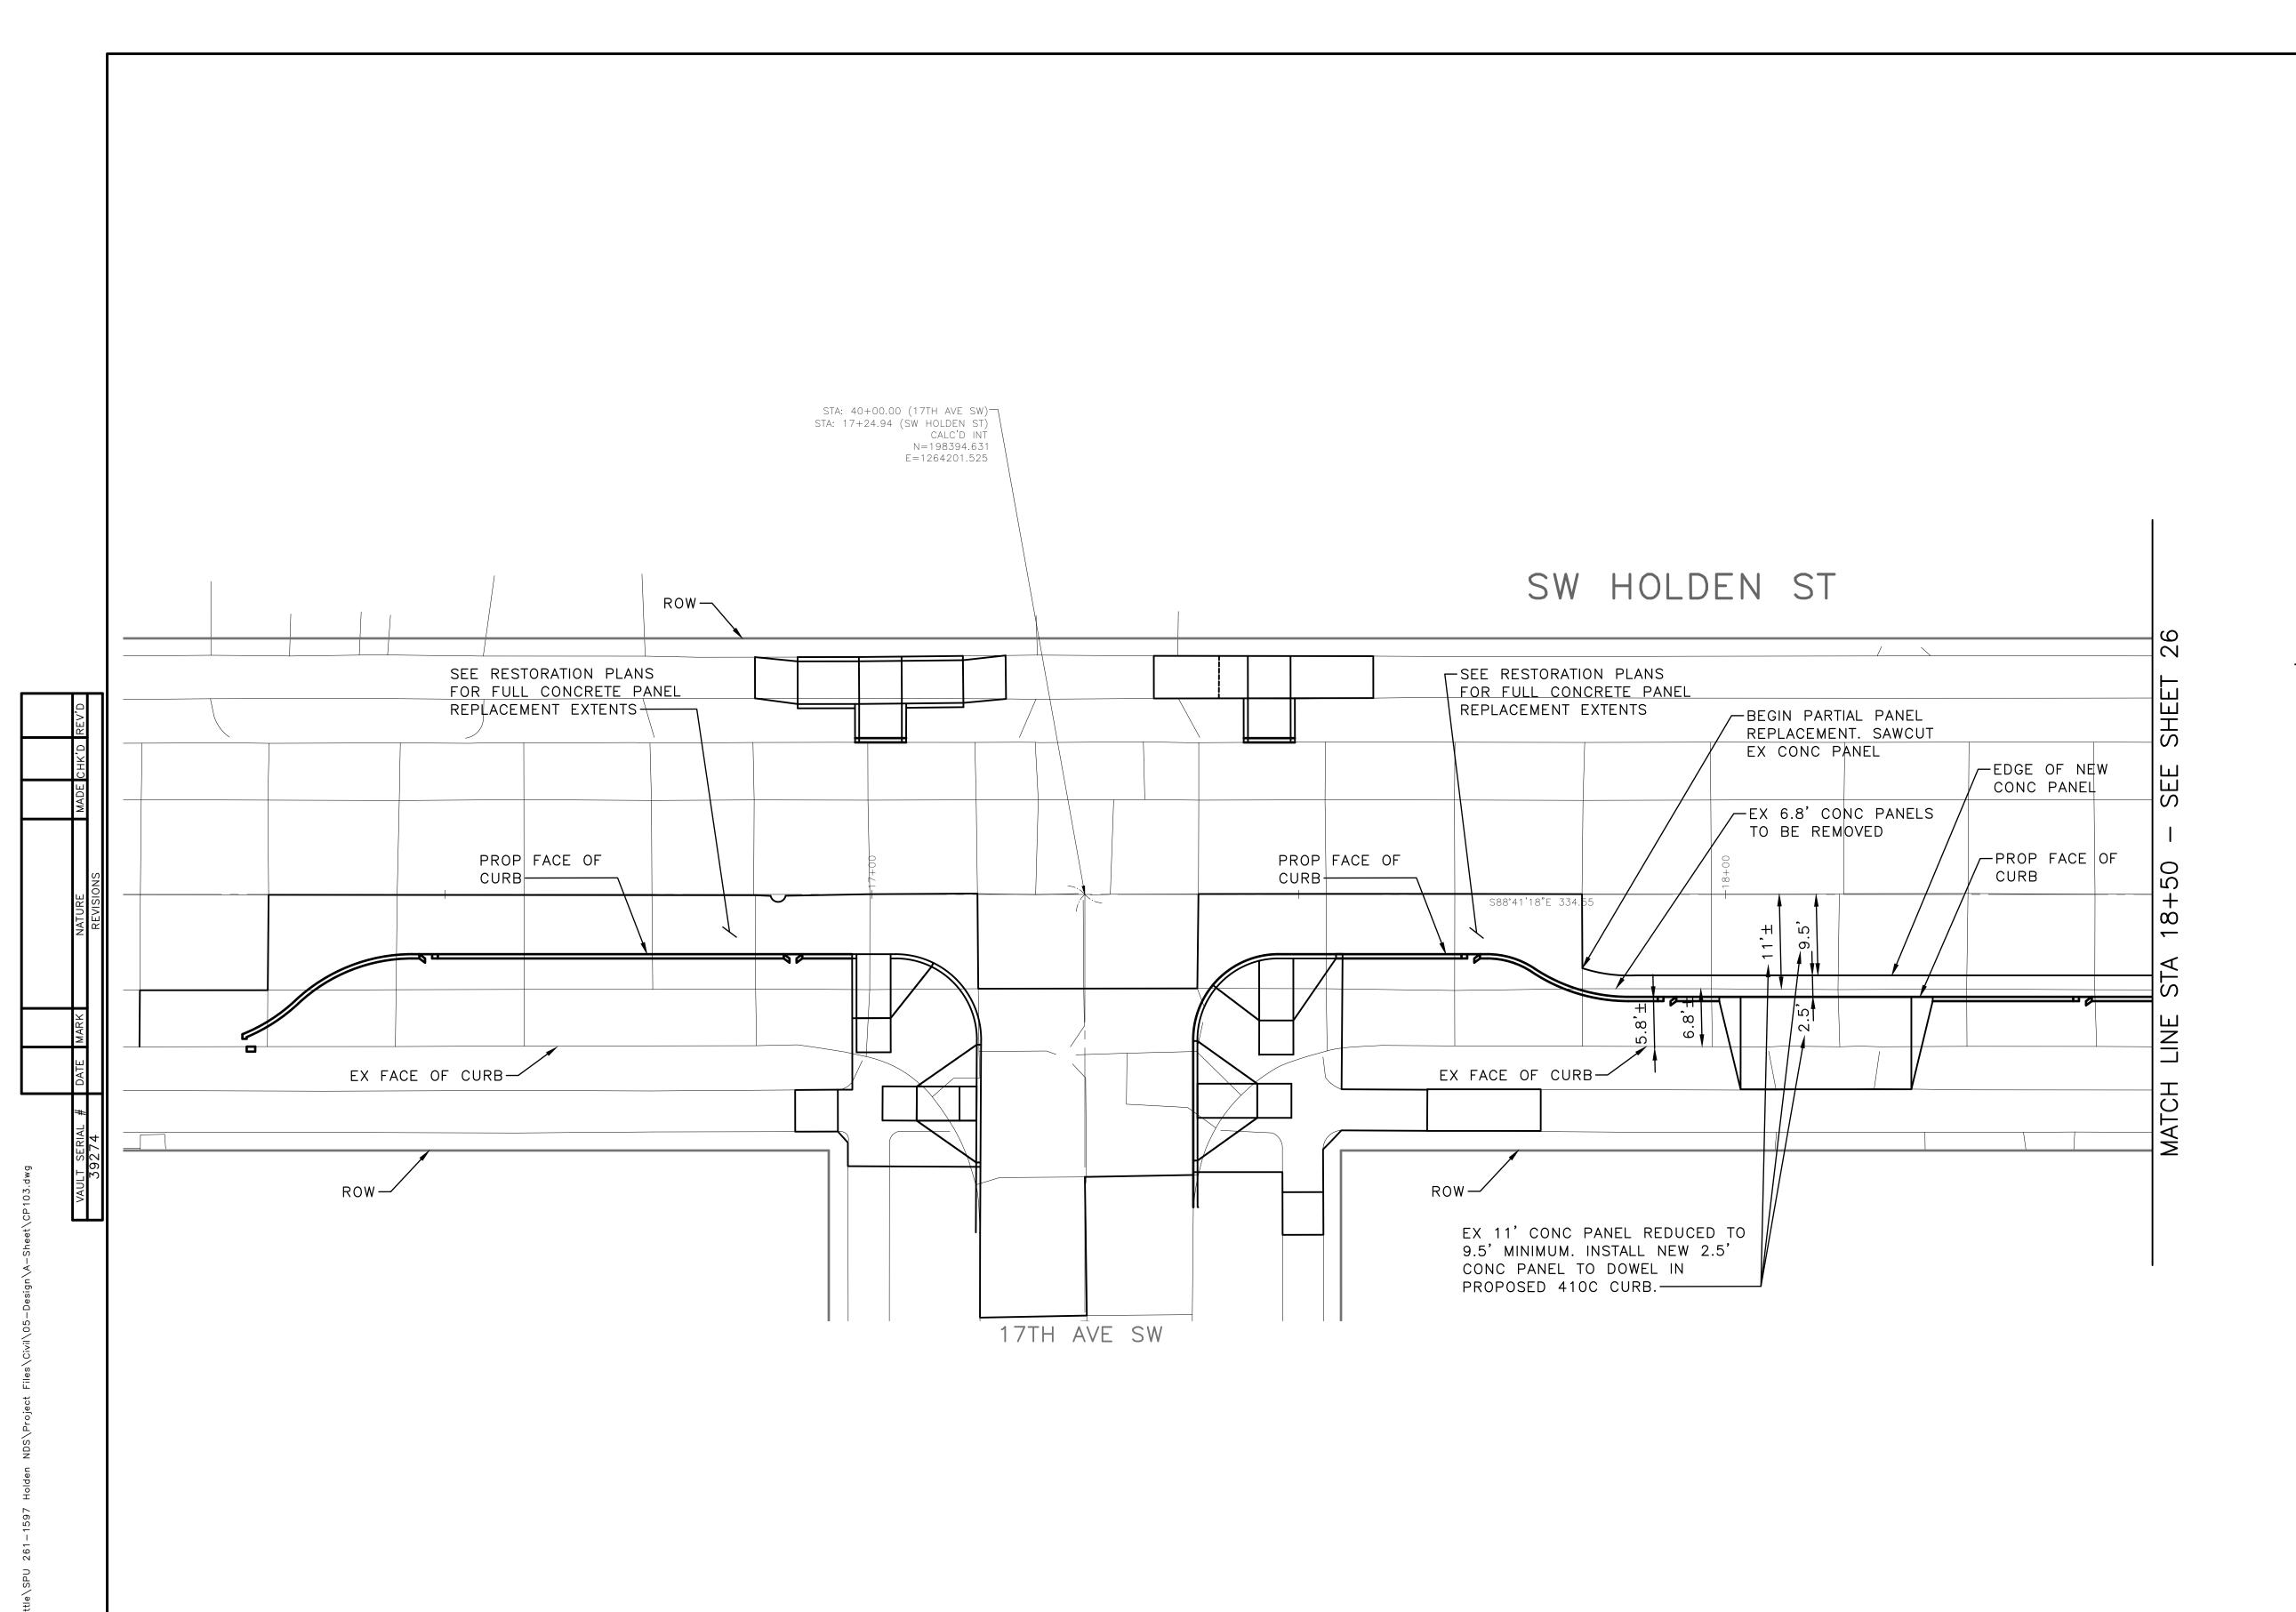


INITIALS AND DATE

DESIGNED

CHECKED

DRAWN

CHECKED

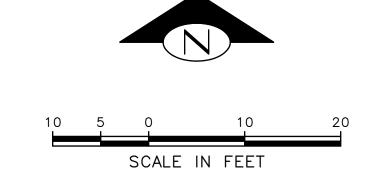

1. JOINTING AND TIE BARS PER STD PLANS 405a, 405b, AND 405c.

Seattle
Public Utilities

ORDINANCE NO.

HOLDEN NDS

JOINTING PLAN (1 OF 2) VPI # 792-752 CP103 SHEET 25 OF 36

60% SIP SUBMITTAL


APPROVED FOR ADVERTISING DEPARTMENT OF FINANCE & ADMINISTRATIVE SERVICES SEATTLE, WASHINGTON 20 . PURCHASING AND CONTRACTING


SCALE: 1"=10'

INITIALS AND DATE

REVISED AS BUILT

PROJ. MGR.

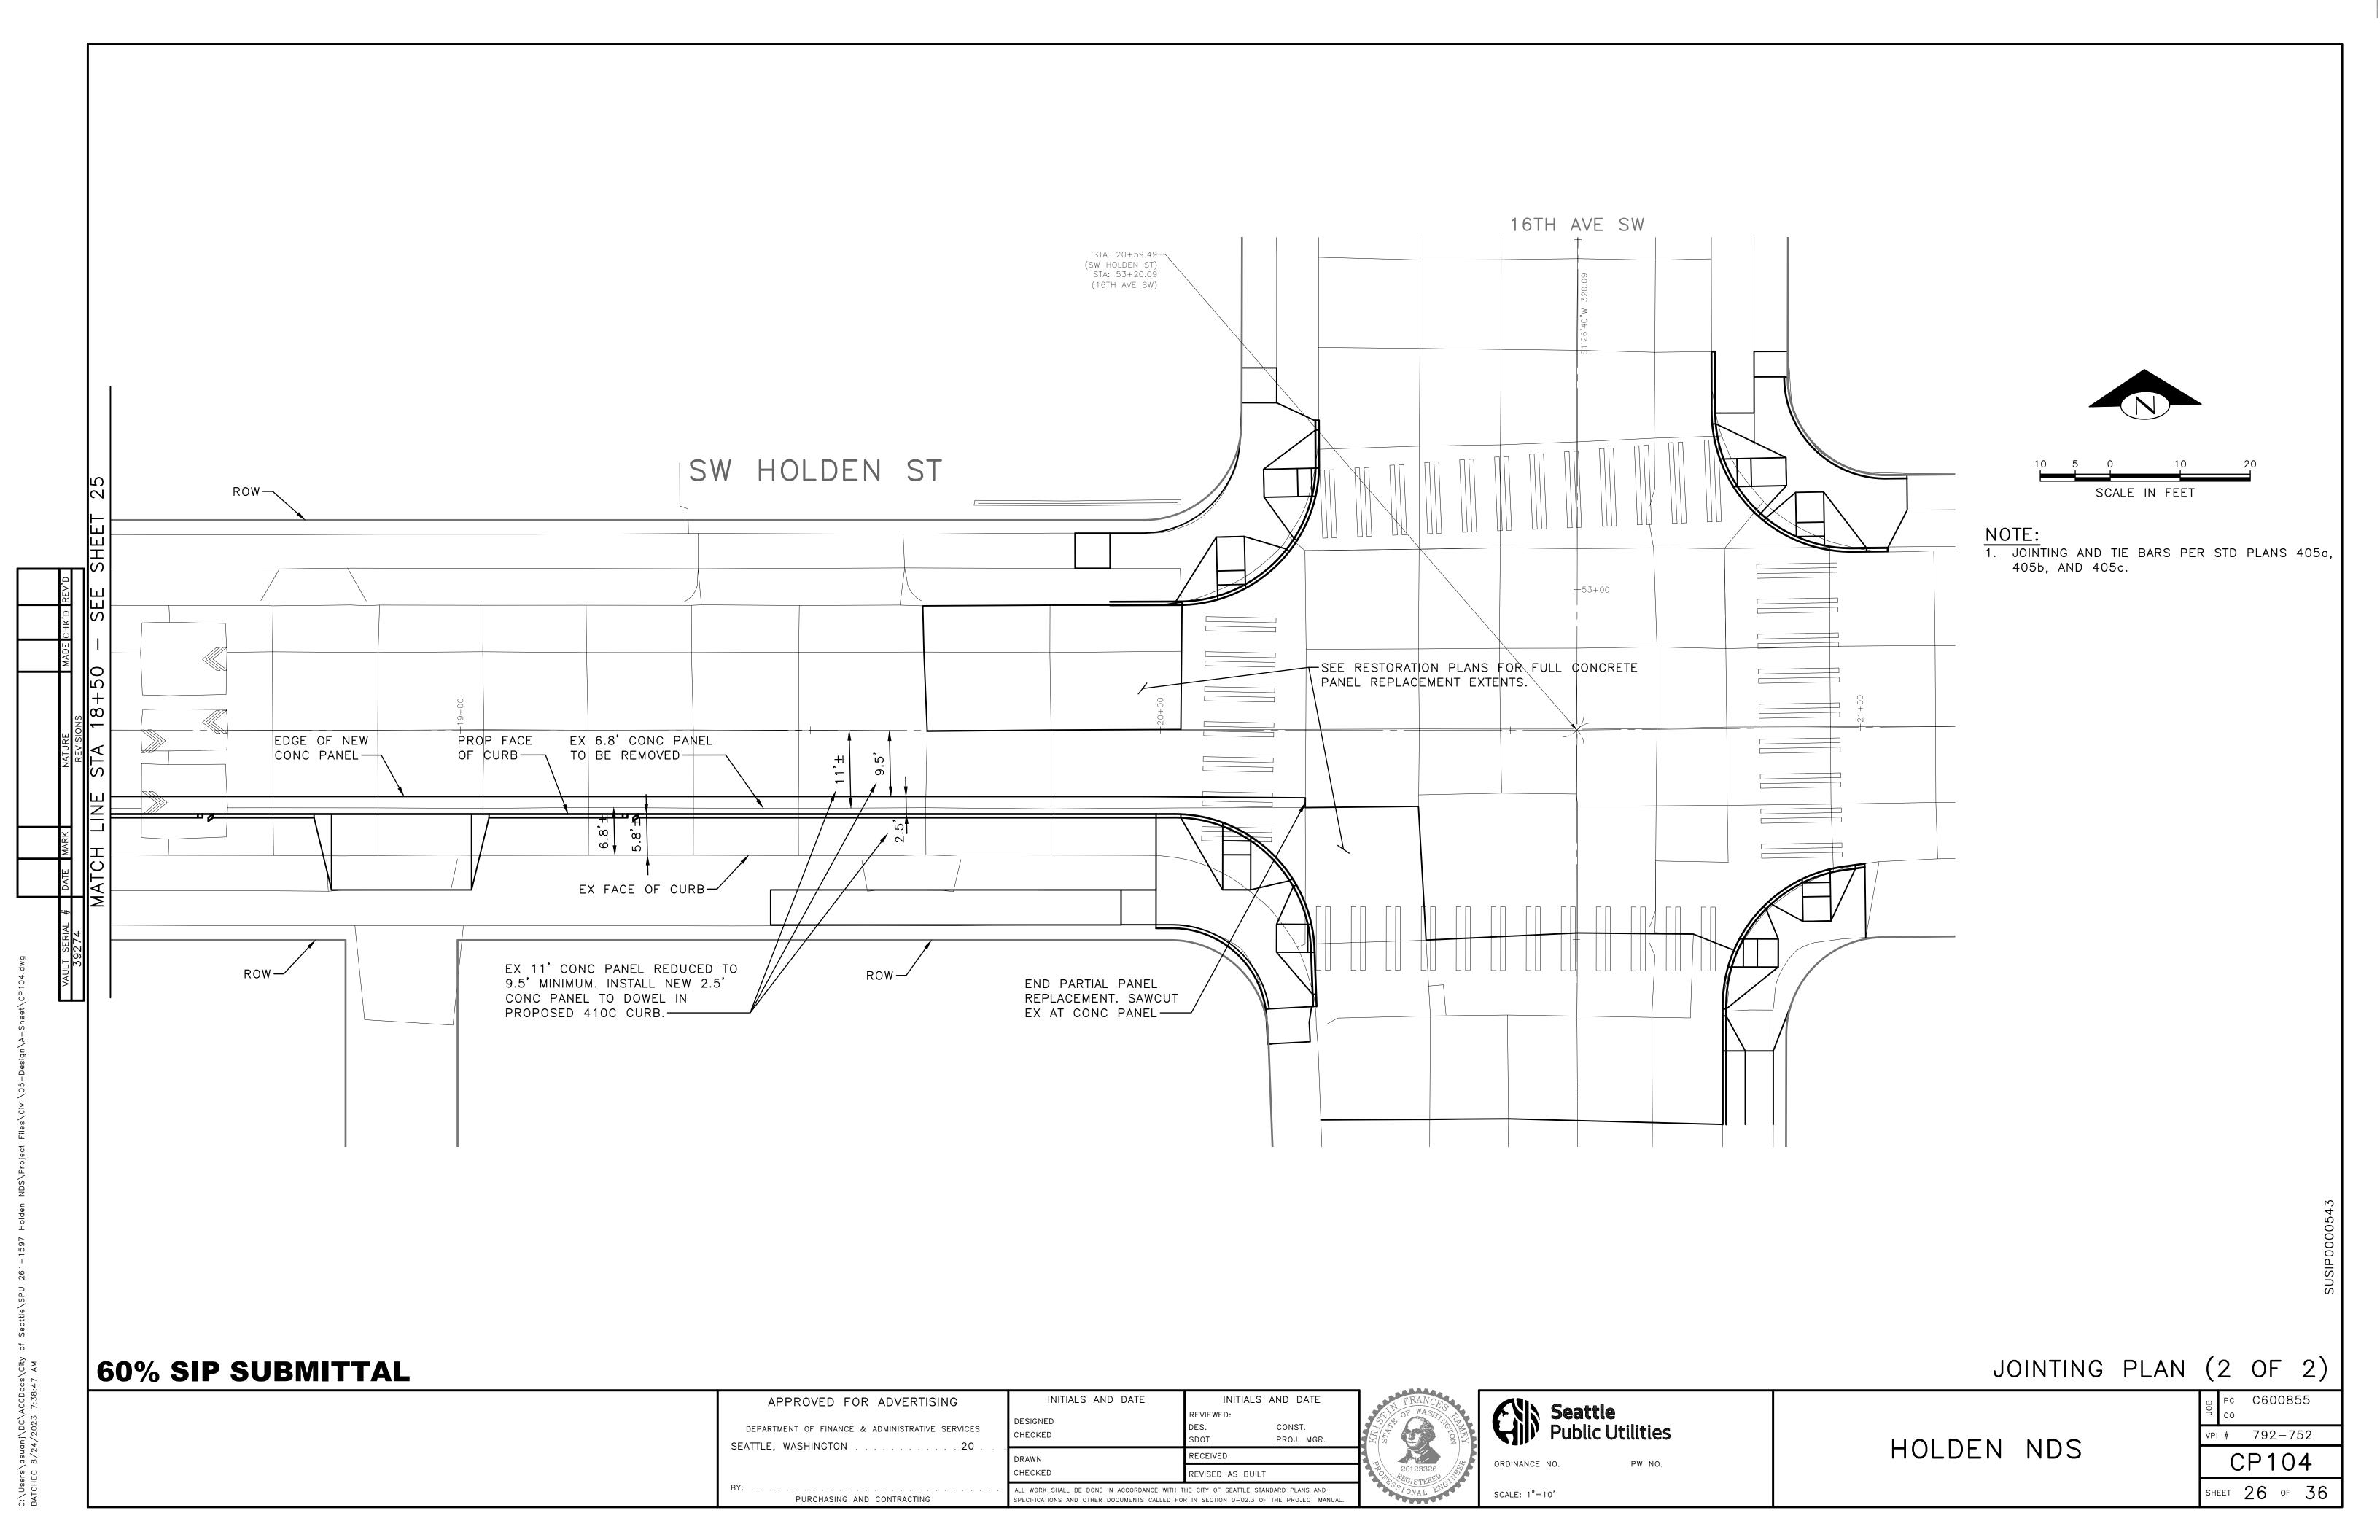

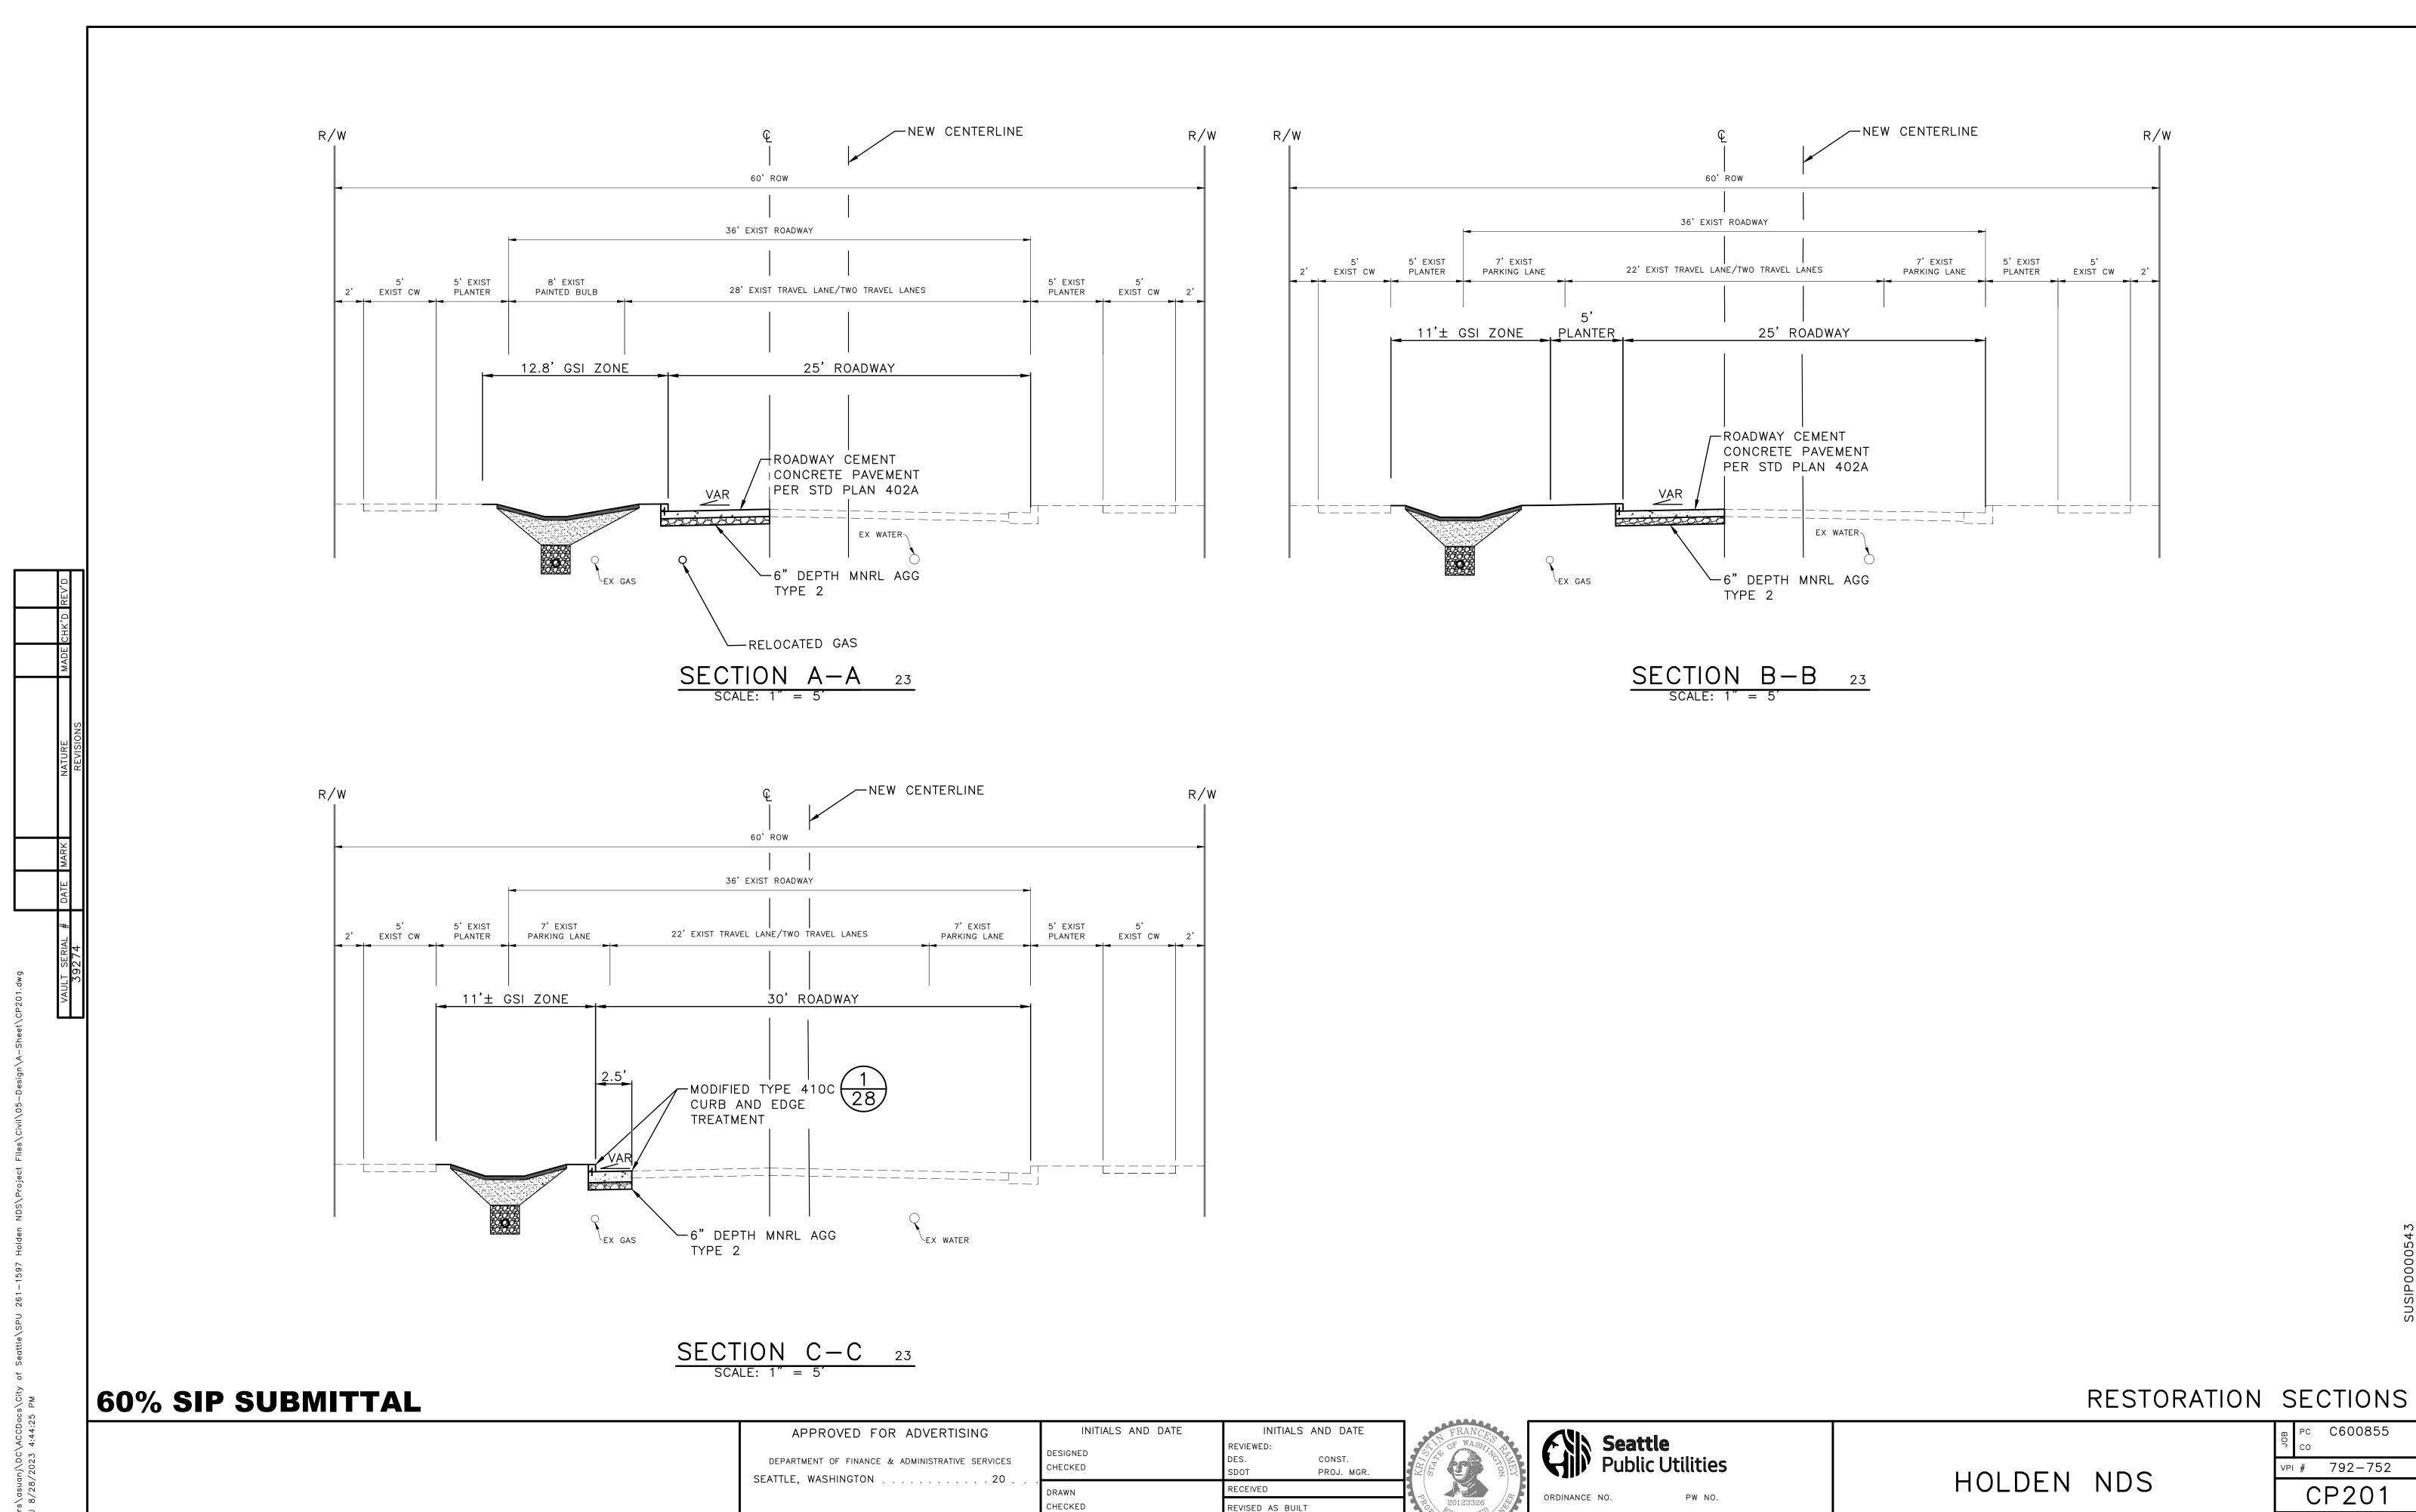


SCALE: AS NOTED

PURCHASING AND CONTRACTING

VPI # 792-752 CP201

SHEET 27 OF 36

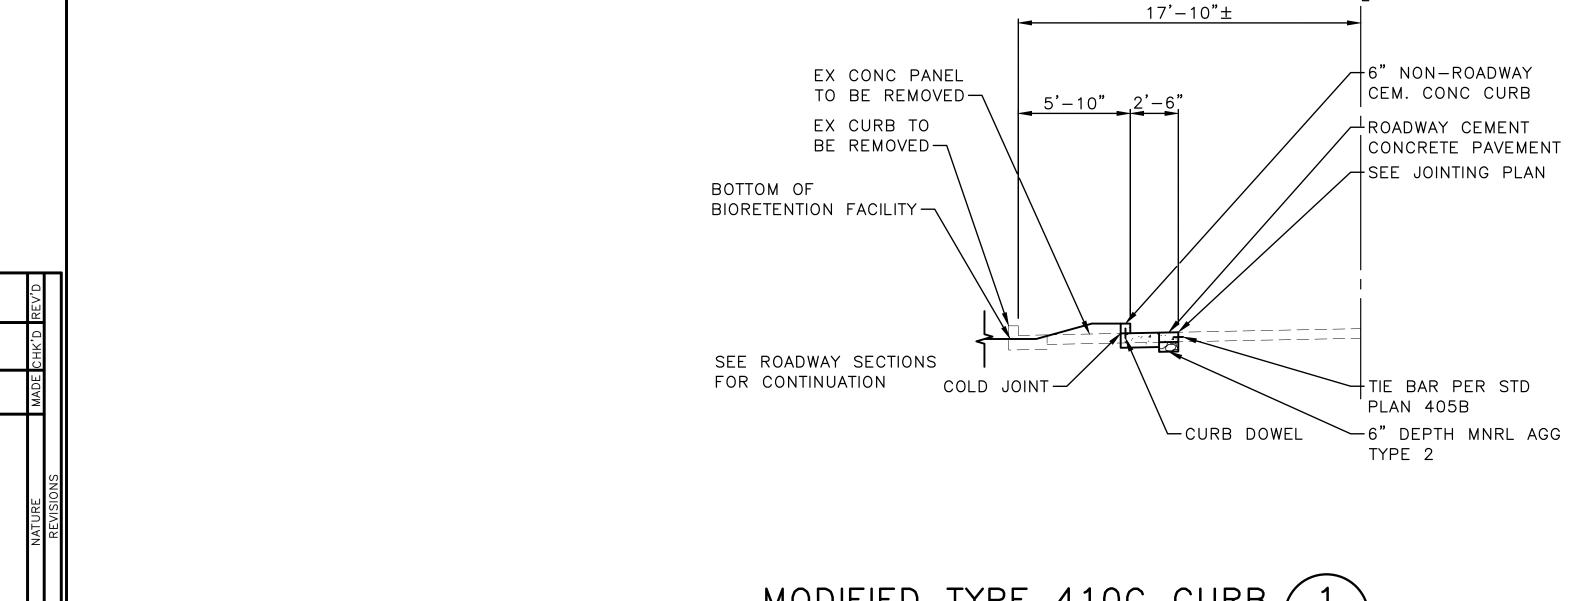

DETAIL TO BE UPDATED AT 90%

MODIFIED TYPE 410C CURB 1

CURB REFLECTIVE PAVEMENT MARKER LAYOUT /

DETAIL TO BE UPDATED AT 90%

DRAIN CURB CUT TYPE 1 MODIFIED (

ORDINANCE NO.

SCALE: AS NOTED

Seattle
Public Utilities


RESTORATION DETAILS VPI # 792-752 CP202

SHEET 28 OF 36

60% SIP SUBMITTAL

INITIALS AND DATE INITIALS AND DATE APPROVED FOR ADVERTISING DESIGNED DEPARTMENT OF FINANCE & ADMINISTRATIVE SERVICES CHECKED PROJ. MGR. SEATTLE, WASHINGTON 20 . DRAWN CHECKED REVISED AS BUILT PURCHASING AND CONTRACTING

HOLDEN NDS

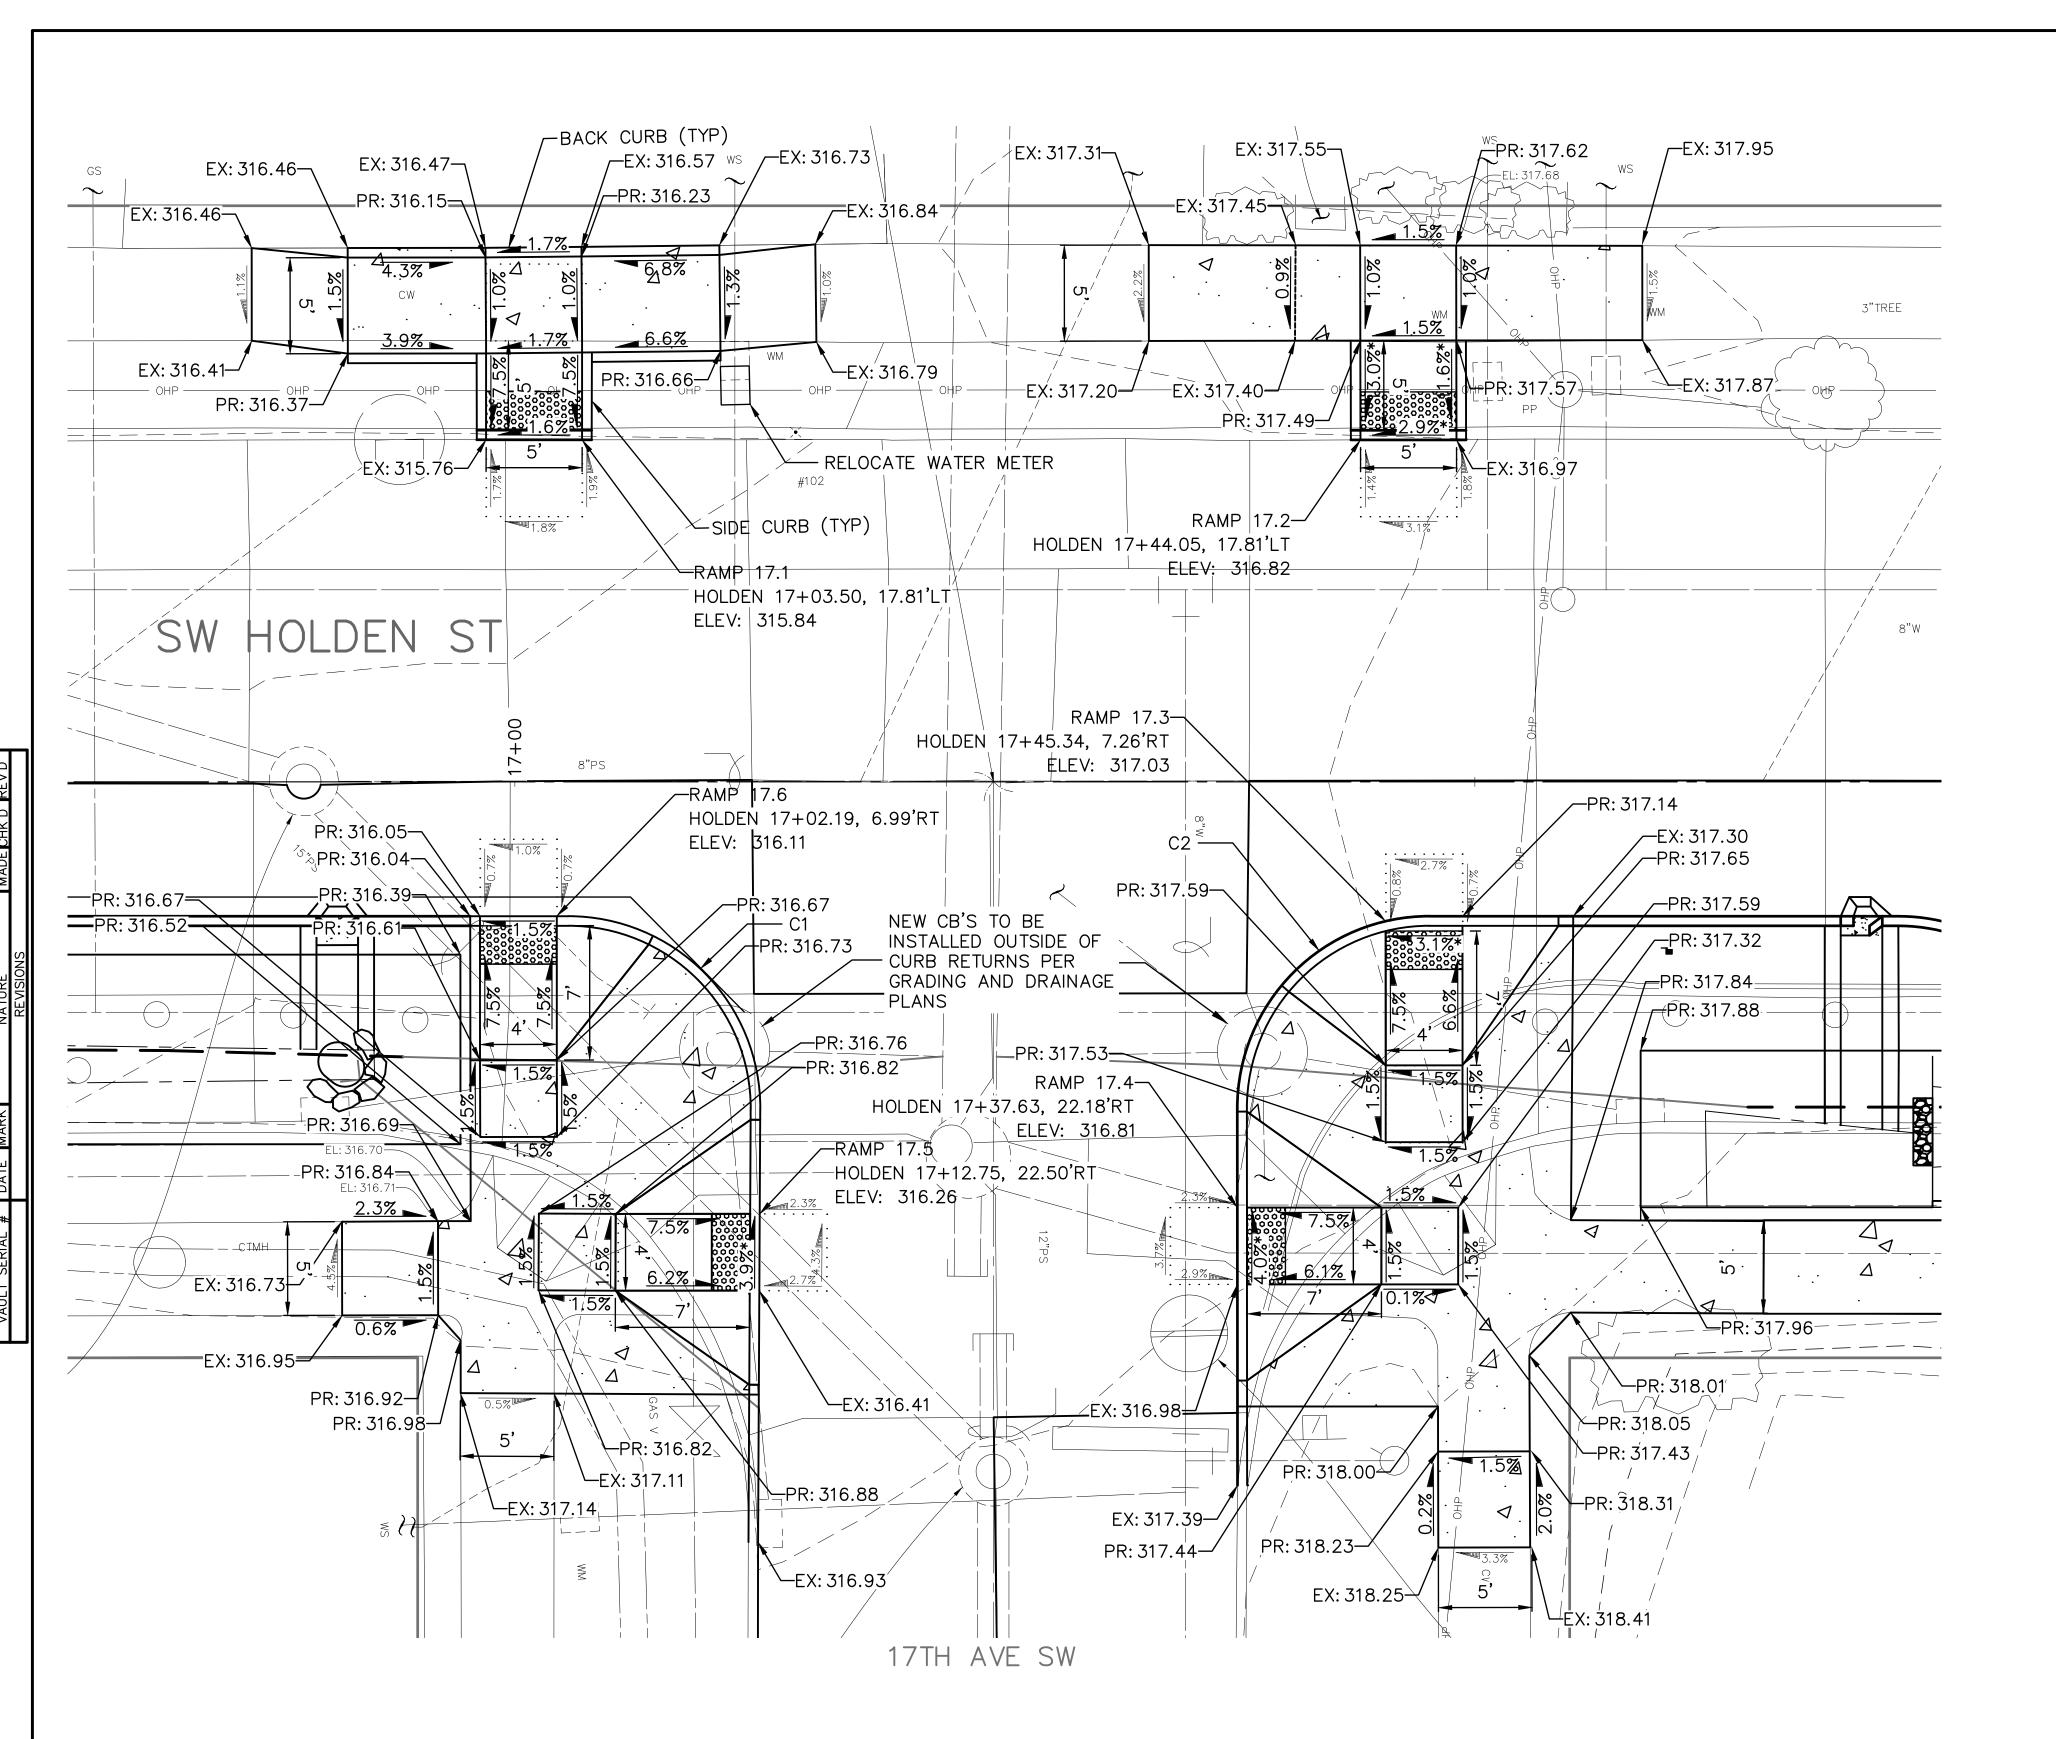





MEF CODES

- *1. RIGHT-OF-WAY AVAILABILITY
- *2 ROADWAY STRUCTURAL CONSTRAINT; WALL, AREAWAY, OR BRIDGE
- *3 ADJACENT DEVELOPED FACILITY
- DRAINAGE
- *5 HISTORIC FEATURE
- *6 EXISTING ROAD/SIDEWALK SLOPES *7 EXISTING UTILITY VAULT OR UTILITY
- STRUCTURE

3 (OTHER), DESCRIBE, ADD ANNOTAI	ION
----------------------------------	-----

LEGEND

—	_	_	_	_	—	_	_	GRADE	BREA
								LANDIN	G

RAMP	STD	MEF
CODE	PLAN	CODE
17.1	422a	*6
17.2	422a	*6
17.3	422d	*6
17.4	422d	*6
17.5	422d	*6
17.6	422d	

RAMP NOTES

- 1. ALL UPPER LANDINGS ARE 4'X4' AND </= 2% IN ANY DIRECTION AND MATCH EXISTING
- GRADE, UNLESS OTHERWISE NOTED.

 2. ALL WINGS ARE 10:1 SLOPE OR LESS UNLESS OTHERWISE NOTED.
- 3. ALL RAMP SLOPES ARE </= 8.3% AND </= 15' LONG UNLESS OTHERWISE NOTED.

CURB RETURN TABLE

CURB RETURN NO.	POINT	STATION	OFFSET	ELEVATION AT FLOW- LINE	CURVE GEOMETRY
C1	RADIUS POINT	STA 17+02.78	17.00' RT	N/A	
	PC	STA 17+02.19	06.99' RT	316.12'	
	1/4	STA 17+06.72	07.80' RT	316.18'	$\Delta = 89.28$ R = 10.00
	1/2	STA 17+09.92	09.99' RT	316.21'	T = 09.89 L = 15.61
	3/4	STA 17+12.04	13.23' RT	316.22'	
	PT	STA 17+12.78	17.05' RT	316.21'	

CURB RETURN TABLE

CURB RETURN NO.	POINT	STATION	OFFSET	ELEVATION AT FLOW— LINE	CURVE GEOMETRY
	RADIUS POINT	STA 17+47.64	17.01' RT	N/A	
	PC	STA 17+37.63	17.01' RT	316.67'	
C2	1/4	STA 17+38.40	13.14' RT	316.75	$\Delta = 90.70$ R = 10.00
OZ.	1/2	STA 17+40.60	09.88' RT	316.87	T = 10.14 L = 15.858
	3/4	STA 17+43.90	07.72' RT	316.98'	
	PT	STA 17+47.63	07.00' RT	317.10'	

60% SIP RESUBMITTAL



APPROVED FOR ADVERTISING LIZ ALZEER DEPARTMENT OF FINANCE & ADMINISTRATIVE SERVICES SEATTLE, WASHINGTON 20 PURCHASING AND CONTRACTING DIRECTOR


DESIGNED CHECKED PROJ. MGR. CHECKED REVISED AS BUILT

ADA RAMP/INTERSECTION PLAN - SW HOLDEN ST/17TH AVE SW Seattle Public Utilities

ORDINANCE NO.

HOLDEN NDS

CP401 SHEET 29 OF 36

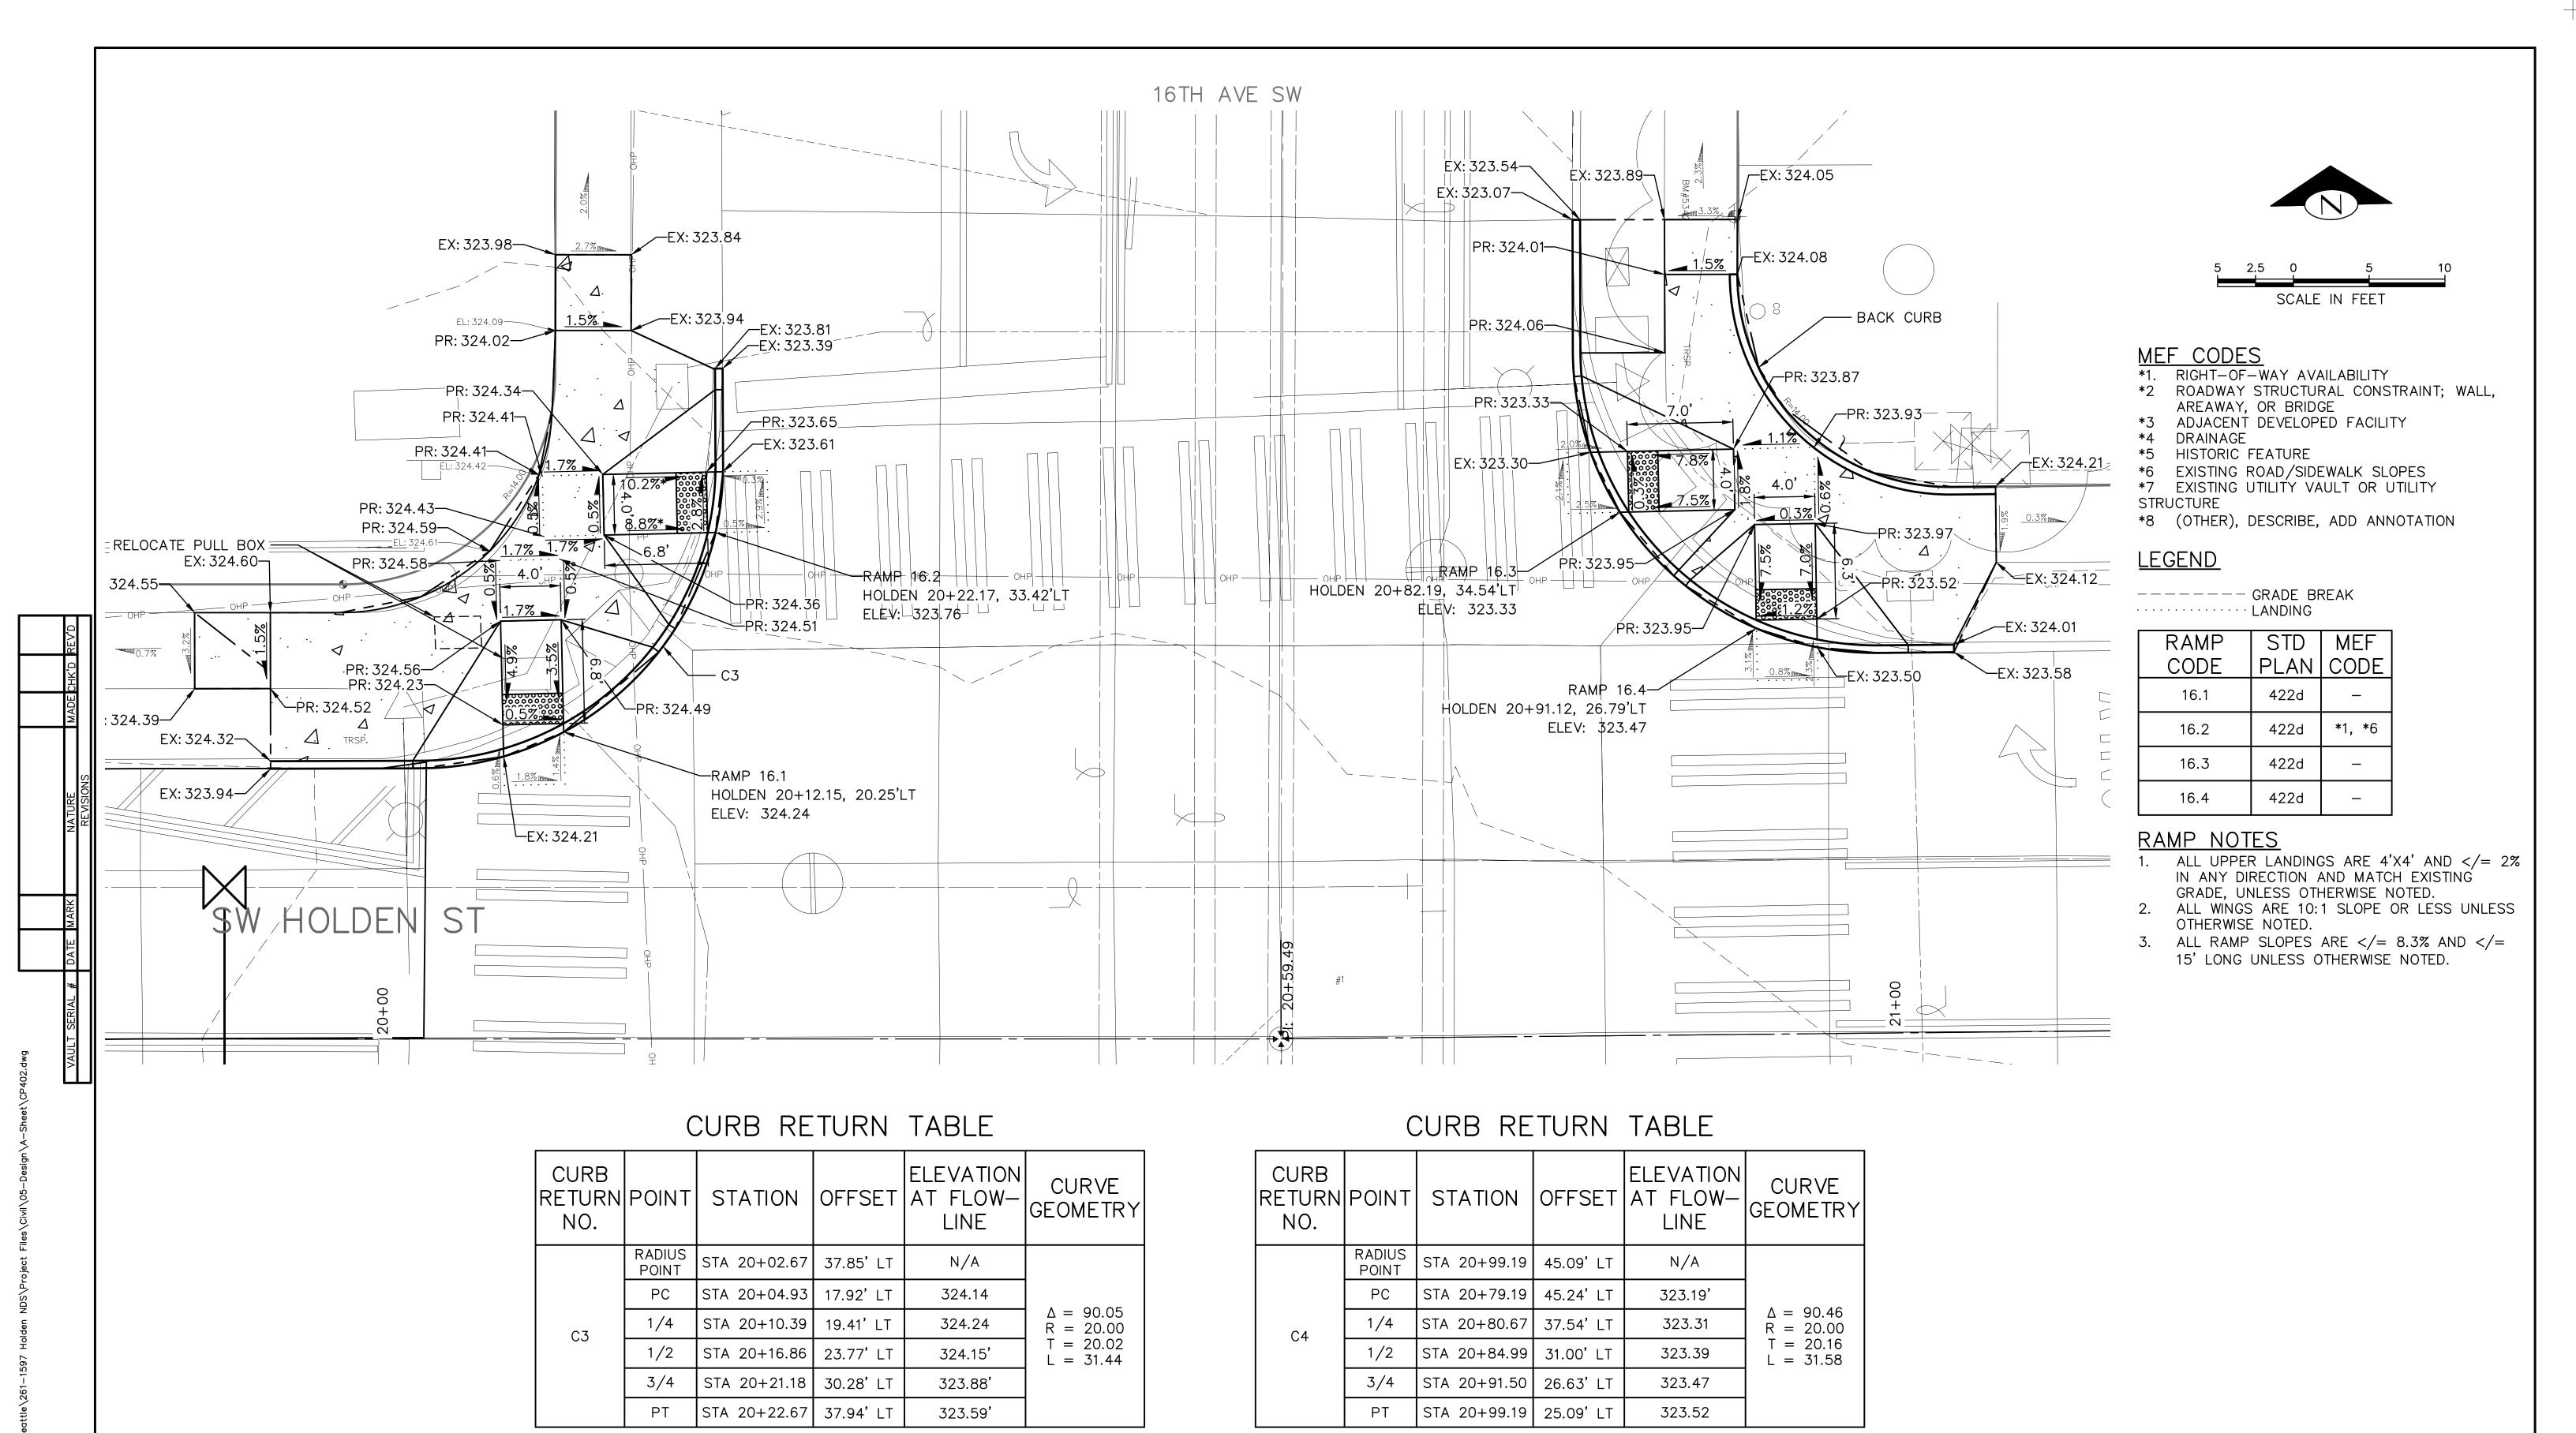

60% SUBMITTAL (NOT FOR CONSTRUCTION)

ADA RAMP/INTERSECTION PLAN - SW HOLDENST/16TH AVE SW (1 OF 2)



	INITIALS AND DATE	INITIALS AND DATE			
	DESIGNED CHECKED	REVIEWED: DES. CONST. SDOT PROJ. MGR.			
•	DRAWN	RECEIVED			
	CHECKED	REVISED AS BUILT			
	ALL WORK SHALL BE DONE IN ACCORDANCE WITH THE CITY OF SEATTLE STANDARD PLANS AND SPECIFICATIONS AND OTHER DOCUMENTS CALLED FOR IN SECTION 0-02.3 OF THE PROJECT MANUAL.				



Seattle Public Utilities

ORDINANCE NO. PW NO.


HOLDEN NDS

PC C600855 co

VPI #

CP402

SHEET 30 OF 36

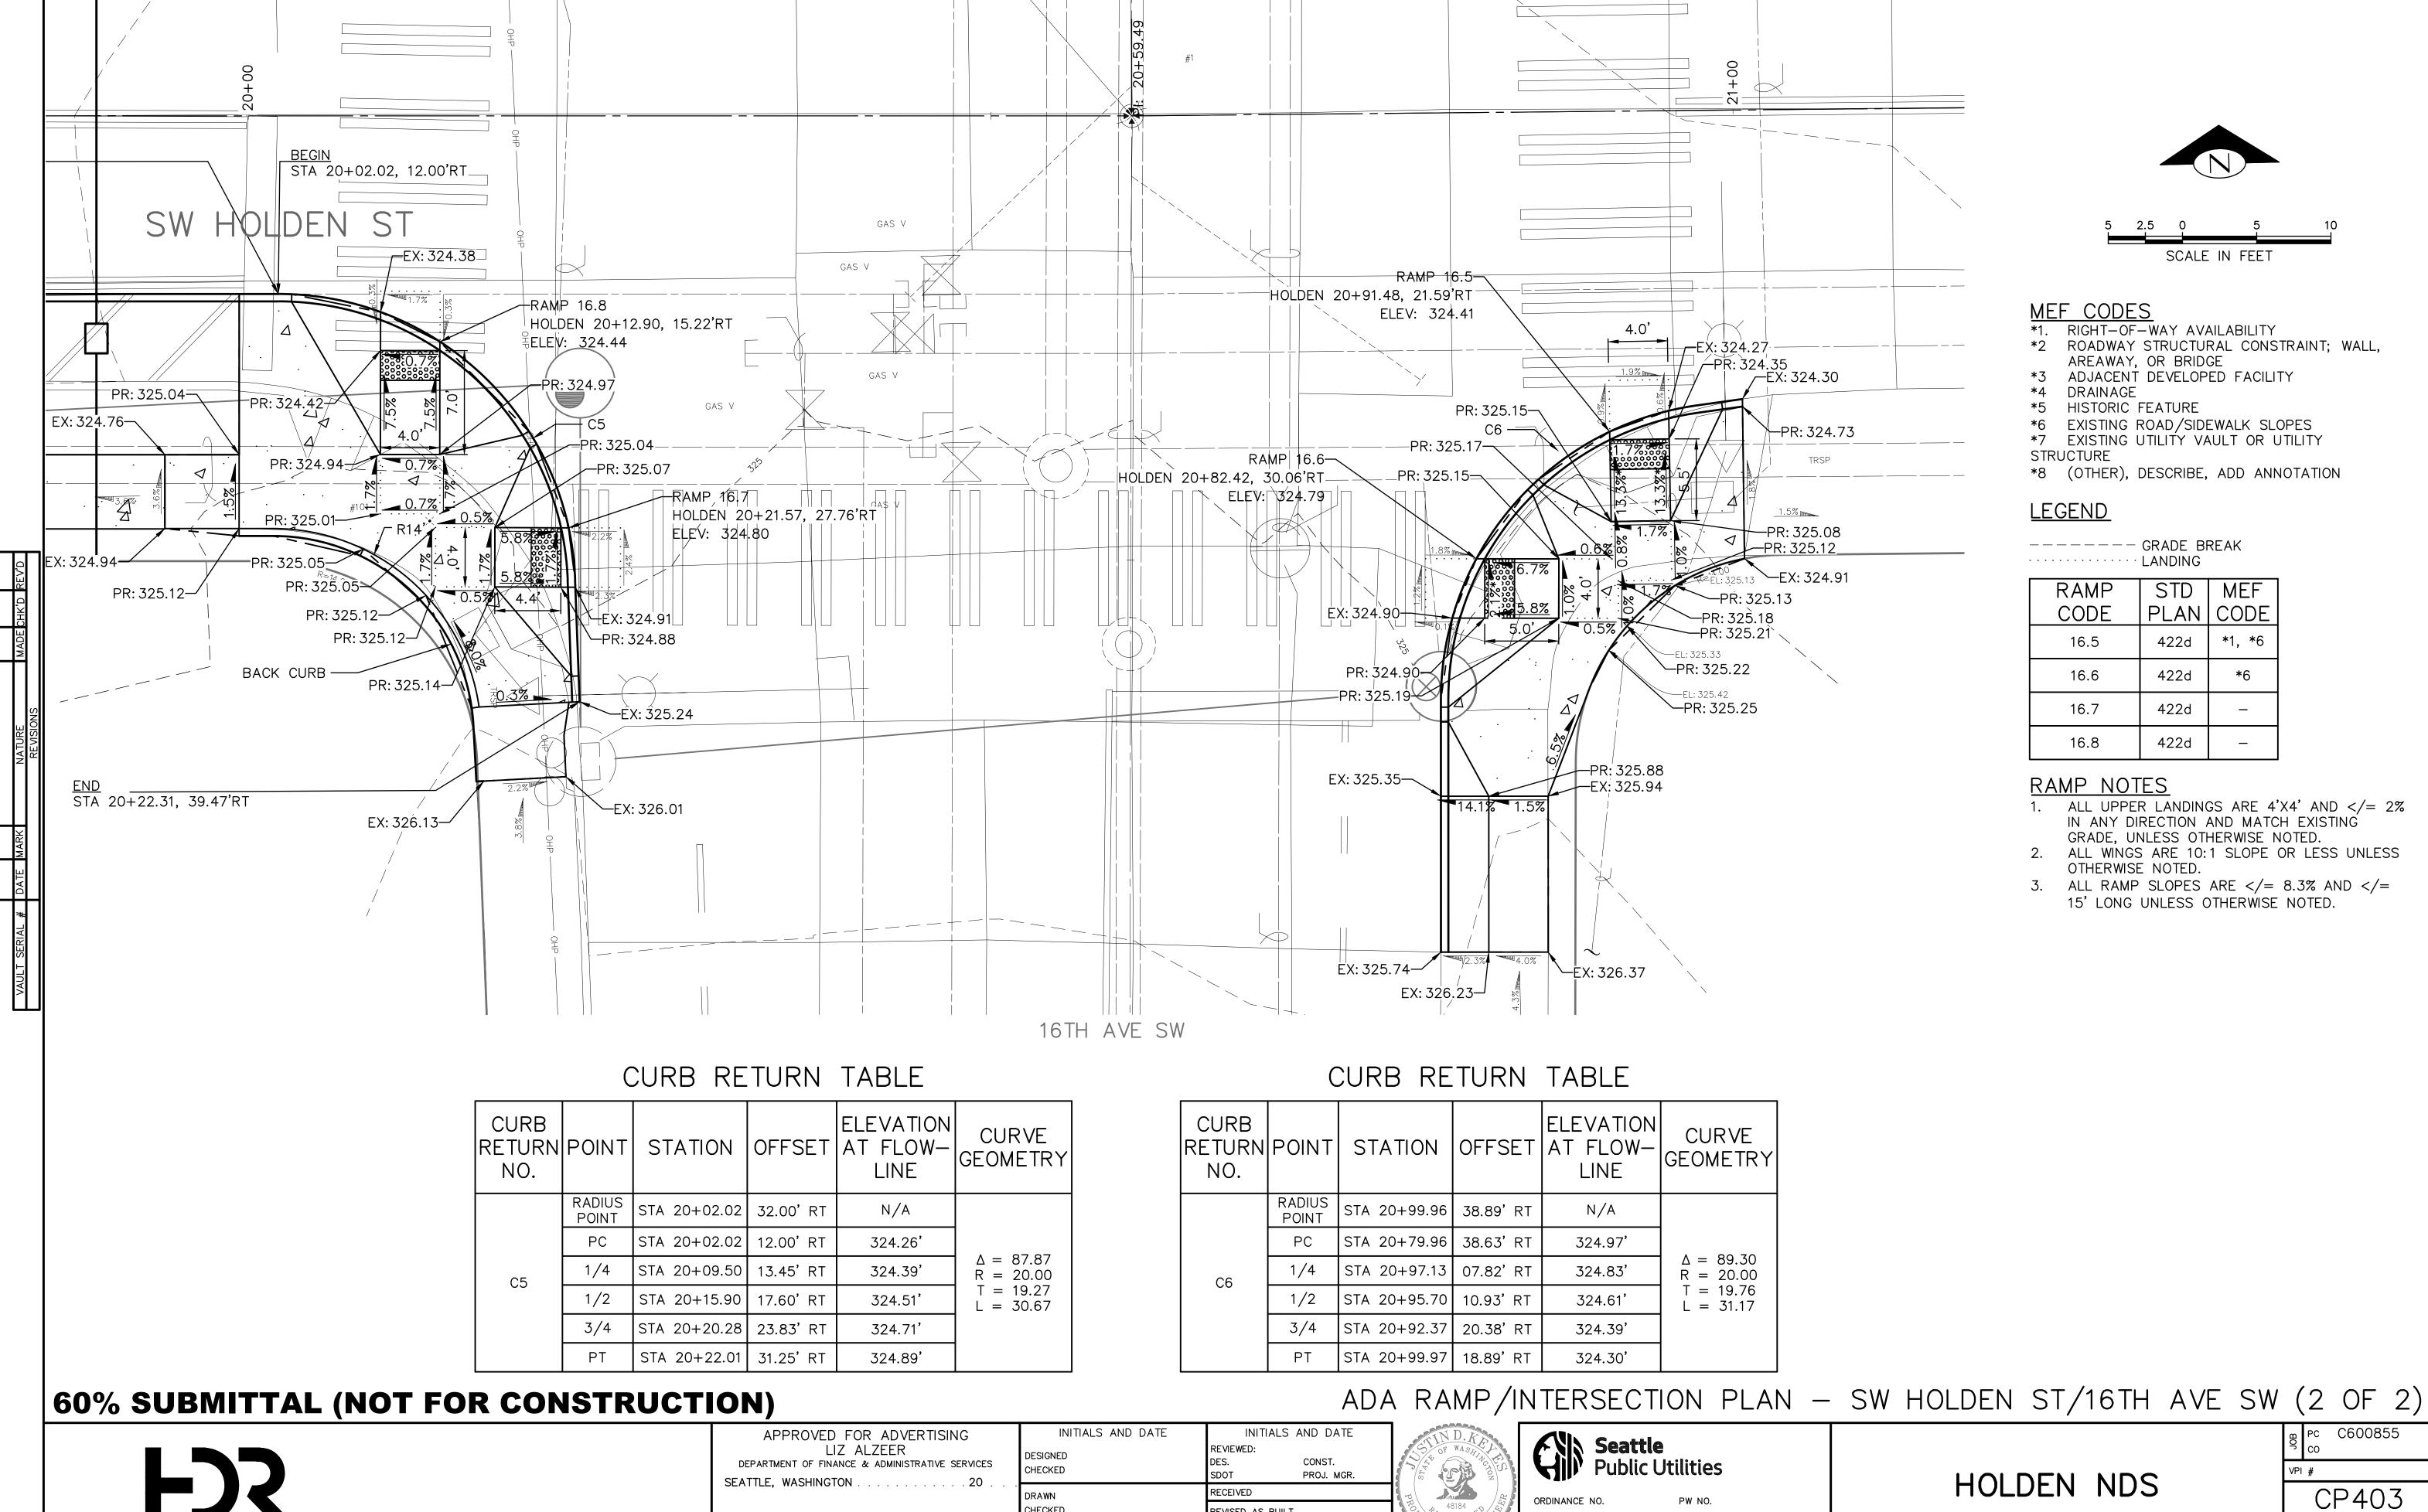

REVISED AS BUILT

SCALE: 1"=5'

CHECKED

PURCHASING AND CONTRACTING DIRECTOR

SHEET 31 OF 36

GERANIUM MACRORRHIZUM / HARDY GERANIUM

ALLIUM CERNUUM / NODDING PINK ONION

CAMASSIA QUAMASH / COMMON CAMAS

LANDSCAPE RESTORATION

SEEDED LAWN

HELIANTHEMUM 'HENFIELD BRILLIANT' / SUN ROSE


LANDSCAPE NOTES

- 1. BRING ANY DISCREPANCIES WITH THE DWGS AND/OR SPECS & SITE CONDITIONS TO THE ATTENTION OF ENG PRIOR TO PROCEEDING WITH CONSTRUCTION.
- 2. LOCATE UTILITIES PRIOR TO BEGINNING CONSTRUCTION.
- 3. VERIFY ALL GRADES WITH THE ENG BEFORE COMMENCEMENT OF PLANTING & SEEDING:
- a. ALL GRADES SHALL FLOW SMOOTHLY INTO ONE ANOTHER WITH NO ABRUPT TRANSITIONS AND PRODUCE POSITIVE STORMWATER DRAINAGE.
- b. THE CONTRACTOR IS RESPONSIBLE FOR ANY ADVERSE DRAINAGE CONDITIONS THAT MAY AFFECT PLANT GROWTH UNLESS THE CONTRACOR CONTACTS THE ENG IMMEDIATELY, INDICATING ANY POSSIBLE PROBLEM.
- 4. FIELD STAKE OR DEMARCATE PLANTING LOCATIONS FOR ENG REVIEW AND APPROVAL PRIOR TO INSTALLATION.
- 5. ENSURE SEED LAWN AND PLANT MATERIAL RECEIVE ADEQUATE WATER THROUGHOUT ONE (1) YEAR GUARANTEE PERIOD FOR PLANT ESTABLISHMENT, SEE SPECS.
- 6. INSTALL GROUNDCOVERS IN A TRIANGULAR PATTERN AT SPACING SHOWN IN THE PLANT SCHEDULE. WHERE GROUNDCOVER ABUTS CURBING, WALLS, OR WALKS, MIN PLANTING DISTANCE MUST BE NINE (9) INCHES FROM SAME UNLESS OTHERWISE NOTED.

LANDSCAPE ABBREVIATIONS

#/NO. NUMBER % PERCENT & AND @ AT ABBV ABBREVIATIONS ALT ALTERNATE APPROX APPROXIMATE B&B BALLED AND BURLAPPED CAL CALIPER Q/CL CENTER LINE CLR CLEAR CONC CONCRETE	EA EQ EX HT MAX MIN OC PREP QTY SCH SPEC SQ SF	EACH EQUAL EXISTING HEIGHT MAXIMUM MINIMUM ON CENTER PREPARATION QUANTITY SCHEDULE SPECIFICATION SQUARE SQUARE SQUARE
CLR CLEAR CONC CONCRETE	SPEC SQ	SPECIFICATION SQUARE
CONST CONSTRUCTION CONT CONTAINER DIA DIAMETER DWGS DRAWINGS	SYM TYP ENG	SYMBOL TYPICAL ENGINEER


_ANDSCAPE LEGEND

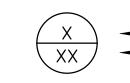

- DETAIL REFERENCE NUMBER - SHEET ON WHICH DETAIL APPEARS



TREE PROTECTION FENCING

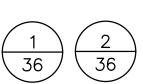

EXISTING TREES TO REMAIN

60% SUBMITTAL

HBB LANDSCAPE ARCHITECTURE

10%

35

APPROVED FOR ADVERTISING LIZ ALZEER DEPARTMENT OF FINANCE & ADMINISTRATIVE SERVICES SEATTLE, WASHINGTON 20

PURCHASING AND CONTRACTING DIRECTOR

#1 CONT

#1 CONT

#1 CONT

BULB; 5+ CENTIMETERS TOP GRADE

SEE SPECS

DESIGNED SN 08/03/23 PROJ. MGR. 08/03/23 08/03/23 CHECKED AL REVISED AS BUILT

ORDINANCE NO.



HOLDEN NDS

LANDSCAPE SCHEDULE, LEGEND, NOTES & ABBVS


792-752

SHEET 32 of 36


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-001

LANDSCAPE LEGEND

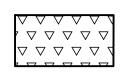

BIORETENTION PLANTING, SEE SHEET 32 (L-001) FOR LANDSCAPE SCHEDULE

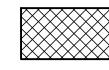

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11. 11.14 11. 11.14 .


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(L-001) FOR LANDSCAPE SCHEDULE

LANDSCAPE PLANTING, SEE SHEET 32

RESTORATION PLANTING, SEE SHEET 32 (L-001) FOR LANDSCAPE SCHEDULE


TREE PROTECTION FENCING

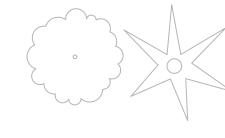


EXISTING TREES TO REMAIN

NOTES

- 1. DO NO HARM TO BIORETENTION LINER DURING PLANT INSTALLATION. SEE CIVIL DRAWINGS FOR BIORETENTION LINER LOCATION.
- 2. PLANT INSTALLATION IN BIORETENTION CELLS TO BE DONE USING HAND TOOLS ONLY. USE OF AUGERS OF ANY KIND IS NOT PERMITTED.
- 3. SEE CIVIL DRAWINGS FOR MULCH TREATMENT IN BIORETENTION CELLS.
- 4. NO ADDITIONAL SOIL PREPARATION BEYOND WHAT IS DEFINED IN CIVIL DRAWINGS IS REQUIRED WITHIN BIORETENTION CELLS.
- 5. SEE CIVIL DRAWINGS FOR LIMITS OF CONCRETE PAVING.
- 6. SEE SHEET 32 FOR ADDITIONAL LANDSCAPE NOTES.

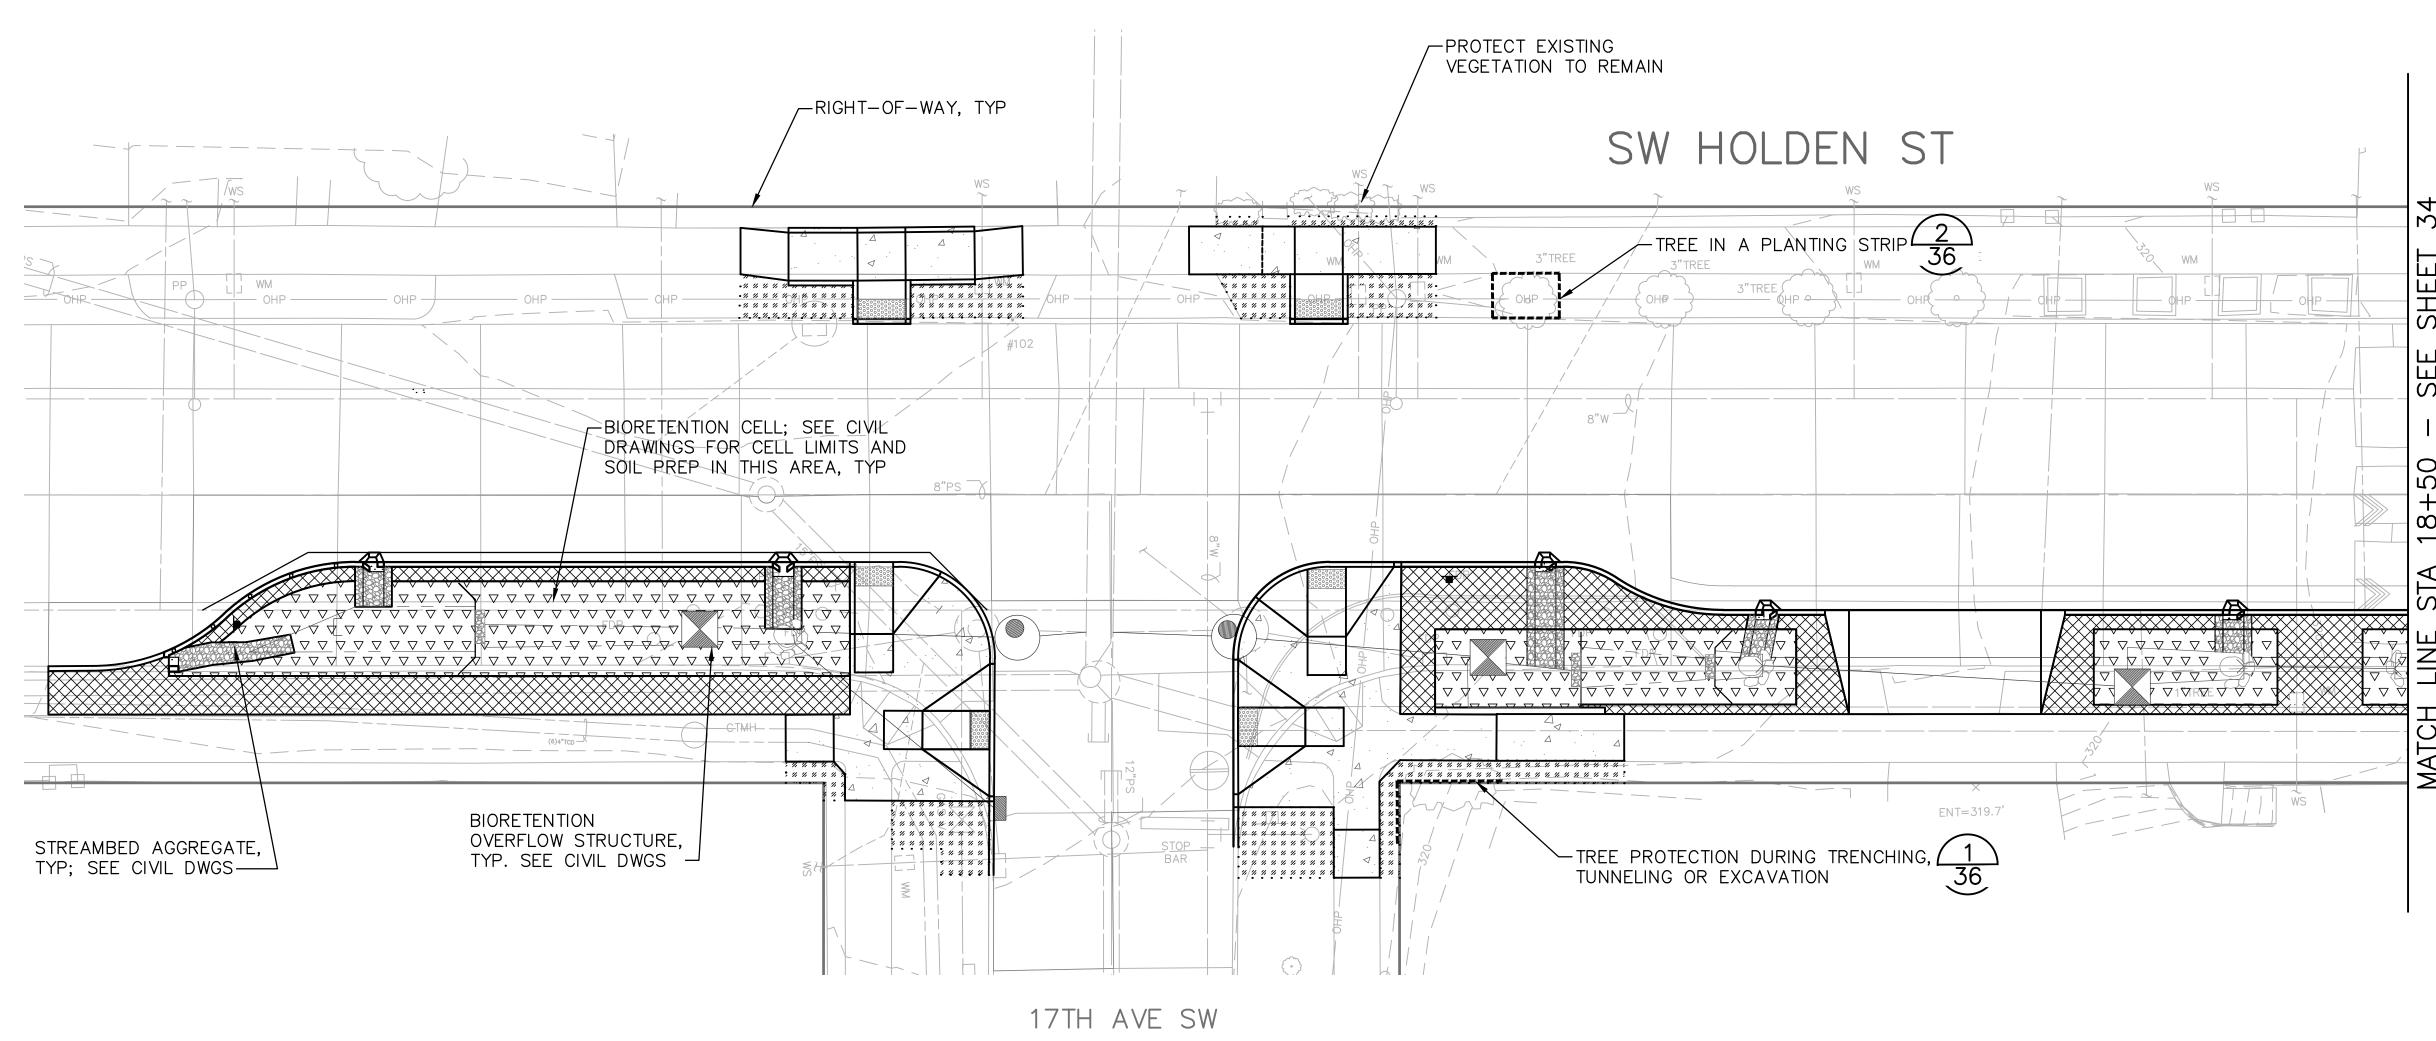

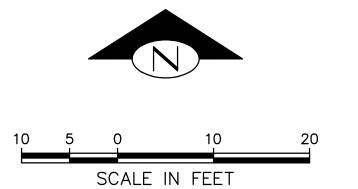

60% SUBMITTAL

LANDSCAPE PLAN - SW HOLDEN ST (1 OF 2)



PURCHASING AND CONTRACTING DIRECTOR

IN	ITIALS	AND DATE	INITIALS	AND DATE	
DESIGNED CHECKED		08/03/23 08/03/23	REVIEWED: DES. SDOT	CONST. PROJ. MGR.	
DRAWN	JR	08/03/23	RECEIVED		[]
CHECKED	AL	08/03/23	REVISED AS BUILT	ī	١ ١
ALL WORK SHALL BE DONE IN ACCORDANCE WITH THE CITY OF SEATTLE STANDARD PLANS AND SPECIFICATIONS AND OTHER DOCUMENTS CALLED FOR IN SECTION 0-02.3 OF THE PROJECT MANUAL.					





HOLDEN NDS

PC C600855


VPI # 792-752

L-101


SHEET 33 OF 36

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BIORETENTION PLANTING, SEE SHEET 20 (L-001) FOR LANDSCAPE SCHEDULE

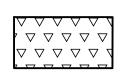

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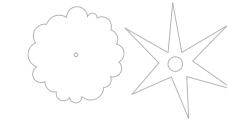
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(L-001) FOR LANDSCAPE SCHEDULE

LANDSCAPE PLANTING, SEE SHEET 20

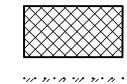RESTORATION PLANTING, SEE SHEET 20 (L-001) FOR LANDSCAPE SCHEDULE


TREE PROTECTION FENCING




EXISTING TREES TO REMAIN

NOTES

- 1. DO NO HARM TO BIORETENTION LINER DURING PLANT INSTALLATION. SEE CIVIL DRAWINGS FOR BIORETENTION LINER LOCATION.
- 2. PLANT INSTALLATION IN BIORETENTION CELLS TO BE DONE USING HAND TOOLS ONLY. USE OF AUGERS OF ANY KIND IS NOT PERMITTED.
- 3. SEE CIVIL DRAWINGS FOR MULCH TREATMENT IN BIORETENTION CELLS.
- 4. NO ADDITIONAL SOIL PREPARATION BEYOND WHAT IS DEFINED IN CIVIL DRAWINGS IS REQUIRED WITHIN BIORETENTION CELLS.
- 5. SEE CIVIL DRAWINGS FOR LIMITS OF CONCRETE PAVING.
- 6. SEE SHEET 20 FOR ADDITIONAL LANDSCAPE NOTES.

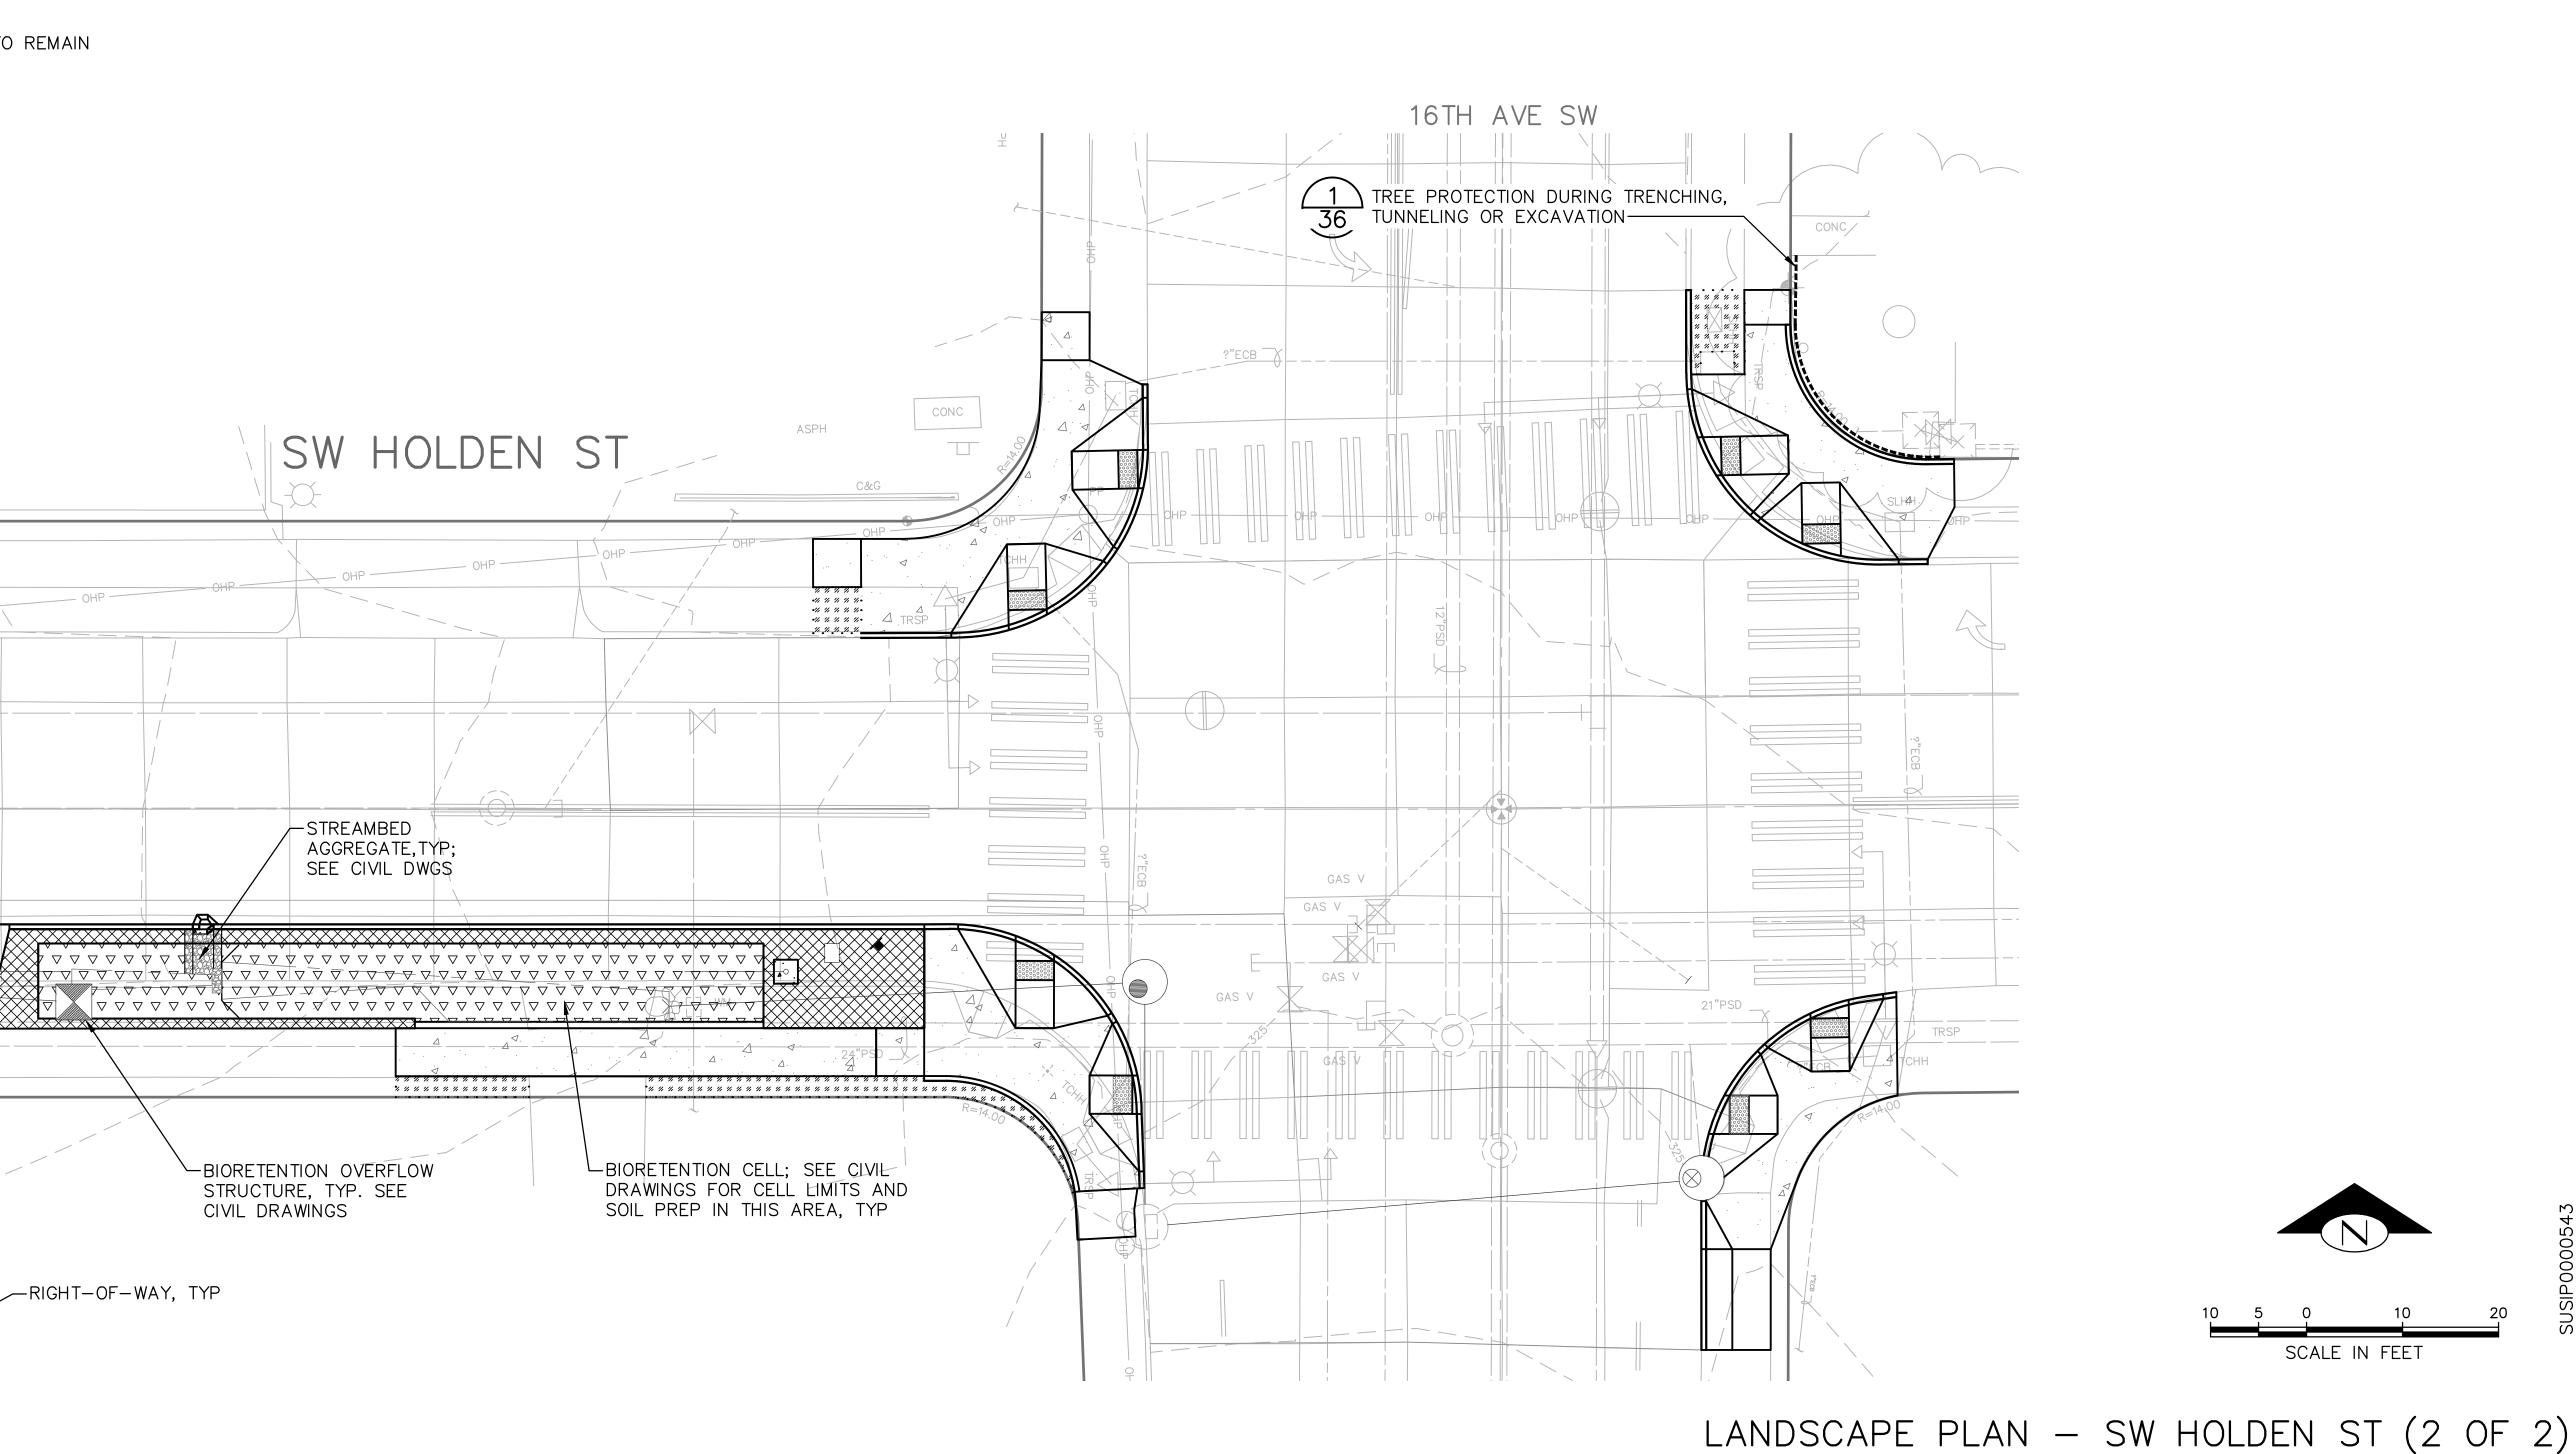

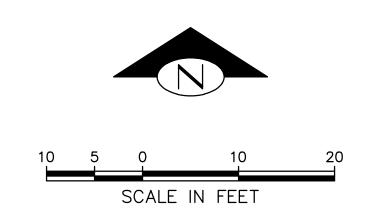

60% SUBMITTAL

HBB

LANDSCAPE ARCHITECTURE

APPROVED FOR ADVERTISING LIZ ALZEER DEPARTMENT OF FINANCE & ADMINISTRATIVE SERVICES SEATTLE, WASHINGTON 20

INITIALS AND DATE DESIGNED SN CONST. 08/03/23 CHECKED AL PROJ. MGR. 08/03/23 08/03/23 CHECKED AL REVISED AS BUILT






ORDINANCE NO.

HOLDEN NDS

VPI # 792-752

L-102 SHEET 34 OF 36

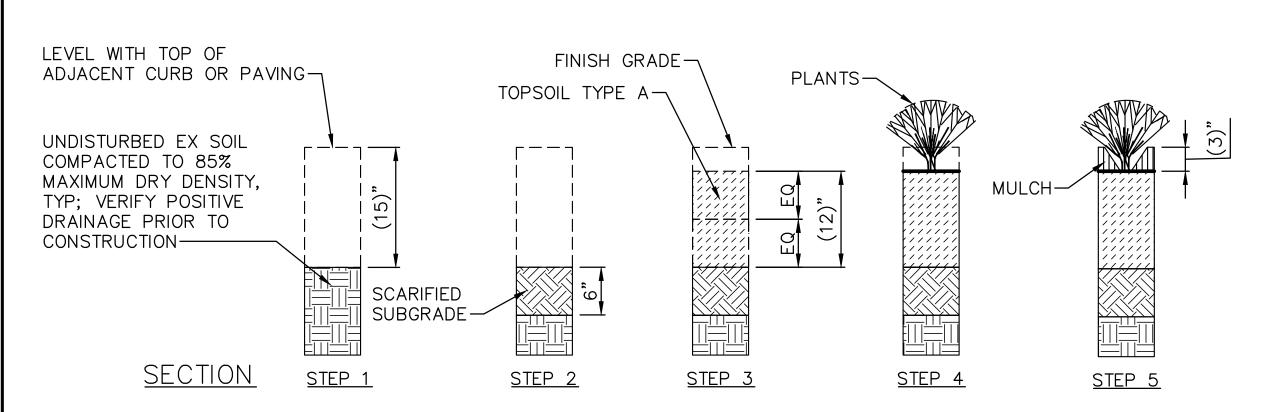

EXCAVATE EX SOIL TO DEPTH SHOWN, BELOW ADJACENT CURB OR PAVING. SHOWN. ENGINEER SHALL AVOID UNDERMINING

THOROUGHLY SCARIFY SUBGRADE TO DEPTH REVIEW & APPROVE WORK ADJACENT CURB OR PAVING. PRIOR TO PROCEEDING TO STEP 3.


INSTALL TOPSOIL TYPE A TO INSTALL PLANTS. DEPTH SHOWN. INSTALL IN EQ LIFTS. COMPACT EACH LIFT PRIOR TO INSTALLING


THE NEXT LIFT. REVIEW FINISH GRADE WITH ENG PRIOR TO PLANT INSTALLATION.


STEP 5 INSTALL MULCH TO DEPTH SHOWN. INSTALL TOP OF MULCH FLUSH WITH TOP OF ADJACENT CURB OR PAVING.

1. ALL DIMENSIONS INDICATE COMPACTED DEPTHS.

SOIL PREPARATION IN LANDSCAPE PLANTING AREAS

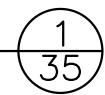

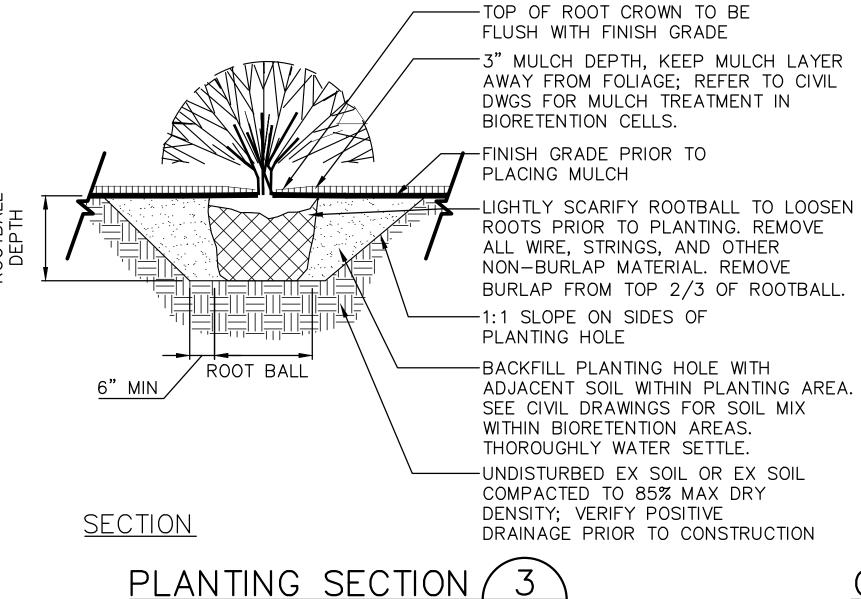

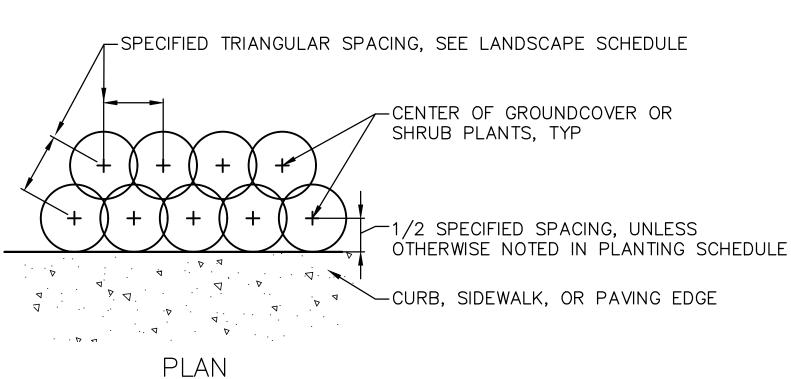

GROUNDCOVER & SHRUB PLANTING LAYOUT

60% SUBMITTAL

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SCALE: NTS

LIZ ALZEER SEATTLE, WASHINGTON 20

INITIALS AND DATE INITIALS AND DATE REVIEWED: DESIGNED SN 08/03/23 CONST. 08/03/23 CHECKED AL PROJ. MGR. 08/03/23 08/03/23 CHECKED AL REVISED AS BUILT PURCHASING AND CONTRACTING DIRECTOR ALL WORK SHALL BE DONE IN ACCORDANCE WITH THE CITY OF SEATTLE STANDARD PLANS AND








HOLDEN NDS

C600855 792-752 -201

FINISH GRADE TO BE 1/2" BELOW TOPSOIL TYPE A-LAWN SEED-ADJACENT CURB OR PAVING-FINISH GRADE UNDISTURBED EX SOIL OR FILL COMPACTED TO 85% MAXIMUM DRY DENSITY, TYP; SCARIFIED VERIFY POSITIVE DRAINAGE SUBGRADE PRIOR TO CONSTRUCTION-**SECTION** STEP 1 STEP 4 STEP 3 STEP 2 INSTALL TOPSOIL TYPE A TO DEPTH EXCAVATE EX SOIL TO DEPTH SHOWN BELOW ADJACENT CURB OR PAVING. AVOID SHOWN. WATER SETTLE/COMPACT PRIOR UNDERMINING ADJACENT CURB OR PAVING TO INSTALLING LAWN SEED. REVIEW FINISH SUBBASE MATERIAL. GRADE WITH ENGINEER PRIOR TO SEEDING

> SCARIFY SUBGRADE TO DEPTH SHOWN. INSTALL LAWN SEED. ENGINEER SHALL REVIEW & APPROVE WORK PRIOR TO PROCEEDING TO STEP 3. 1. ALL DIMENSIONS INDICATE

SEEDED LAWN SOIL PREPARATION

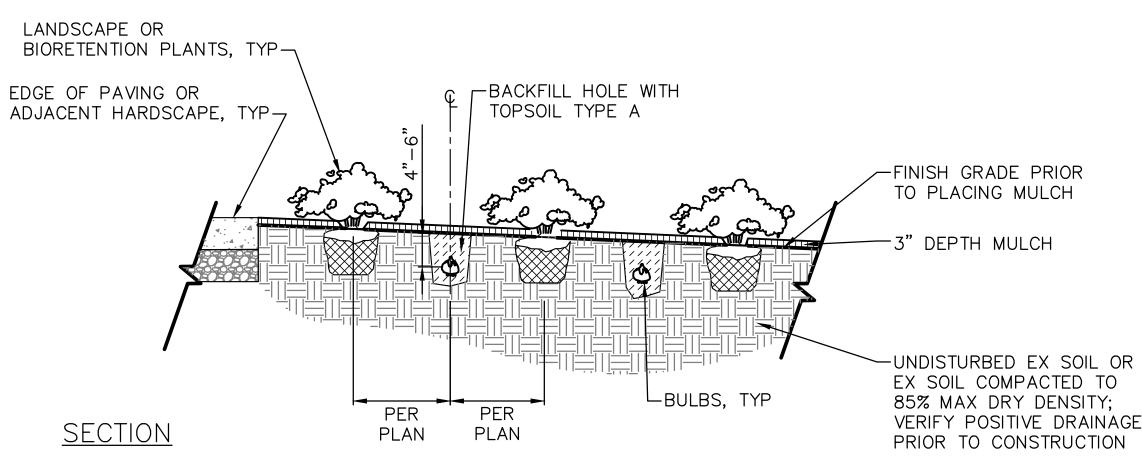

COMPACTED DEPTHS.

NOTES:

1. INSTALL 5 BULBS PER HOLE, SPACED 4"-6" APART.

2. INSTALL BULBS 4"-6" DEEP.

3. PLANT BULBS WITH THE TOP (POINTED END) UP.

4. VERIFY LAYOUT OF BULBS WITH ENG PRIOR TO PLANTING.

5. PLANT BULBS FROM SEPTEMBER TO NOVEMBER ONLY.


BULB PLANTING / SCALE: NTS

LANDSCAPE DETAILS (1 OF 2)

SHEET 35 OF 36

APPROVED FOR ADVERTISING DEPARTMENT OF FINANCE & ADMINISTRATIVE SERVICES

SCALE: AS NOTED

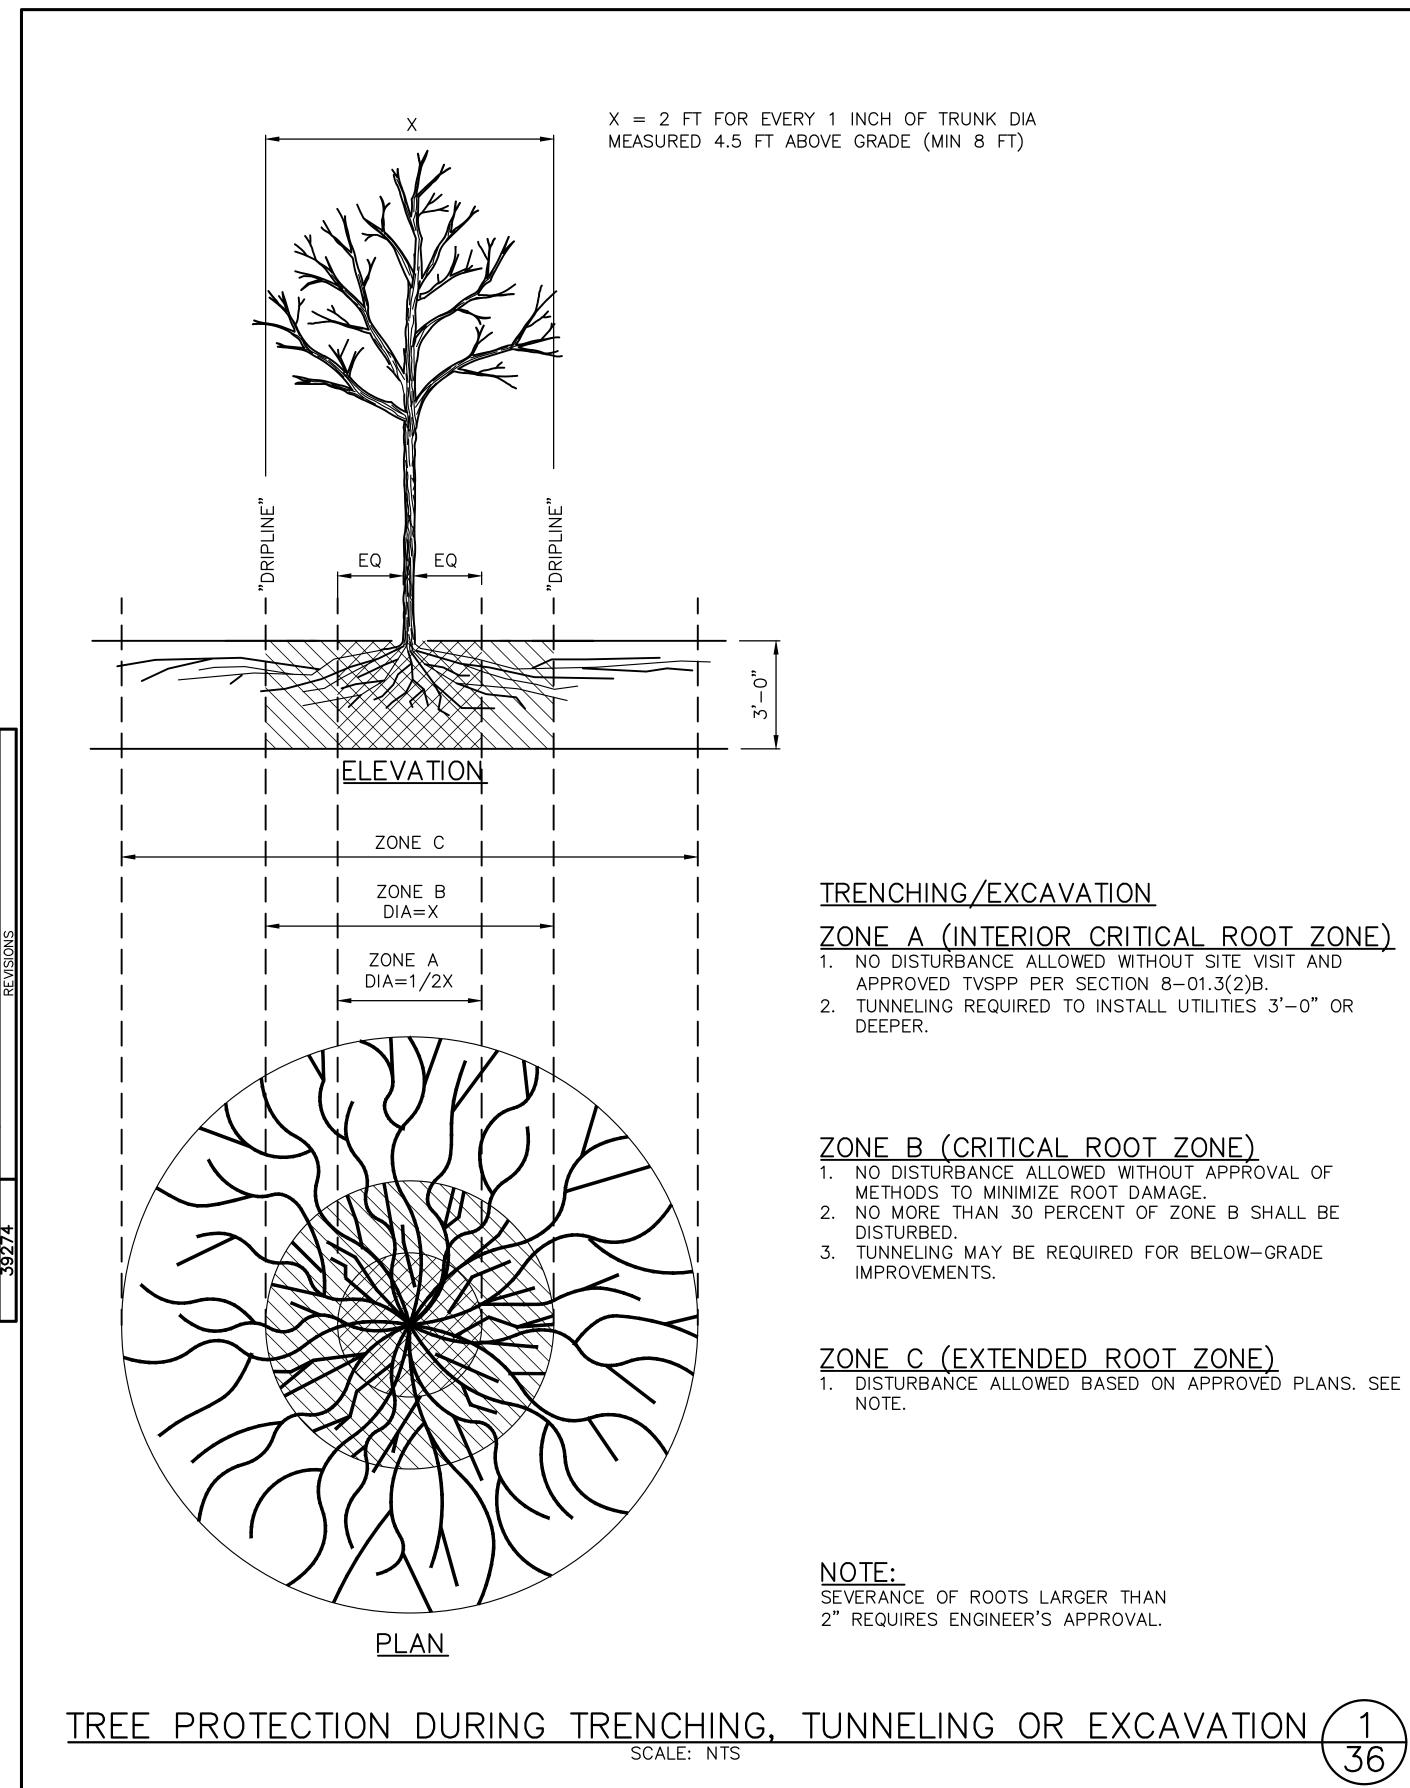

-4'-6" TO 6'-0" HIGH CHAIN LINK FENCE TO ENCLOSE PROTECT PLANTING STRIP PER STD SPEC 8-01.3(2)B IN AREAS USED FOR TEMPORARY ACCESS

OR STORAGE HARDSCAPE EDGES AND ZONE B (SEE STD PLAN NO 133) —SIDEWALK EDGE PLANTING STRIP FACE OF CURB-<u>PLAN</u>

✓ZONE B (SEE STD PLAN NO 133)

NOTE:

CONSIDER TRAFFIC TURNING VISIBILITY AND PEDESTRIAN VISIBILITY WHEN SELECTING FENCE HEIGHT;
TYPICALLY SHORTER FENCING
AROUND TREE PITS BETWEEN

SIDEWALK AND ROADWAY IS DESIRED.

TREE IN A PLANTING STRIP (2)

60% SUBMITTAL

HBB LANDSCAPE ARCHITECTURE

APPROVED FOR ADVERTISING LIZ ALZEER DEPARTMENT OF FINANCE & ADMINISTRATIVE SERVICES SEATTLE, WASHINGTON 20

INITIALS AND DATE DESIGNED SN 08/03/23 08/03/23 CHECKED AL 08/03/23 08/03/23 CHECKED AL ALL WORK SHALL BE DONE IN ACCORDANCE WITH THE CITY OF SEATTLE STANDARD PLANS AND SPECIFICATIONS AND OTHER DOCUMENTS CALLED FOR IN SECTION 0-02.3 OF THE PROJECT MANUA



INITIALS AND DATE

CONST.

PROJ. MGR.

REVIEWED:

REVISED AS BUILT



ORDINANCE NO.

SCALE: AS NOTED

HOLDEN NDS

LANDSCAPE DETAILS (2 OF 2)

VPI # 792-752 L-202

SHEET 36 OF 36