


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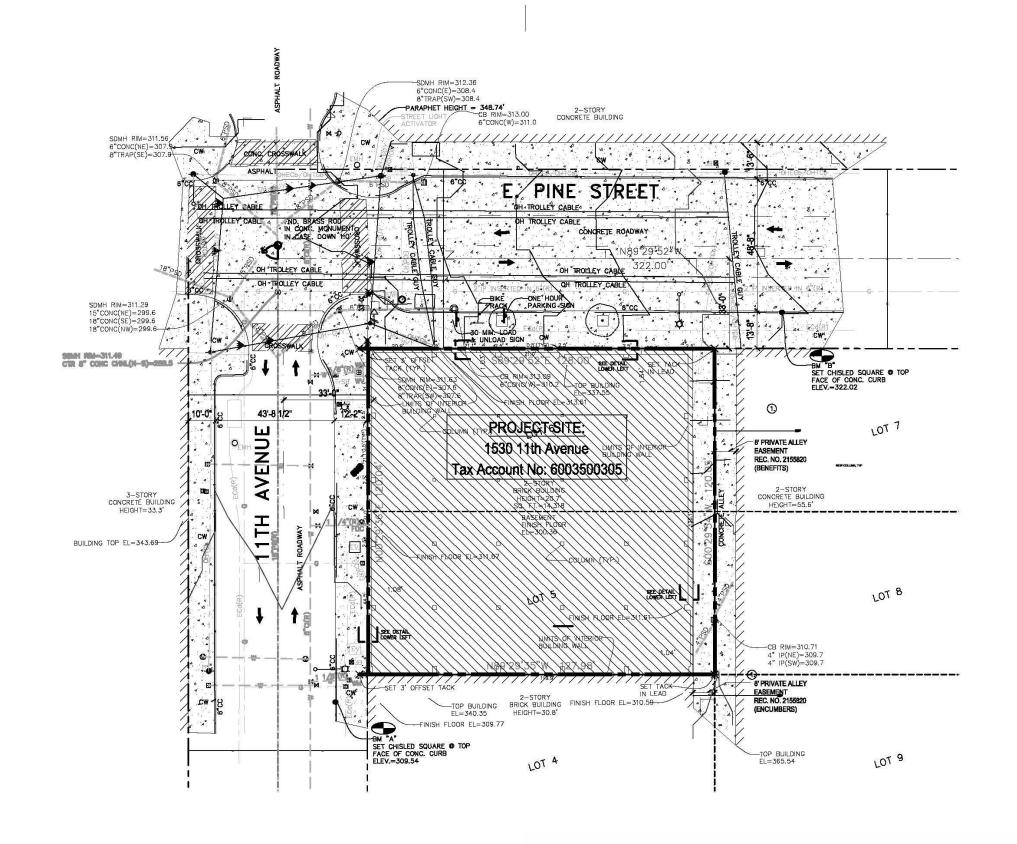
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COVER SHEET SHEET TITLE

ELEVENTH & E. PINE (Sunset Electric)

SHEET NUMBER

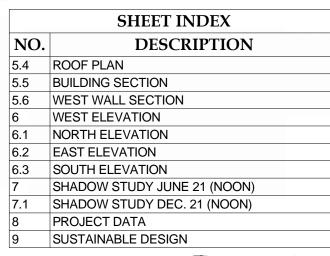






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EXISTING SITE PLAN (SURVEY) SHEET TITLE

ELEVENTH & E. PINE (Sunset Electric) DPD PROJECT NO: 3010451

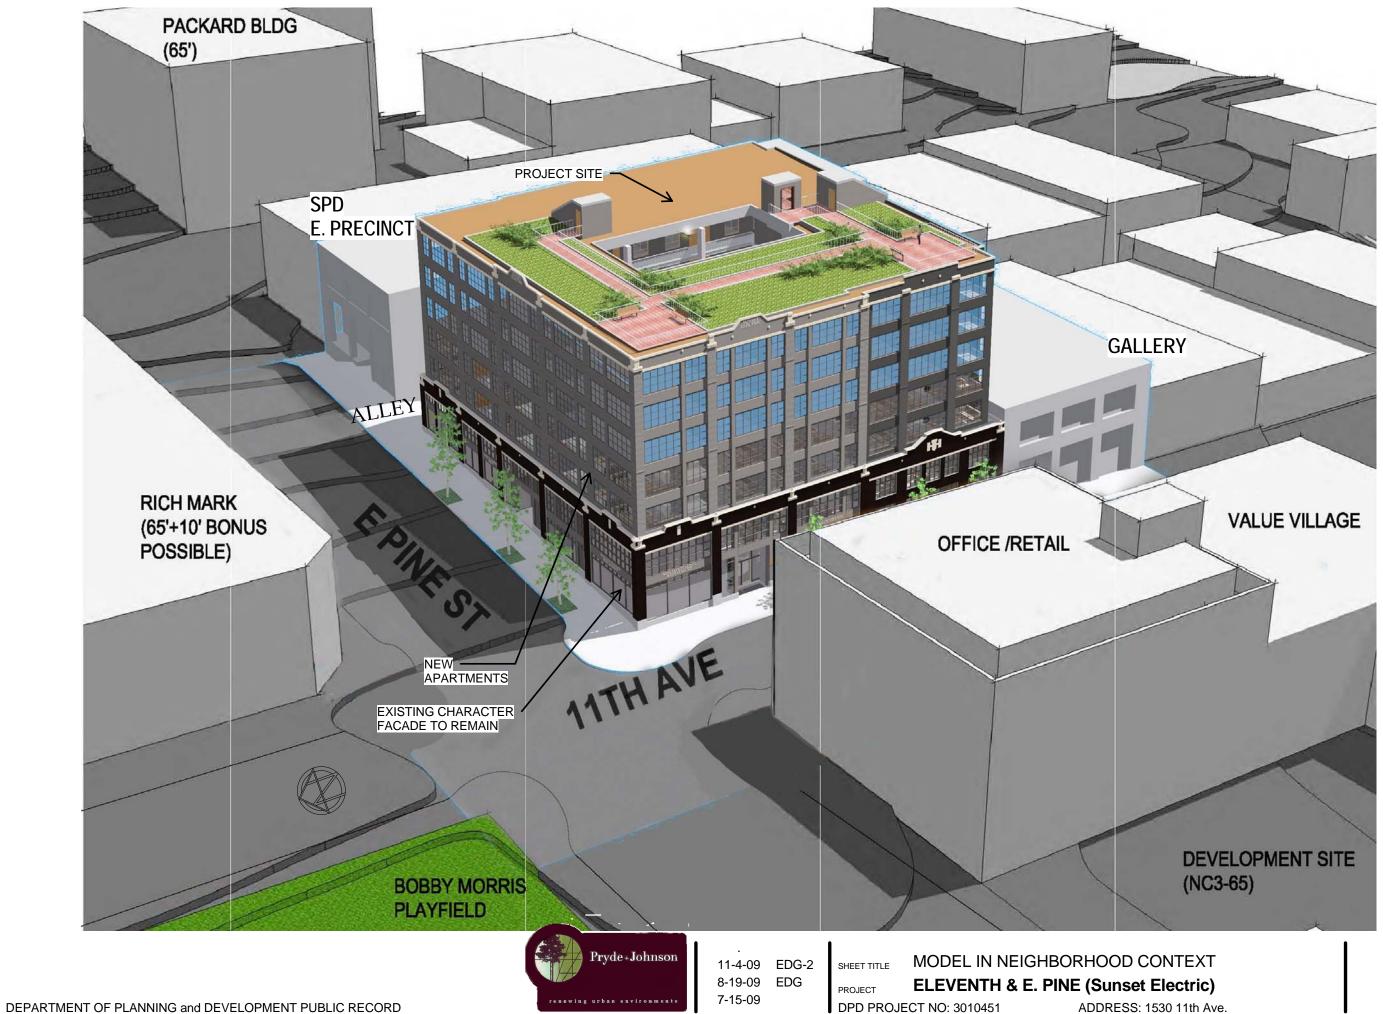

ZONING NOTES

1530 11th Avenue

Amended sections shown underlined

Site Zoning Designation:

NC3-65 PN on principal pedestrian street per the Land Use Map in SMC 23.32.016 and 23.73.004 (Amended in Ordinance 123020)

Site is located in the Pike/Pine Conservation Overlay District (passed 6/29/2009), and the Pike/Pine Urban Center Village

Applicable Code:

-Seattle Municipal Code, Title 23 Land Use Code

Applicable DPD Design Guidelines:

- -Guidelines for Multifamily and Commercial Buildings, 1998 (amended 2006)
- -Pike/Pine Urban Center Village Design Guidelines, 10/15/2000

Adjacent Zones:

NC3-65 with pedestrian overlay north of E. Pine Street and west of 11th Avenue.

Site Area:

120.045' N/S x 127.99'E/W = 15364 sf.

8 x 120.05 Alley easement impact results in 960 sf site reduction resulting in buildable site area of 14.404 sf

Applicable Requirements from SMC, Title 23

23.47A.005 Street level uses

D.1 Along designated principal pedestrian streets,

80% of the street-level

street facing façade

must be occupied by commercial uses specified in this section (arts facilities & automotive retail sales uses added in Ordinance #123020)

E.2. The following are principal pedestrian streets when located within a pedestrian-designated zone: 11th Avenue & <u>East Pine Street</u> (Amended in Map A 23.73.008)

23.47A.008 Street level development standards:

meet standards in this Chapter unless noted otherwise.

- B.3.b. Non-residential uses at street level shall have a floor-to-floor height of at least 13 feet.
- C. Pedestrian Designations. In pedestrian designated zones, 80% of structures street level façade must be occupied by uses listed in .005(E)I.

23.47A.012 Structure height:

A 65 feet

- A.7. In zones with a 65 foot height limit that are located within the Pike/Pine

 Conservation Overlay District, the Provisions of 23.73.010 (F) apply. New structure may exceed the height limit by 10 ft, if the lot includes a character structure that is to be saved.
- B On sloped lots, additional height is permitted along the lower elevation of the structure footprint, at the rate of I foot for each 6% of slope, to a maximum additional height of 5 feet. (per 23.47.012, Exhibit B).

23.47A.013 Floor Area ratio:

Chart A Maximum FAR for 65 foot height limit:

4.75 for structures containing both residential and non-residential uses. (Amended in 23.73.009)

D.1 All gross floor area below existing or finished grade is exempt from FAR limits.

23.47A.014 Setback requirements

Provisions not applicable. No setbacks required under this section

23.47A016 Landscaping and screening standards

A.2. Green Area Factor Requirement.

Landscaping to achieve a green factor score of .30 or greater per 23.84A.014

B.1 Street trees are required and existing street trees shall be retained unless SDOT approves their removal. (Note street trees have been reviewed by Bill Ames, City Arborist)

23.47A.024 Residential Amenity Areas

None required per amendment, (See 23.73.010.G)

Landscapes amenity spaces are proposed on second floor residential court and roof top deck.

23.54.015 Required parking:

- **B.2** Chart B: No minimum requirement for parking residential uses in commercial zones within urban centers
- **D.1.** Chart D: In pedestrian-designated NC3 zones, parking is waived for the first 5,000 sf of each business establishment for most commercial uses. For eating and drinking establishments, the first 2,500 sf is waived
- **G** Up to 20 required parking spaces are waived for new non-residential uses in existing in commercial zones. (No nonresidential parking required)

Approximately 36 stalls for residential use are proposed in the existing basement.

Access is off the private alley.

23.54.030 Parking space standards

D.1.e The minimum width of residential driveways for two (2) way traffic serving more than 30 stalls shall be 20 feet (See Departures)

Chapter 23.73

Pike/Pine Conservation Overlay District

23.73.002 Purpose and intent:

A. Purpose of District is "to preserve and enhance the balance of residential and commercial uses, by encouraging residential development and discouraging large, single-purpose commercial development. In addition, a purpose of this chapter is to promote the conservation of Pike/Pine's existing historic character by limiting development to a scale that is compatible with the established development pattern ,accommodating arts facilities and small businesses at street level and encouraging the retention of the existing structures and their architectural features that establish the

District's architectural character.

23.73.008 Uses at street level:

- A. Street level uses on principal pedestrian streets are per 23.47A, except as modified by this section.
- B. All new structures with >5,000 sf of commercial uses at street level. excluding arts theaters, arts facilities, and parking and access, shall include commercial spaces at street level that average 2,000 sf or less in size per Table A in 23.73.008.

(Project exempt from this provision proposed street level is a renovation of An existing character structure and not a 'new' structure)

C. Maximum length of street frontage for an individual business within a new structure on East Pine is 50 feet. (Project exempt from this provision-proposed street level is a renovation of an existing character structure and not a 'new' structure)

23.73.009 Floor Area Ratio

A. FAR limits of the underlying zones for residential use apply. (See 23.47A.013)

C.1 Non-residential use located in a character structure is exempt from FAR.



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ZONING NOTES

SHEET TITLE

ELEVENTH & E. PINE (Sunset Electric)

PROJECT NAME

23.73.010 Development Standards from Pine/Pike Conservation Overlay District

A. Floor size limit: Max. gross floor area of any single story above 35 feet is

15,000 sf on lots greater than 15,000 sf.. (Lot area including private alley is 15,364

Existing character structure footprint is approximately 14400 sf.

A 25% increase in the floor size limit above 35 feet in height is permitted for

N.A.-No increase in floor size is feasible due to size of site and existing

character structure footprint of approximately 14400 sf No increase in floor size limit

The limit on width shall not apply to the following: Portions of a new

the Director may permit the height of a structure to exceed the height limit of the zone

by 10 feet. Must retain character structure and additional height must be residential

use. Must also comply with 23.73.010.C if increase in floor size limit above 35 ft is

proposed, does not apply as building area is less than 15,000 sf.

structure separated from a street property line by a character structure.

I. Residential Amenity space is not required for structures existing as of

April 1, 2000, that are repaired, renovated or structurally altered... provided that street

Location of parking: Parking provided as accessory parking for any

permitted use may be located on the lot, or built into or under the structure. (Note

Approximately 36 stalls for residential use are proposed in existing basement.

"Character structure" means a structure on a lot within the boundaries of the

years, thereby contributing to the established scale, development pattern, and

Pike/Pine Conservation Overlay Diestrict that has been in existence for at least 75

facing facades are retained and 50% or more of the gross floor area is retained.

Landscaped amenity space is proposed at second floor court and roof top deck.

Height exception for lots that include a character structure: In 65 foot zones,

above 35 ft. is proposed. Since lot building area is less than 15000 sf. C.2..b 15'

Proposed floor area above 35 feet is less than 15000 sf.)

projects that incorporate a character structure.

Residential Amenity Space.

parking not required per 23.54.015)

architectural character of the area.

Proposed green factor to be a minimum of 0.3.

landscaped courtyard on Level 2, and a partial green roof.

setback does not apply.

Bonus strategies include drought-tolerant or native plant species, harvested rainwater, and landscaping visible from the ROW

Project proposes to comply via street trees and tree pits in the ROW, a private

PROPOSED DEPARTURE

23.86.019 Green Factor:

sf.

Η.

23.84A.006 "C"

23.54.030 Parking space standards:

D.1.e Project requests departure from 20 foot minimum driveway width requirement to allow parking access from the existing 16 foot wide private access easement, in order to retain the existing character structure.

Proposed parking consists of approx 36 stalls accessed via private alley. Parking Stalls will be used for employee and resident parking.

Benefit: Approval of this driveway width departure allows reuse of the existing character structure.



3

SHEET NUMBER

103 le, WA 98105

Response to Design Guidance Priorities

A. Site Planning

A.1 Responding to Site Characteristics

Existing Base (2 story facade):

Maintain existing historic brick base walls on 11th Ave, E. Pine and one Bay in Alley which is currently brick faced. Concrete base wall beyond the alley brick bay will be removed and replaced with new construction. Existing masonry will be restored. Windows will be replaced with new storefront frames and clear glass. Window divisions will be spaced to emulate industrial sash common to neighborhood and era of original building. Existing Terra Cotta trim and accents will be retained integrally with the masonry and repaired as required. Interior Floors will be replaced with new construction.

Use wise, the entire two story existing façade along E. Pine street, the corner bay at E. Pine and 11th and the corner bay at Pine and the alley is committed to commercial with the possibility of mezzanines depending on actual tenant requirements. The remaining portion of the east (alley side) and west (11th) second floor is residential units behind the commercial scaled storefront so perception of the commercial base is still maintained

Floors 3-7:

The features below are employed to be simple and understated allowing the base existing structure to express its history with minimal competition from the upper structure; and, and also the features of the new residential are selected to reinforce the bays and glazing divisions typical of that era.

On 11th Ave the building has two distinct characters ("A" and "B"). The southern portion (3 bays) is distinctly different than the bays to the north of it on 11th Ave. The upper portion (floors 3-7) of the southern 3 bays on 11th is set back behind the base wall approx 3'-6"; and the upper portion (floors 3-7) for bays north of that and around the corner and up E. Pine Street are set back from the base wall approx 1'-6". The setting back of the upper portions of the building emphasizes the base; and the differential in the upper level setbacks reinforces the two distinct characters of the base façade on 11th Ave.

Color is also used to reinforce this "A" /."B" condition The color of approx 2'-8" wide pilasters, 1'-0" wide window bay dividers, and spandrels between upper floors (3-7) of the 3 southern bays on 11th ("A") are slightly darker than the color of the upper floors (3-7) for the bays north of them and around the corner and up E. Pine Street ("B")

The upper stories vertical pilasters (approx 2'-8" wide & aligned above the brick pilasters on the first two stories of brick) are clad with vertical metal with light fluting. The approx 1'-0" wide vertical glazing dividers between pilasters are clad with metal with a flat surface. The spandrels will have relatively flat metal which may have some minor divisions for strength and character. Windows will be vinyl or fiberglass with divisions (in the spirit of the base) spaced to emulate industrial sash common to neighborhood. The parapet is treated simply with minimal trim to recall the history of the base but in a quiet manner to allow the base masonry to capture the viewer's attention. Accent trim shown on the upper building is limited and will be either simple metal pieces or foam covered with a durable finish. Trim will be colored to match the base terra cotta trim. It is in the spirit of art deco but underplayed. The coping covering the parapet will be colored to match the trim found in the base of the building and the upper building accent pieces.

The east wall first bay closest to E. Pine will be like the E. Pine street treatment. The remaining east wall bays to the south above the newly constructed two story base will be simple metal siding similar to the Pine street side but with smaller windows and a somewhat greater amount of wall surface. The new 2 story alley concrete base will be painted darker to reinforce the existing strength of the existing base

The south wall is has two re-entrant corners in it to allow glazing in the south wall next to 11th Ave and next to the alley. This feature along with differential color treatment of this concrete block wall will soften this façade which eventually will be covered when property owners to the south eventually fulfill the zoning potential for their site. The advantage of locating these south window as proposed is to give the living rooms of the units at the SE and SW corners of the building windows on two walls which make a delightfully bright living space while it also gives that façade animation. To reinforce the "A" building on 11th Ave the south wall will take the "A" coloring from 11th Ave.

A-4 Human Activity

The proposed design should encourage pedestrian activity at the sidewalk with full height transparent glazing with an industrial pattern that wraps into the corner of the alley. Potential recessed shop entries, proposed roll up glazed garage door for on street presence of a shop or café are provided in the design. The garage door element is located at an existing garage door reinforcing the auto use history. Larger landscaped tree pits are provided allowing for pleasant plantings at the pedestrian sidewalks. The design allows for potential small business entry off the alley. The residential lobby is at the south end of the building and faces 11th Ave.

A-8 Parking and Vehicle Access

Approximately 36 parking stalls for residential use are proposed to be located in the existing basement with access by the private alley of E. Pine St. This will help to minimize the automobile impact on the pedestrian environment.

A-10 Corner Lots

The 2 story commercial space is being maintained along E. Pine including the NW & NE corner bays (approx 24 feet wide) at 11th & E. and at 11th and the alley respectively. The remaining portion of the east façade (alley side) and west façade (11th) second floor is residential units behind the commercial scaled storefront so perception of the commercial base is still maintained. The new structure above is set back slightly from the existing façade to preserve the original symmetrical character and alignment with the existing façade. The industrial sash window pattern is repeated in the new structure above.

B. Height Bulk And Scale

B-1 Height bulk and scale compatibility

The 11th avenue façade was designed to respond to the two different building appearances of the existing building on that avenue. The southern 3 bays we identify as the "A" building and the remaining bays to the north including the E Pine street façade we identify as the "B" building. The new upper stories of the "A" building are set 3'-6" behind the existing 2 story brick base and are proposed to be colored a warm gray slightly darker than medium. The new upper stories of the "B" building are set 1'-6" behind the existing 2 story brick base and are proposed to be colored a warm medium gray. In all the new upper stories, the vertical pilasters align with the brick pilasters in the existing 2 story brick base below. This integrates the scale of the existing and new building elements. Further by using large areas of glazing in the upper portion of the building, between the approx 2'-8" wide pilasters and approx 1'-0" wide intermeiate vertical dividers and dividing the glass in an industrial sash like character, the existing façade is recognized in patterning above and compatibility with existing is reinforced.

The recognition of "A" and "B" character, the pilaster alignment, the window divisions recalling industrial sash, and the color differentials all contribute to breaking down the building bulk and creating scale and character compatibility.

C. Architectural Elements C-1Architectural Context

The design elements and decisions explained in B1 above are consistent with the surrounding buildings. The setbacks, coloring, pilasters, window divisions and scale elements are contextual within the neighborhood.

The design decisions pay respect to the existing building colors, pilaster arrangement, character differential ("A" and "B" appearance, see B1 above), windows, and detail. The new structure set back slightly from the existing façade to allow the existing renovated base masonry to predominate the viewers attention. New windows in the base will be of industrial sash character in keeping with the existing neighborhood. The new building above is understated with columns spandrels, and glazing divisions selected to reinforce the industrial character of the existing building.

C-2 Architectural Concept and Consistency

In keeping with the existing neighborhood character the full height of the existing façade including brick, pilasters and terra cotta trim along the entire frontage at E. Pine and 11th Avenue and the most northern bay (approx 23 feet) at alley, will be retained. The windows will be replaced with a system divided to represent the appearance of industrial sash found in the neighborhood. The ground floor will have commercial uses and the apartment entry lobby.

In addition to the E Pine street frontage, including the northern most bay on the alley and the northern most bay on 11th Avenue the second floor will be used as commercial. Within the extent of this described space, a potential mezzanine could be constructed if desired by a future tenant. This provides two story commercial all along Pine including each building corner (approx 23 foot bay) adjacent to Pine.

Apartments are proposed on the second floor behind the existing façade along the remaining part of the west elevation along 11th Avenue and remaining part of the east elevation. The first floor commercial space will have a minimum floor to floor height of 14ft. A design departure will not be required for this element.

The new building is integrated with the existing façade with new vertical pilasters in alignment with the existing brick, window spacing and divisions in character with the existing base.

The 15' setback referenced in 23.73.10(c) 2b does not apply to this site as the building area is less than 15,000 sf and no increase in floor size is requested.

C-4 Exterior Finish Materials

The existing masonry base will be restored. The new building above is proposed to be finished with metal panels with light fluting at pilasters with relatively flat 12" w glazing dividers and spandrels. The parapet metal is treated simply with minimal trim to recall the history of the existing base. Subtle color variation will be used to reinforce the two distinct ("A" and "B") characters of the 11th Avenue side of the existing base.

D. Pedestrian Environment.

D-2 Blank Walls

The new building has window divisions on the alley side in character with the street sides and minimizes blank walls. The ground level alley side has the potential for commercial entry if desired by future tenant.

The south elevation of the building is activated with windows at the east and west edges setback from the south property line. This notch in the building and related glass will break down the scale of the wall from the street and provide a second window to give the SE and SW views to the south out of their living rooms where they are above the adjacent property roof top

D-8 <u>Treatment of Alleys</u>

The existing base street façade wraps into the alley approx 24' and will be renovated with restored masonry and new glazing. The new building above reinforces the alley corner with column and window massing in character with the existing base.

D-11 Commercial Transparency

Commercial store fronts will engage with pedestrians at the sidewalk with full height transparent glazing providing good visual connection with the sidewalks.

E. Landscaping

E-2 Landscaping to Enhance the Building and Site

The proposal includes a landscape court at the second floor and roof top deck with drought tolerant landscaping to achieve a green factor score of .30 or better. Larger landscaped tree pits in the sidewalks will bring the green factor to the street right-of-way, to help activate and enliven the site.



11-4-09 EDG-2 8-19-09 EDG 7-15-09 RESPONSE TO DESIGN GUIDANCE PRIORITIES

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PROJECT NAME
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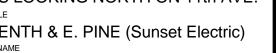






7-15-09

VIEWS LOOKING NORTH ON 11th AVE.
SHEET TITLE
ELEVENTH & E. PINE (Sunset Electric)
PROJECT NAME 11-4-09 EDG-2 8-19-09 EDG









11-4-09 EDG-2 8-19-09 EDG

7-15-09

VIEW LOOKING SOUTHEAST
SHEET TITLE
ELEVENTH & E. PINE (Sunset Electric)
PROJECT NAME



4.1





8-19-09 EDG 7-15-09

11-4-09 EDG-2

VIEW LOOKING S.E. ON E. PINE ST.
SHEET TITLE
ELEVENTH & E. PINE (Sunset Electric)
PROJECT NAME







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VIEW LOOKING SOUTH ON E PINE ST SHEET TITLE ELEVENTH & E. PINE (Sunset Electric) PROJECT NAME











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SPD EAST PRECINCT








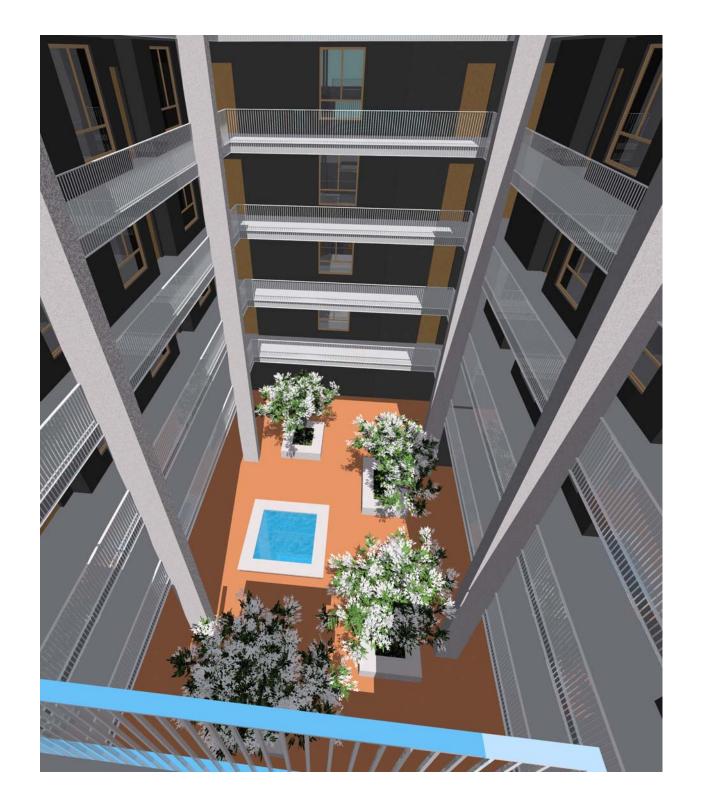

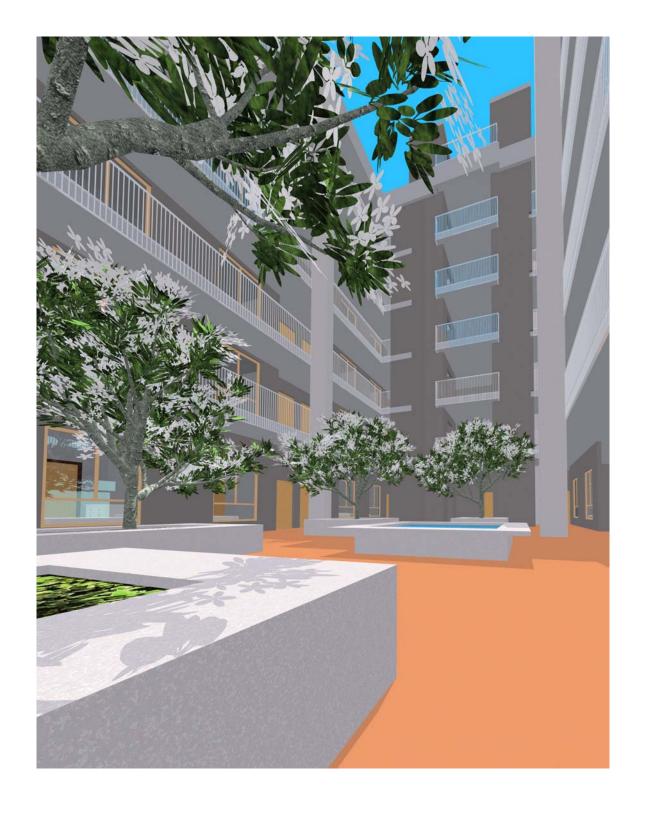





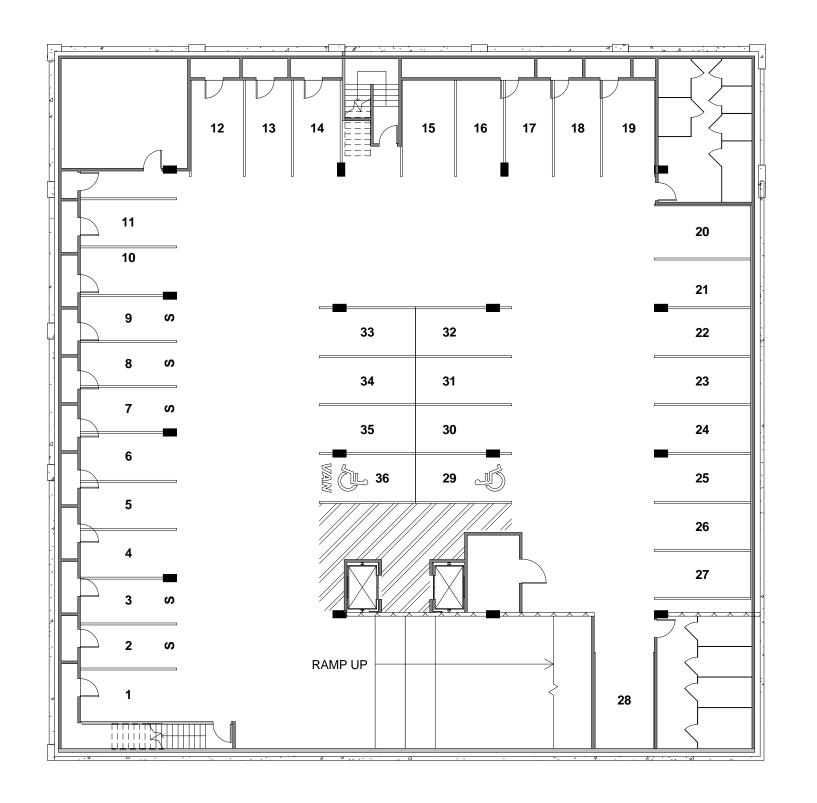



SCALE: 1/16" = 1'-0"






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BASEMENT / GARAGE
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PROJECT NAME
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5 SHEET NUMBER



FLOOR PLAN - STREET LEVEL

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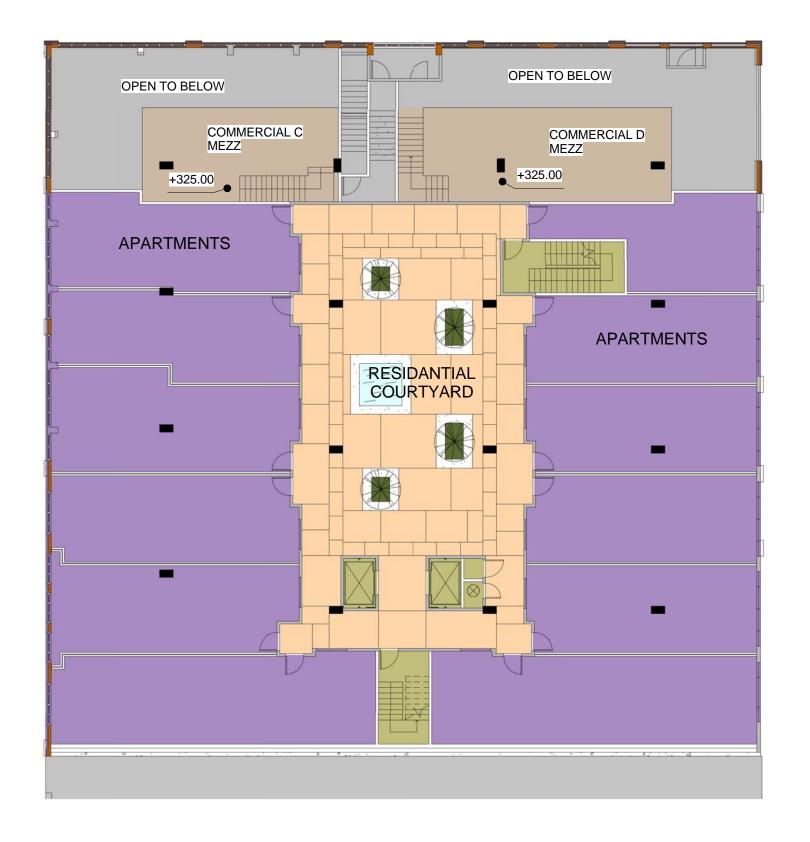


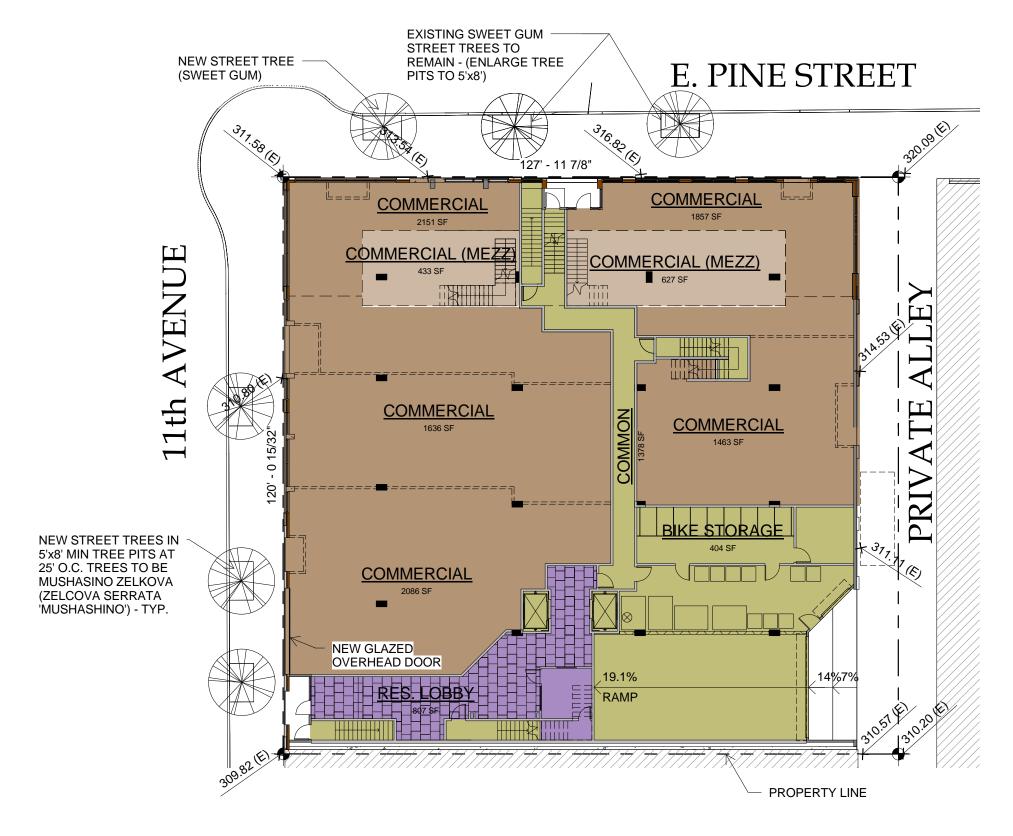

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SCALE: 1/16" = 1'-0"



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LEVEL 2 (COURTYARD)

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8-19-09 EDG

LEVEL 2 (COURTYARD)

SHEET TITLE


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5.2



FLOOR PLAN - LEVELS 3-7

SCALE: 1/16" = 1'-0"



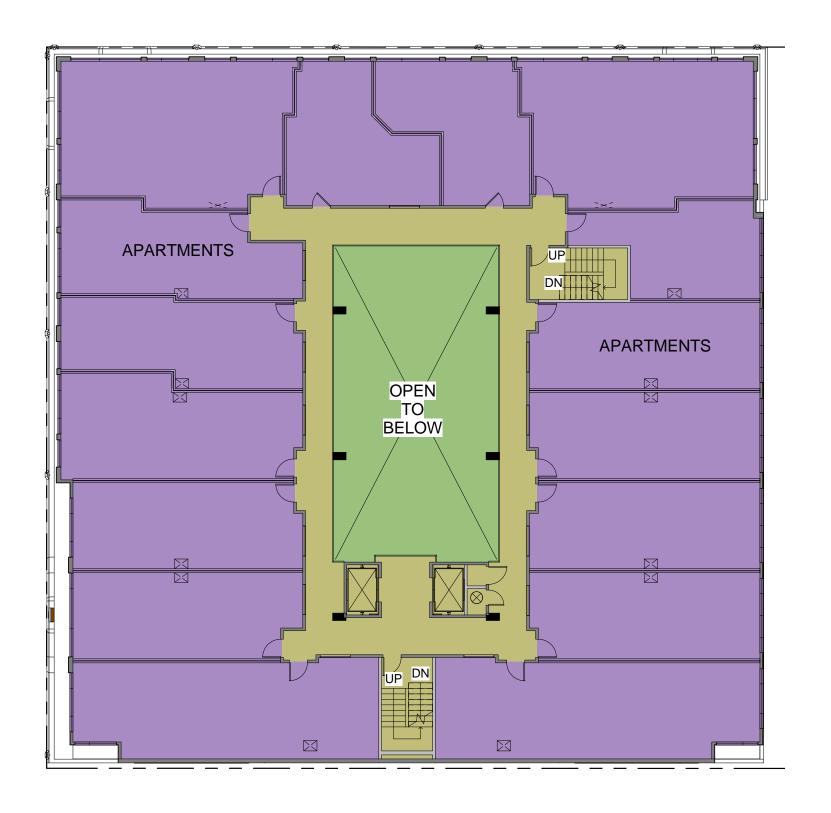


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LEVELS 3-7
SHEET TITLE 11-4-09 EDG-2 ELEVENTH & E. PINE (Sunset Electric) PROJECT NAME





ROOF PLAN

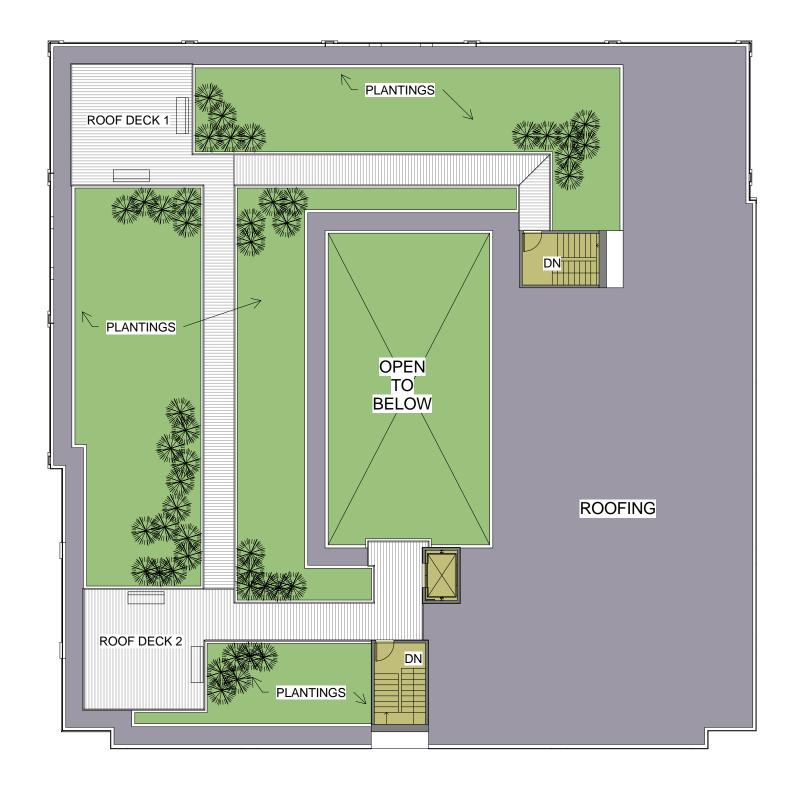SCALE: 1/16" = 1'-0"





5.4SHEET NUMBER



BUILDING SECTION LOOKING NORTH

SCALE: 1/16" = 1'-0"




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WEST WALL SECTION

SCALE: 3/32" = 1'-0"




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WEST WALL SECTION
SHEET TITLE
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5.6
SHEET NUMBE

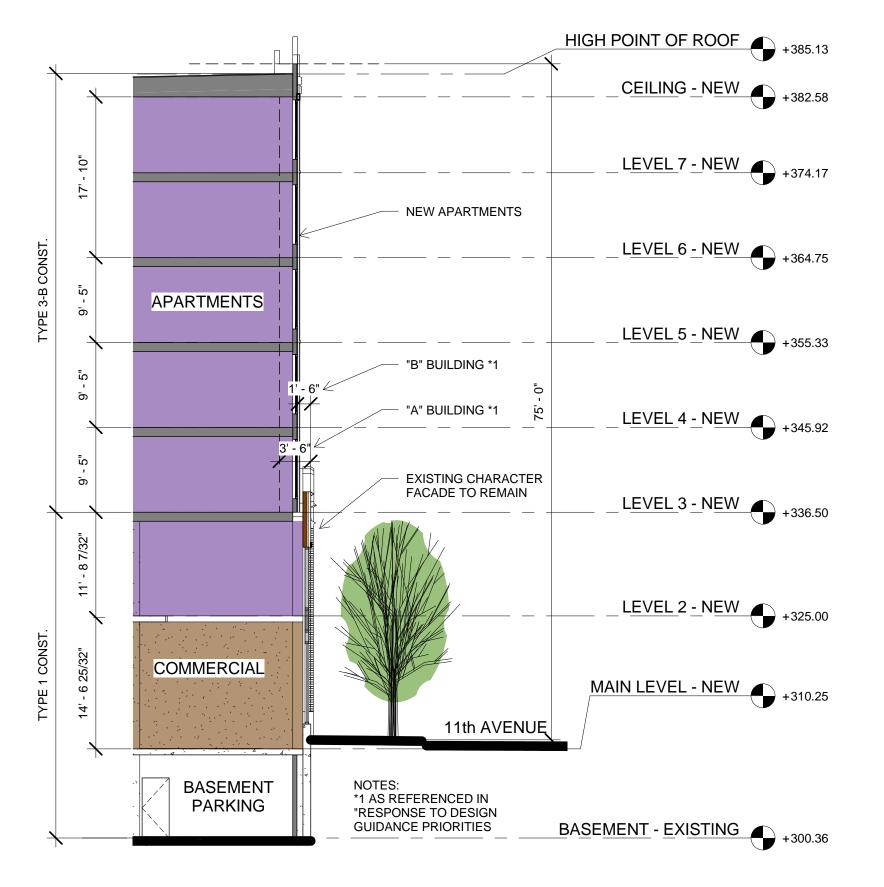

WEST ELEVATION (11th AVENUE)

SCALE: 1/16" = 1'-0"

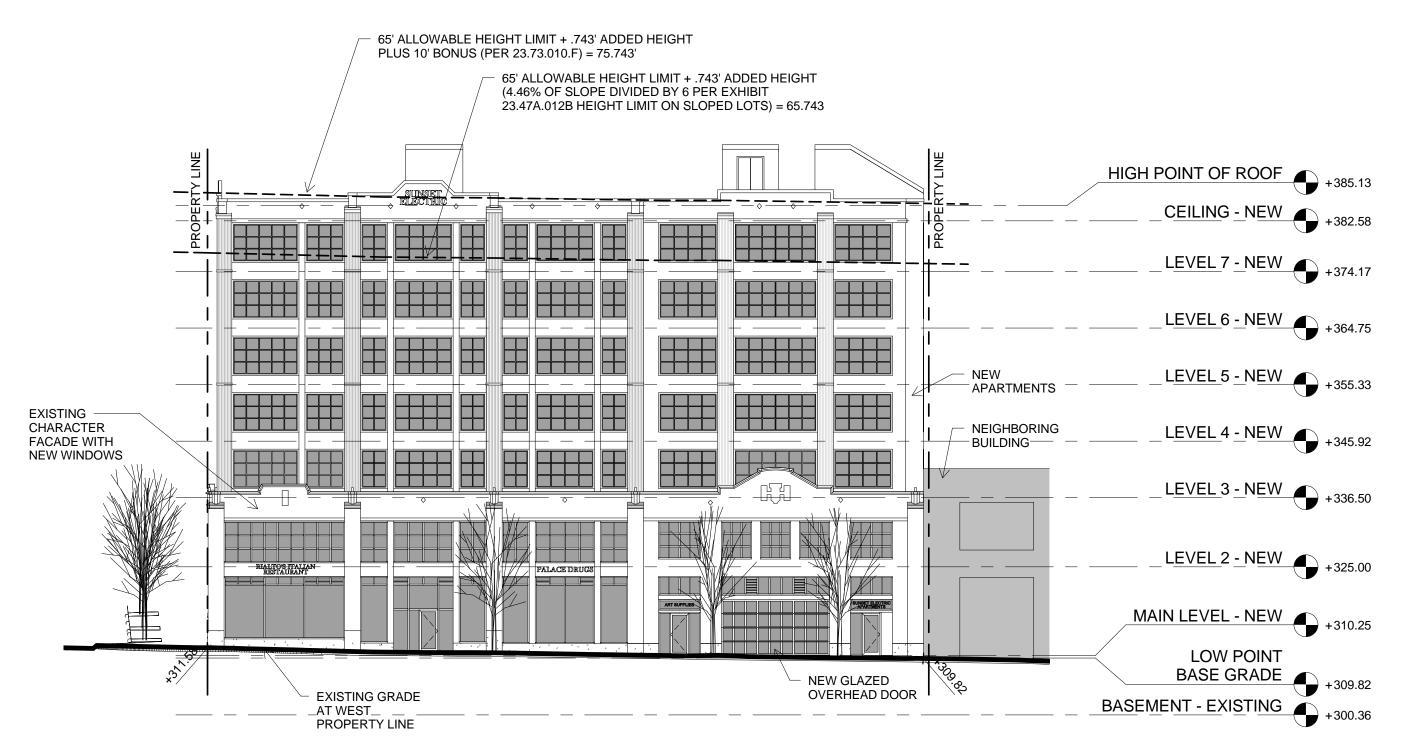


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WEST ELEVATION
SHEET TITLE
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NORTH ELEVATION (E PINE STREET)

SCALE: 1/16" = 1'-0"




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7-15-09

NORTH ELEVATION
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EAST ELEVATION (ALLEY)

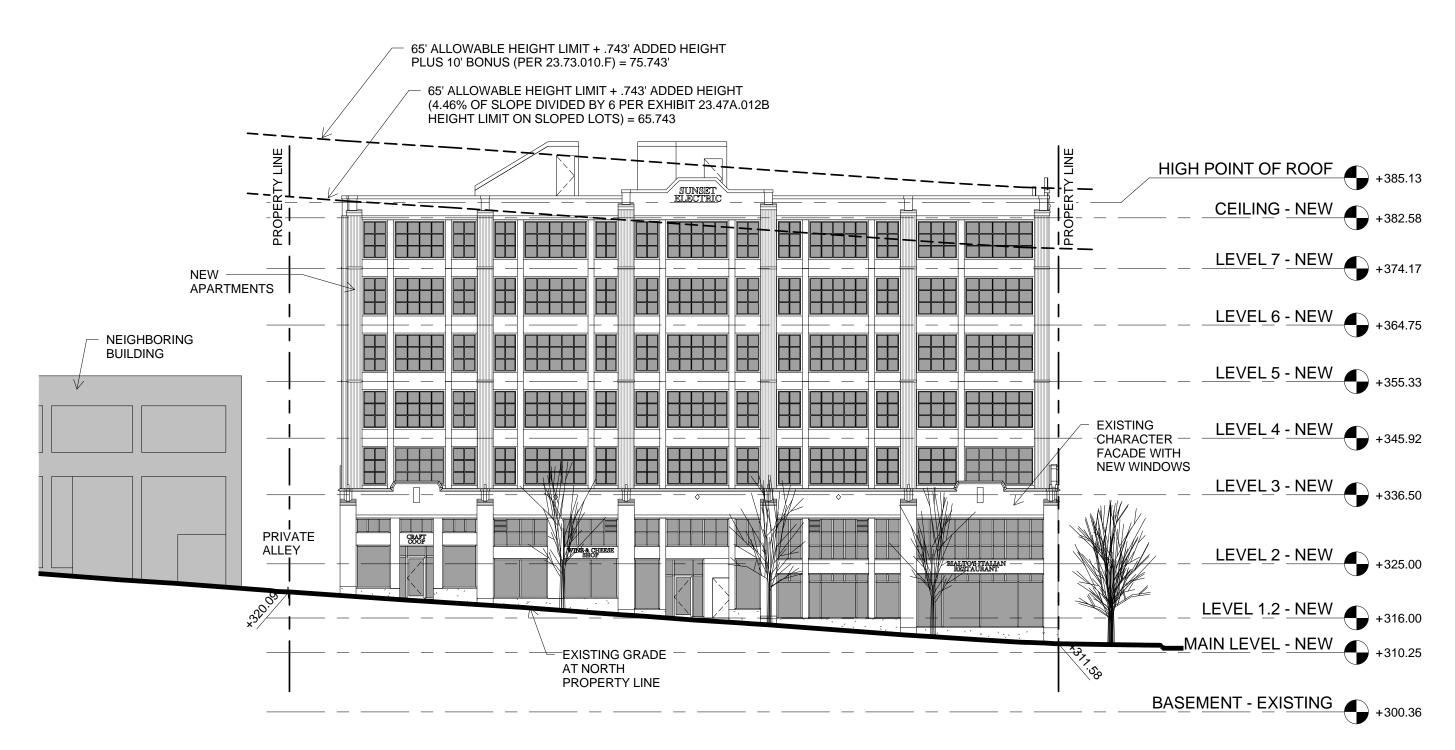SCALE: 1/16" = 1'-0"

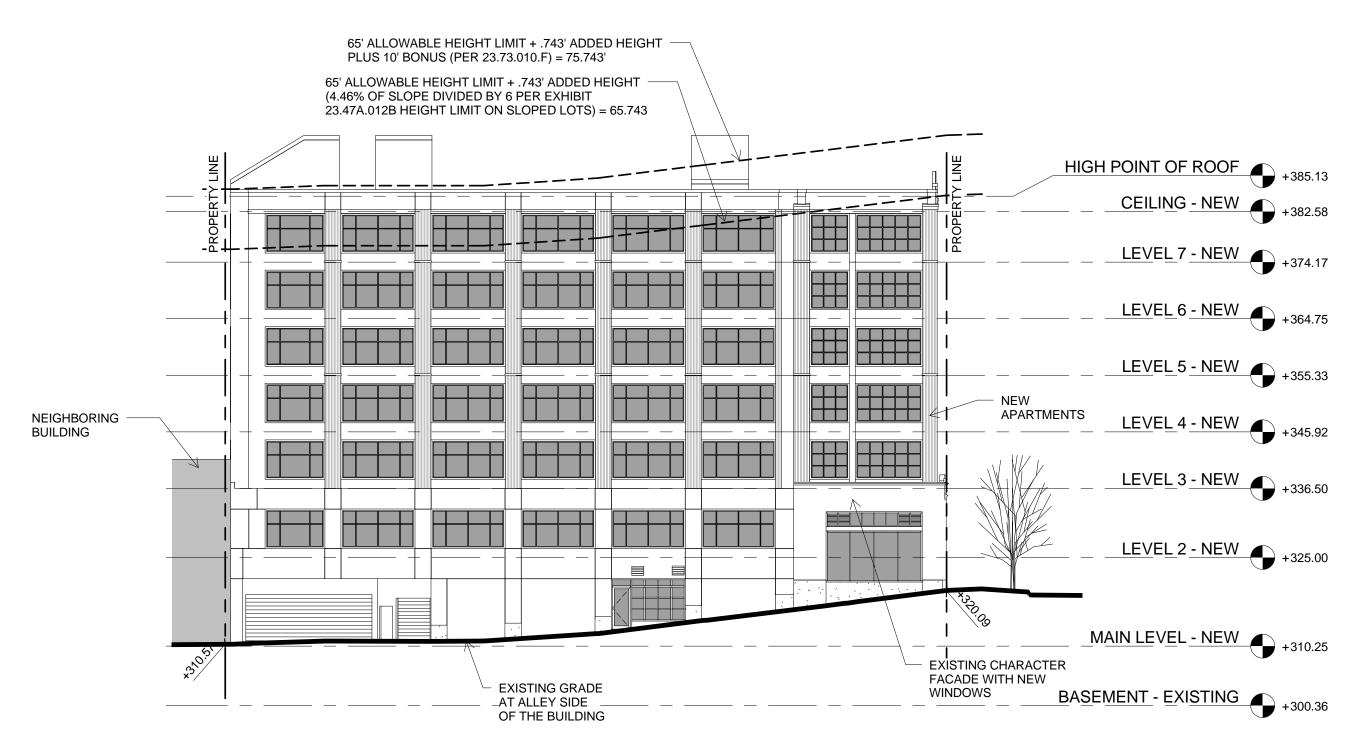


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SOUTH ELEVATION

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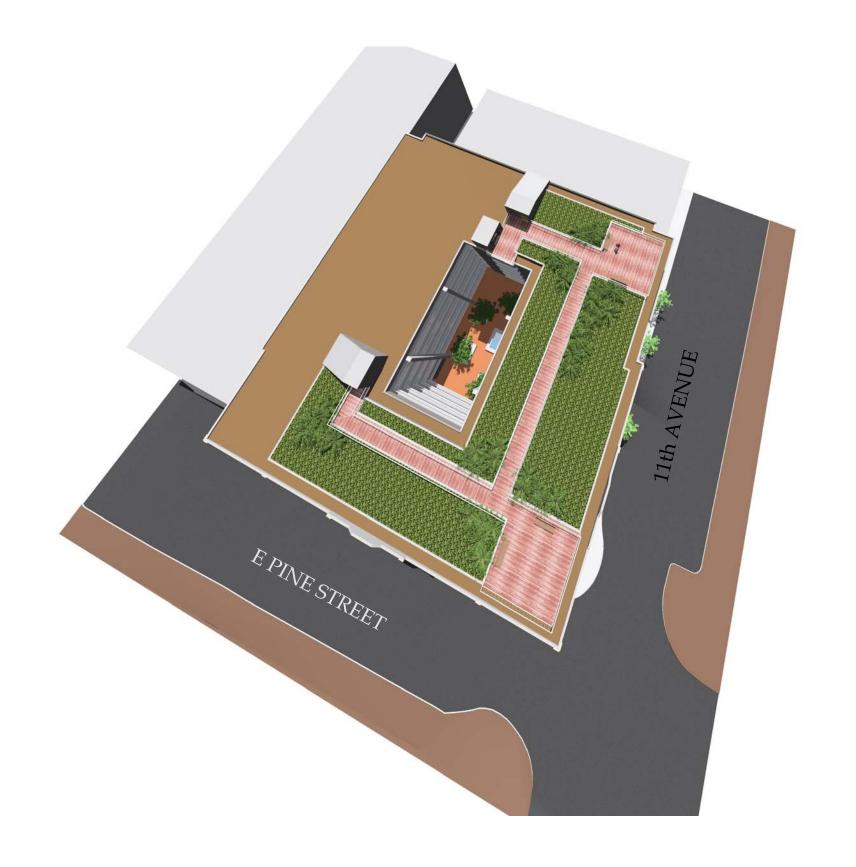


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SOUTH ELEVATION
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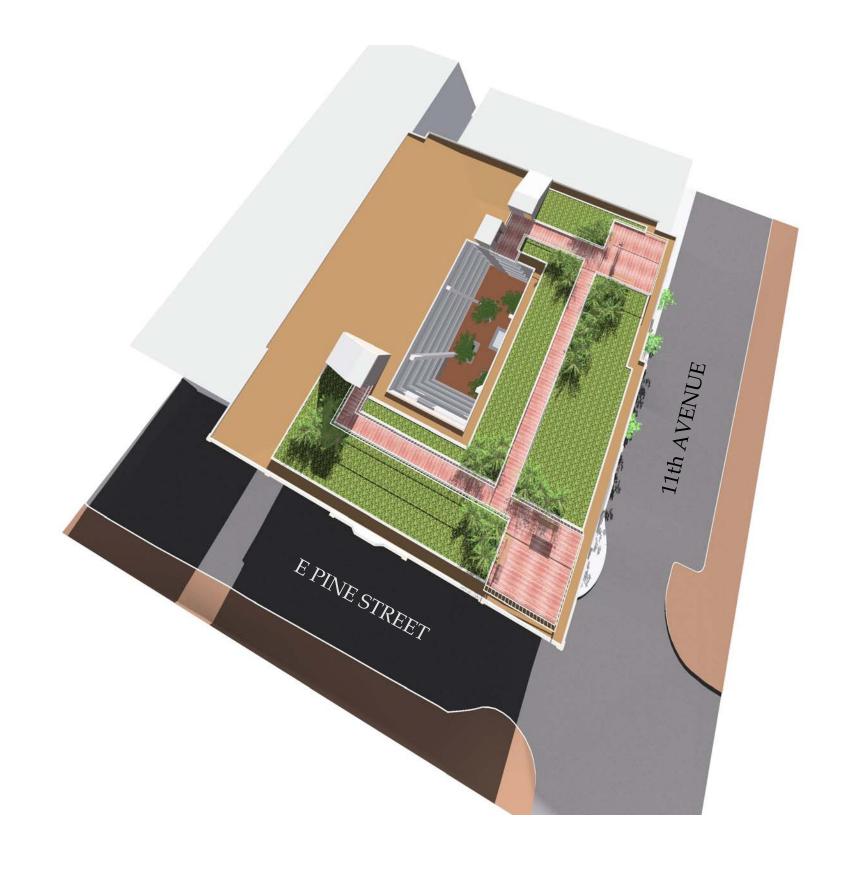




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SHADOW STUDY JUNE 21 (NOON)
SHEET TITLE
ELEVENTH & E. PINE (Sunset Electric)
PROJECT NAME

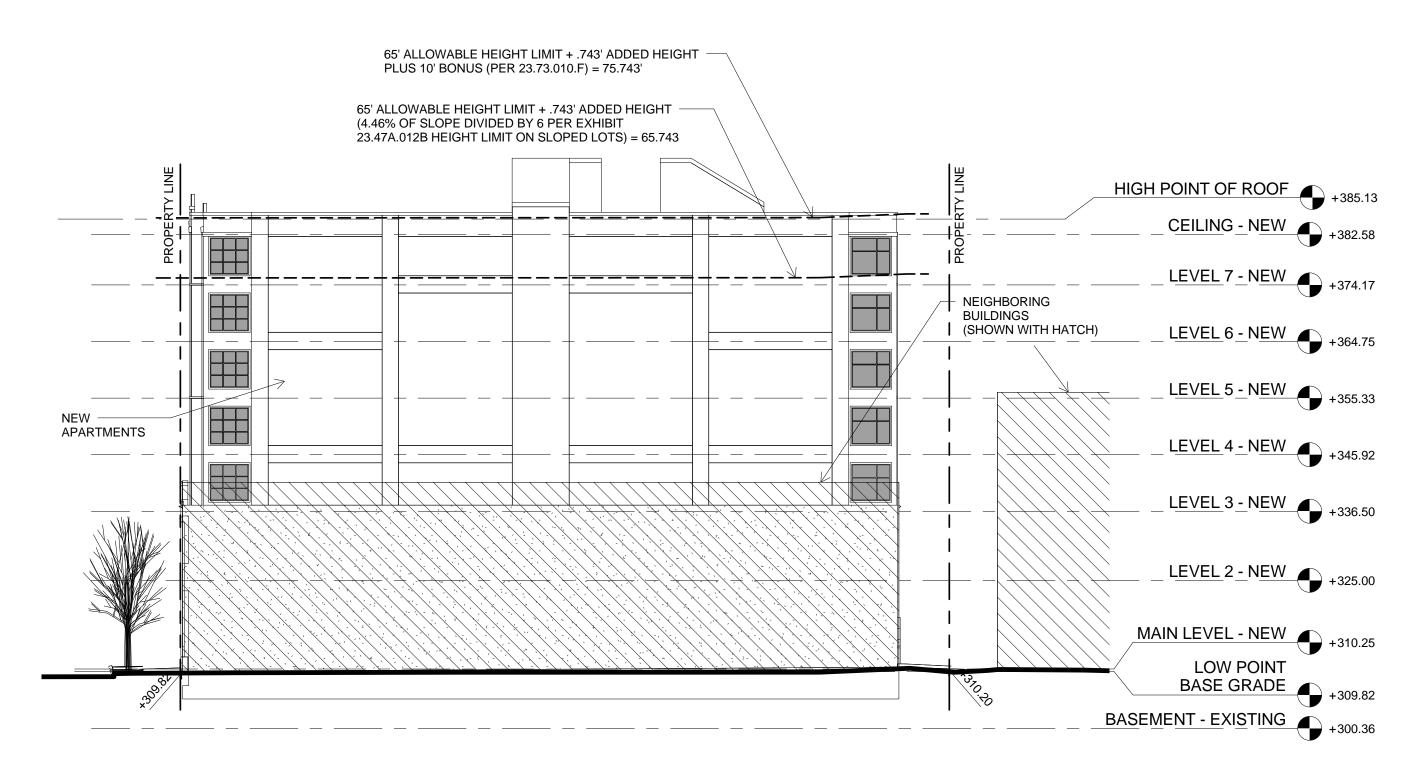





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SHADOW STUDY DEC. 21 (NOON)
SHEET TITLE
ELEVENTH & E. PINE (Sunset Electric)
PROJECT NAME



11th AVE and E PINE. LLC (SUNSET ELECTRIC) - EARLY DESIGN GUIDANCE

| PRELIMINARY PROJECT DATA SUMMARY | | | | | | | | | | | |
|----------------------------------|------------|-------------|-------------|----------|----------|----------|---------|--------|--------|--------|------------|
| | | | | | Common / | | | | | | |
| Level | Commercial | Residential | Residential | Parking | Trash / | Building | Parking | Studio | 1 Bdrm | 2 Bdrm | |
| Number | Gross SF | Gross SF | NSF | Gross SF | Recycle | Gross SF | Stalls | Count | Count | Count | Unit Total |
| Basement | | | | 14400 | | 14400 | ± 36 | | | | |
| 1 | 9214 | | | | 2975 | 13248 | | | | | |
| | 1060 MEZZ | | | | | | | | | | |
| R-2 | | 10859 | 7744 | | | 10859 | | 1 | 11 | | 12 |
| R-3 | | 12172 | 10405 | | | 12172 | | 1 | 13 | 2 | 16 |
| R-4 | | 12123 | 10356 | | | 12123 | | 1 | 13 | 2 | 16 |
| R-5 | | 12123 | 10356 | | | 12123 | | 1 | 13 | 2 | 16 |
| R-6 | | 12123 | 10356 | | | 12123 | | 1 | 13 | 2 | 16 |
| R-7 | | 12123 | 10356 | | | 12123 | | 1 | 13 | 2 | 16 |
| TOTAL | 10274 | 71523 | 59573 | 14400 | 2975 | 99171 | ± 36 | 6 | 76 | 10 | 92 |

% of TOTAL: 6.5%

82.6%

10.8%

ACRES UNITS UNITS / ACRE 0.35 92 263

*SITE AREA = 15,364 SF, Existing ground floor area 14,400 SF

*All areas and statistics are preliminary subject to design

FLOOR AREA RATIO CALCS,

PER 23.47A.013

Chart A Maximum FAR for 65 foot height limit: 4.75 for structures containing both residential and non-residential uses. (Amended in 23.73.009) D.1 All gross floor area below existing or finished grade is exempt from FAR limits.

PER 23.73.009.C.1

Non-residential use located in character structure is exempt. Site area = 15,364 16364 (4.75) = 72979 72979 > 71523



11-4-09 EDG-2

8-19-09 EDG

7-15-09

PROJECT DATA SHEET TITLE **ELEVENTH & E. PINE (Sunset Electric)** PROJECT NAME




^{*}L/W unit at street level no longer part of application



| 1 | GOAL Maintain history and conserve material and labor intrinsic in existing construction | STRATEGY Save Two Storey Existing Façade |
|----|---|--|
| 2 | Use local materials | Make effort to utilize materials from local area including masonry, concrete and steel |
| 3 | Increase Indoor Environmental quality with Natural Ventilation, Daylighting, and Healthy finishes | Courtyard scheme allows thru ventilation and windows on both sides of most units to enhance natural ventilation and day-lighting. Specify adhesives, carpets, paints accordingly |
| 4 | Maximize Waste Stream for minimal environmental impact | Manage for maximizing Demolition Material & Construction Waste to recycling. Minimize materials sent to landfill. Provide tenants with good recycling program for waste that they generate |
| 5 | Encourage transportation alternatives to auto | Provide bicycle storage, inform tenants of carpooling and transit opportunities and schedules, provide for flex car parking |
| 6 | Minimize heat from surfaces | Provide green roof plantings (includes "P" patch and worm bin for tenants for growing food and flowers) Provide street trees Provide interior courtyard landscaping. |
| 7 | Minimize light pollution | Shield exterior lights to minimize off site intrusions |
| 8 | Manage water use to minimize | Use drip irrigation for landscaping Use low flush plumbing fixtures Use rain water to irrigate where possible |
| 9 | Technology Advantages | Do testing, reporting and management of Mechanical and Electrical systems for best outcome of performance and conservation. Use energy baseline and show impact of strategy on reduced use of energy |
| 10 | Incorporate recycled materials | Specify steel, concrete and wallboard to contain portion of recycled material |
| 11 | Include rapidly renewable materials | Include bamboo and cork finishes |
| 12 | Education | Inform users of sustainable features and operation, display resource consumption information |



11-4-09 EDG-2 8-19-09 EDG 7-15-09

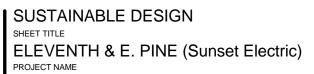



9 SHEET NUMBER