



Developer:

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Morgan Design GROUP LLC

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JOB: 2007040

LAKE CITY WAY MIXED USE
152-UNIT AFFORADABLE SENIOR HOUSING
137 I 6 LAKE CITY WAY NE
RECOMMENDATION MEETING
DPD PROJECT # 3007936

SHEET TITLE:

Project Data

1. Site Address: 13716 Lake City Way NE

2. Parcel Number: 3834000540

3. Lot Size: 33,825 S.F. (approximately) - ~ 0.78 Acres

4. Zoning: C1-65

5. Immediate Vicinity Zones:
site abuts L-I on the east side,
CI-65 north and across Lake City Way (West side)

6. Applicable Building Code:
Seattle Amendments to the 2006 International Building Code (IBC)

7. Proposed Use: Residential Mixed Use ~ Affordable Senior Housing

8. Occupancy Classification:

Office B Residential R-2 Parking S-2

9. Gross Floor Area:

AREA BREAKDOWN:		
	TOTAL AREA	AREA USED FOR FAR
FIRST FLOOR:	30,558 sq.ft.	26,702 sq.ft.
SECOND FLOOR:	20,189 sq.ft.	19,271 sq.ft.
THIRD FLOOR:	23,160 sq.ft.	23,160 sq.ft.
FOURTH FLOOR:	22,899 sq.ft.	22,899 sq.ft.
FIFTH FLOOR:	22,899 sq.ft.	22,899 sq.ft.
SIXTH FLOOR:	22,639 sq.ft.	22,639 sq.ft.
SEVENTH FOOR:	21,764 sq.ft.	21,764 sq.ft.
TOTAL AREA:	164,104 sq.ft.	159,334 sq.ft.

10. Allowable Building Height: Per SMC 23.47A.012 65'
Projections above height limit: clerestories,
parapets, guardrails, elevator/stairs overruns

I I. Allowable Density:
Per SMC 23.47A.009 (A)
no density limit for mixed-use

12. Setback Requirements: SMC 23.47A.014
Below 13 feet: none Provided: none

North property line: none Provided: 10'-2" minimum

East property line: 15 feet (from 13' to 40')

plus 2 feet for every 10 additional feet of height

Per exhibit 23.24A.014C Provided: 17' min.

Street-level, street-facing facades:
 per SMC 23.47A.008 (A.3) must be located
 within 10 feet of the street lot line, unless wider
 sidewalks, plazas, or other approved landscaped
 or open spaces are provided

Structure projections into required setbacks:
 exterior balconies and decks

13. F.A.R. Requirements: SMC 23.47A.013
Max. F.A.R. = 4.75
F.A.R. = Lot size X 4.75 = 33,825 X 4.75 = 160,669 S.F. allowed
Proposed = 159,334 S.F. = 4.71

14. Required Non-residential Uses @ Street-level, Street-facing Facade: SMC 23.47A.005 \$ 23.47A.008

Provided: Along Lake City Way NE Public plaza (open space) per note 23.47A.05 (E. I) open space is an approved street-level use Office/Commercial Spaces: 4,696 S.F.

Average depth for commercial space = 30 feet Provided: 33 feet Floor to floor min. height = 13 feet Provided: 14 feet

15. Required Residential Amenity Areas: SMC 23.47A.024
Required: 5% of the total residential floor area = 5% X 110,165 S.F. = 5.508 S.F.

Provided: 5,511 S.F.

16. Required Landscaping: SMC 23.47A.016
 Required Green Factor = 0.30 - Provided = 0.663
 Provided: Green roof; planting strip along Lake City Way, and 137th Street;
 and, landscaping along north \$ south sides

17. Required Parking: SMC 23.47A.032 \$ 23.54.015

Residential: I per every 4 units

Commercial: varies, approx. I for each 300 S.F. (less first 1500 SF of area)

Provided parking: I 20 Stalls

Bicycle Parking:

Multifamily: I per every 4 units = 152/4 = 38

Provided: 40

Driveway Sight Triangle: 10 feet triangle required

Project Description

The project is a 164,104 S.F., 7-story mixed-use 152-unit affordable senior housing apartment building with 4,696 S.F. of commercial space, parking for 120 vehicles, 110,165 S.F. of residential area, 5,919 S.F. of common area and 9,634 S.F. of residential amenity space.

The building mass addresses each of the three surrounding streets - Lake City Way NE, NE 137th Street, and Erickson Place NE.

The proposed building is arranged in a 'E' shape. Residential units are arranged along double-loaded corridors with internal landscaped courtyards.

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13716 LAKE CITY WAY NE
RECOMMENDATION MEETING
DPD PROJECT # 3007936

SHEET TITLE:

Project Data

RECOMMENDATION

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DATE OG/16/08

SCALE: N.T.S.

DRAWN: JP/JM

DESIGN: JM/JP

APPROVED: JN
SHEET#

SEATTLE MUNICIPAL CODE CHAPTER 24.54A:

STREET LEVEL USES PER SMC 23.547A.005:

A.2b Blank facades - no more than 40% of the street facing facade can have blank walls and no blank wall can be longer than 20' in length.

total street facing facade = 234'-5"

Provided: Blank walls longer than 20' have a landscape screen.

A.3 Setbacks - Street level facades must be with in 10' of the street lot line unless the sidewalk is wider or there is a plaza.

Provided: all street facing facades are within 10° of the street lot line, except the where the plaza at the main entry is.

B.2 Transparency - 60% of the street facing facade must be transparent from 2' above the sidewalk level to 8'.

Required: 234'-5" - 22'-0" (for driveway) = $212'-5" \times 60\% = 127.2'$ required on Lake City Way

Provided: 156'-4" of the street facing has transparent glass from 2' to 8' above the side

walk level along Lake City Way NE

Required: 136'-5" - 10'-0" (for driveway) = $126'-5" \times 60\% = 75.85'$ required

Provided: 27'-7" of the street facing has transparent glass from 2' to 8' above the side

walk level along N 137th - Departure requested

DESIGN DEPARTURE

The length of transparency along N $\,$ 137th is not long enough to meet the requirement - therefore a design Departure has been requested. With the grade change, auto egress, parking and the trash $\,$ \$ transformer rooms needing to be on an exterior wall and a landscape screen along the south wall - the length of required transparency will not be meet.

B.3 Height $\$ Depth of non-residential use - The average depth of non-residential spaces shall be 30' with no areas less than 15' and must have a floor to floor height of 13' at the street level. Proposed: Non residential uses have depths between 28' to 35' and have a floor to floor height of 17'

D. Residential uses are limited to no more than 20% of the street facing facade.

	Lake City Way NE	NE 13/th
length of street facing facade:	234'-5"	136'-5"
length of area for vehicle access:	22'-0"	I O'-O"
length of residential street facing facade allowed:	$212'-5" \times 20\% = 42.48'$	$126'-5" \times 20\% = 25.28'$
length of residential street facing facade provided:	54'-4 1/4" (23%)	102'-9 1/4" (82%)

DESIGN DEPARTURE

The length of residential street facing facade exceeds the allowed - therefore a design departure has been requested. To meet the recommendation of the Design Review Board for a more prominent and visible pedestrian entrance on the corner, the design was changed to relocate the main entry to the corner and provide more visibility from the main lobby for the residents and for covered seating near the entry. The redesign meant that more of the street facing facade would be needed to meet the recommendations of the Design Review Board.

PARKING LOCATION \$ ACCESS PER SMC 23.547A.008:

Access to parking must be from the street with the fewest lineal feet of commercially zoned street frontage, which would be NE I 37th Street.

DESIGN DEPARTURE

A design departure has been requested for this section to allow for the main access and exit to be off of Lake City Way with a second exit only access from NE 137th Street. Traffic traveling both north or south on Lake City Way is not be able to turn on to NE 137th Street. The only way to access the site from a single access from NE 137th Street would be to approach the site from the residential streets to the east of the. The requirement for street level commercial use and this being a residential senior project it is important that the users of the housing and customers of the commercial spaces be able to find the access to the site without having to wander through residential neighborhoods. Traffic studies of the site have recommended that there be a right in right out access off of Lake City Way to handle the bulk of the traffic, but to also have an exit only access to NE 137th Street to avoid backups at the main entrance.

STRUCTURE HEIGHT PER SMC 23.547A.012:

The height of the structure is limited to 65 feet, measured from grade to the highest point on the roof

The proposed height is 63'-7" from existing grade to the top of roof deck, except for the roofs at the stairwells and elevator, where needed to access the roof top deck per 4b.

F.A.R. REQUIREMENTS PER SMC 23.47A.013

The allowable F.A.R. for a project with commercial \$ residential is 4.75

Lot area: 33,825 sq.ft.

F.A.R. allowed: 33,825 sq.ft. \times 4.75 = 160,669 sq.ft. F.A.R. provided: 159,334 sq.ft. = 4.71 < 4.75 ALLOWED

SETBACK REQUIREMENTS PER SMC 23.547A.014:

Required East property line Setback:

For structures with more than one dwelling unit that abuts residential zones 15' of setback is required for structures above 13' to 40'. For each 10' of height above 40' an additional 2' of setback is required.

Proposed East property line Setback:

13-0 for the second floor, 15'-0" for the third \$ fourth floor and 17'-0" for the fifth \$ sixth floor which meets the code requirement.

Required West, South & North property line Setback:

West \$ South are adjacent to public R.O.W. and north is adjacent to commercial zone - no set back is required.

Proposed West property line Setback: min 5" Proposed North property line Setback: min 1'-0" Proposed South property line Setback: min 7"

LANDSCAPING & SCREENING REQUIREMENTS PER SMC 23.547A.016:

All new construction projects must have a green factor of .663.

Please see the landscaping plans for how this project meets these requirements.

LIGHT \$ GLARE STANDARDS PER SMC 23.547A.022:

A. Exterior lighting will be directed down towards the sidewalks and back at the building in a way that will not impact adjacent uses.

B. Interior parking garage lighting will be placed such that the glare will be shielded from adjacent uses.

C. The parking garage walls are solid and the parking is primarily in the interior portions of the parking structure and will provide the necessary screening.

D. There will not be any exterior lighting on poles.

RESIDENTIAL AMENITY REQUIREMENTS PER SMC 23.47A.024

total residential area: 110,165 sq.ft.

 $110,165 \times 5\% = 5,508 \text{ sq.ft.}$ required open community space

total community area provided: 5,511 sq.f

SOLID WASTE & RECYLE MATERIALS STORAGE PER SMC 23.547A.029:

For 152 units the area needed is 200 sq.ft. for the first 100 units plus 2 sq.ft. for each additional units - = 304 sq.ft. required.

Proposed area for solid waste \$ recycle = 317 sq.ft.

PARKING REQUIREMENTS PER SMC 23.47A.030 \$ 032 \$ 23.54.030 \$ 23.54.015

required parking - residential: I stall per every 6 units = 152/6 = 26

parking provided - residential: I 15 stalls

required parking - commercial: I stall per every 1,000 sq.ft. (office)

4,696 - 1,500 = 3,196/1000 = 4 stalls required

parking provided - commercial: 5 stalls

Parking stall size breakdown:

compact stalls: 8 stalls (6%) medium stalls: 1 07 stalls (90%)

accessible stalls: 5 stalls (4%) including I van accessible

parking provided - total: 120 stalls

required bike parking: 1/4 units = 152/4 = 38

bike parking provided: 40

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137 I G LAKE CITY WAY NE
RECOMMENDATION MEETING
DPD PROJECT # 3007936

SHEET TITLE:

Land Use Analysis

DATE

RECOMMENDA
MEETING
REVISION

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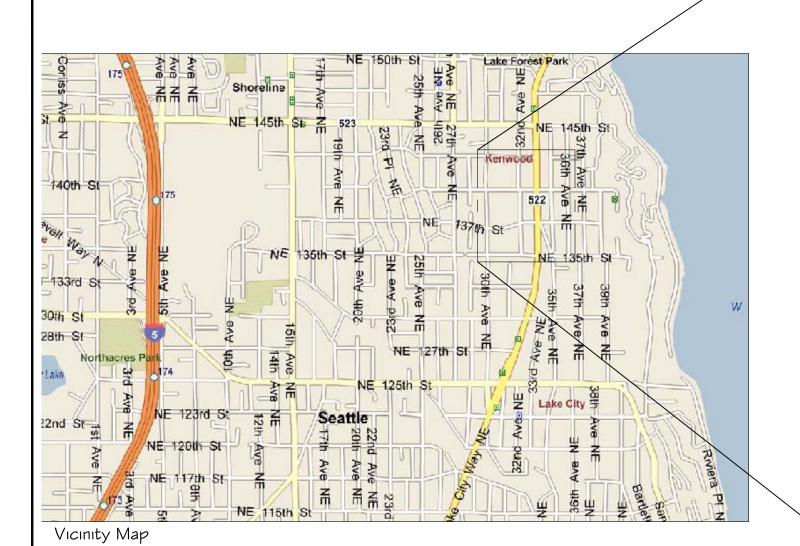
DATE OG/16/08

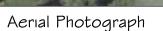
SCALE: N.T.S.

DRAWN: JP/JM

DESIGN: JW/JP

APPROVED: SHEET#





NE 140th St

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NE 140th St

LAKE CITY WAY MIXED USE
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137 I G LAKE CITY WAY NE
RECOMMENDATION MEETING
DPD PROJECT # 3007936

NE

SHEET TITLE:

Site Analysis

OG/1 G/O8 RECOMMEND MEETING REVISION

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DATE 06/16/08

SHEET# 4.0



Legend City Limits Parcels SF 5000 SF 7200 SF 9800 RSL/TC LDT Lowrise 1 Lowrise 2 Lowrise 3 Lowrise 4 Midrise Highrise Seattle Mixed Neighborhood Commercial 1 Neighborhood Commercial 2 Neighborhood Commercial 3 Commercial 1 Commercial 2

Zoning Map Source: City of Seattle DPD ~ GIS Maps

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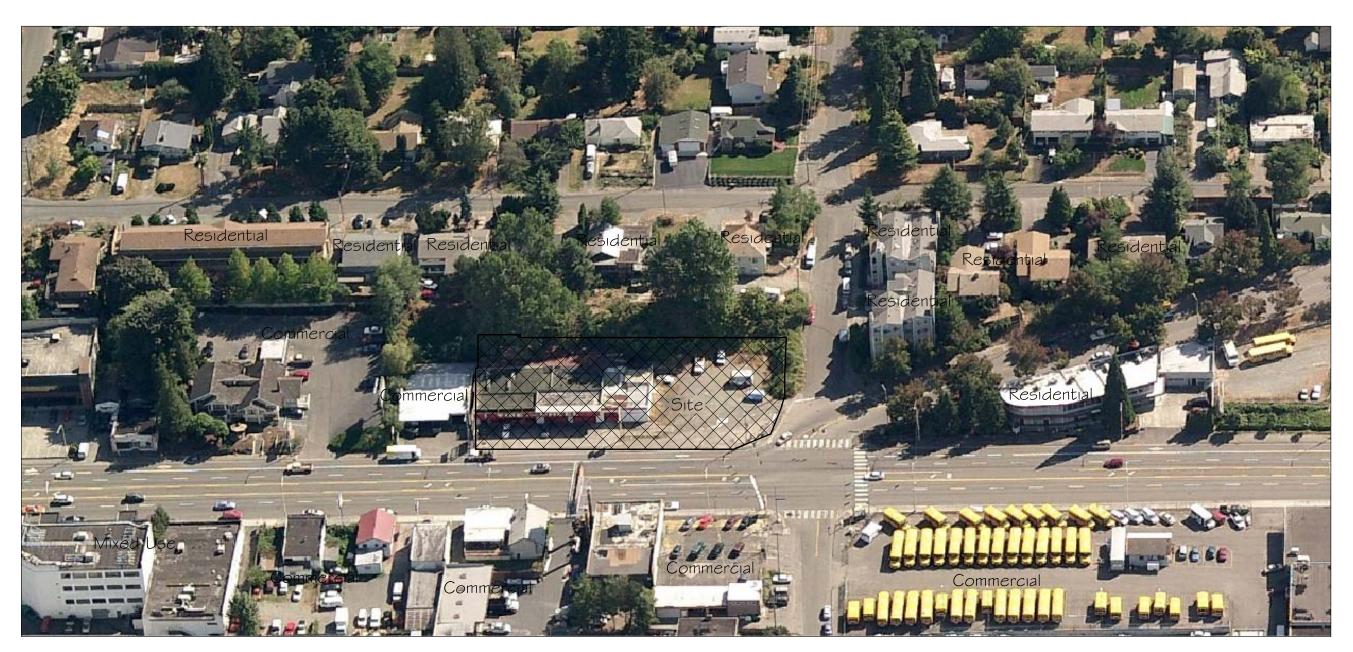
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Site Analysis

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Aerial View of Project Site Looking east





Project Site ~ Looking North

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LAKE CITY WAY MIXED USE 152-UNIT AFFORADABLE SENIOR HOUSING 137 I GLAKE CITY WAY NE RECOMMENDATION METING DPD PROJECT # 3007936

SHEET TITLE:

Site & Context

DATE OG/16/08
SCALE: N.T.S.
DRAWN: JP/JM
DESIGN: JMJF

PROJECT SITE

- NE 137th STREET



West Elevation along Lake City Way NE Looking East from across the Street from the Project Site

ERICKSON PL NE



East Elevation along Lake City Way NE Looking West from the Project Site

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JOB: 2007040

SHEET TITLE:

Site & Context

T.O

DESIGN GUIDELINES:

A Site Planning

- A-2 Street Compatibility: The siting of the building has been chosen to take best advantage of the corner lot, by setting it back away from the corner to provide a entry plaza that is set back from the property line. The property has street right-of-way frontage on the south and west sides. The project has proposed a new 5' landscape buffer with street trees and a new 6' wide (min.) sidewalk to provide a buffer from the busy streets.
- A-3 Entrances Visible from the street: The main entrance is at the corner which is the most prominent and visible location. There will be a entry plaza with a covered entry, benches, enhanced landscaping and a water feature.
- A-5 The building has street right-of-way on the south and west sides, residential to the east and commercial to the north. There will be landscaping and fencing along the east property to screen the project form the adjacent residential properties up the hill to the east. The building steps back as it gets taller on the east side to minimize the impact and disruption to the residents to the east. To the north is commercial and the residential units will sit back an average of 10' or more from the north property line.
- A-6 Transition between residence and street: There will be a 5' planting strip with street trees between the curb and the 6' wide sidewalk to provide a buffer from the traffic along Lake City Way NE. The main entry has a plaza with benches and overhead weather protection and large amounts of glazing to provide more security for the residents who will be using the lobby / plaza area, which will promote socialization in these areas.
- A-7 Residential open space: The large community courtyards on the second floor are set back from the street and are facing west to take best advantage of the sun. Planting will be used to provide wind and noise screening from Lake City Way. Community rooms are off the community courtyards on the second floor and there is a large open deck on the roof that will have a bar-b-que area, dog walk area, covered seating and screening from the wind along with pea patch gardens for the residents.
- A-10 Corner lots: The corner of the project was redesigned to orient the main entry to the corner and provide a grander, more defined entry with enhanced landscaping, benches and a water feature.

At the sixth floor the units facing Lake City Way were reduced in size to step the building back. Each of the three main wings of the building set back different distances from the property line to help reduce the "canyon effect" along Lake City Way. The relationship between the street level facade and the upper floors were redesigned to tie together better. The parking layout was redesigned to be more efficient and allow for better circulation.

B Height, Bulk and Scale

B-I Height, bulk and scale: The street level commercial area and the uppers floors were redesigned to connect together. The street level facade now has metal awnings that are more appropriate for commercial applications. The height has been adjusted to provide weather protection for pedestrians and to reduce the continual horizontal band along the front. Window patterns and sizes were changed to help with reducing the bulk and scale. The brick was extended up to the second floor and materials and colors changed to create a common vocabulary that helps tie the building together.

C Architectural elements and materials:

C-2 Architectural concept and consistency: The street front facade was redesigned to adjust the proportions and create a more uniform feel to the building. The materials and colors flow together better. The changes in glazing patterns and window sizes at the street level, along with the lights and metal awnings help to distinguish the commercial from the residential.

- C-3 Human scale: The height of the awnings and the two levels of windows along the street facing facade and benches at the entry help bring the commercial street frontage to a human scale.
- C-4 Exterior finish materials: Brick will be used at the base of the building to cover all exposed concrete and will have a blend of colors that ties in with the rest of the building colors. Changes in brick color and orientation will be used to create more detail and to break up the expanses of brick. The stairs towers will be painted in a color that mimics the brick to bring that color up the full height of the building. The brick will also extend above the commercial space to a point that architecturally makes sense with the the residential part of the building yet does not create a distinctive horizontal band. The awnings are made of metal \$\$ some glass that are more appropriate for the location that they are used. The location of the awnings are such that they provide weather protection along the street front.

D Pedestrian environment

- D-I Pedestrian open spaces and entrances: The main front entry was redesigned to make it more prominent and to allow it to take better advantage of the entry plaza area. There is a canopy that extends from the front of the building to provide weather protection for the benches at the entrance. More windows and better placement allow for more visibility for those in the lobby and those sitting near the entry. The location of the benches, the water feature and enhanced landscaping at the entrance plaza make it more user friendly and the 5' landscape buffer along the street frontage help making it more secure.
- D-2 Blank walls: The street facing facade has very little blank walls along Lake City Way, there are large expanses of glazing that will allow for pedestrians to look into the commercial areas as well as the residential lobby. Along the south street facing facade there will be landscaping used to help soften blank walls that are not broken up by windows.
- D-7 Pedestrian safety and security: The large windows, building lighting and use of store front doors help to increase the personal safety for those coming and going from the building and the 5' landscape buffer between the street and sidewalk provide a secure buffer for those using the sidewalk.
- D-9 Commercial signage: The proposed building signage will sit on top of the metal awnings above the door to each commercial entrance, at the main entrance, along with signage at the entrance to each stair tower and at the entrance and exits from the parking garage. The signage will be be uniform in size and font.
- D-10 Commercial lighting: The lighting along the street frontage will be high quality fixtures that are coordinated with the architectural style of the building and that will enhance the architectural feature of the building. The levels of illumination will be sufficient to provide a sense of security.
- D-II Commercial transparency: The street level facing facades in the commercial area are primarily transparent glass from 2' above the sidewalk level to an average of 15'. The maximum length of blank wall is no greater than 9'.
- D-12 Residential entries and transitions: The main entrance to the building has been reoriented to make better use of the prominent corner. A landscape architect and interior / exterior designer have both been involved in the redesign of the entry plaza to provide creative landscaping, covered seating and secure lighting for the main entry along with landscape to screen the blank walls on the north and south facades. Window sizes and proportions where changed to create more visual interest and to help with the window to wall ratio. The lighting and visibility of the main lobby has been revised to for better person safety and security. Windows have been added between the community spaces and the corridor and a window was placed at the end of one of the corridors to help bring in more light and visual interest in the long corridors

E Landscaping

E-2 Landscaping to enhance the building or site: The landscape architect has picked street trees that are to a shape and scale that is appropriate for the size of this building. The landscaping has been designed to incorporate the Green factor and will be appropriate for the location, end users and type of project.

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LAKE CITY WAY MIXED USE
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SHEET TITLE:

Summary of Early Design Guidance

OG/1G/O8 RECOMMENDATION METING

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DRAWN: JP/JM

DESIGN: JM/JP

APPROVED: J

A-2 Streetscape Compatibility

The siting of building should acknowledge and reinforce the existing desirable spatial characteristics of the right-of-way.

The siting of the building has been chosen to take best advantage of the corner lot, by setting it back away from the corner to provide a entry plaza that is set back from the property line. The property has street right-of-way frontage on the south and west sides. The project has proposed a new 5' landscape buffer with street trees and a new 6' wide (min.) sidewalk to provide a buffer from the busy street.

The main entrance is at the corner which is the most prominent and visible

location. There will be a entry plaza with a covered entry, benches,

The building has street right-of-way on the south and west sides,

residential to the east and commercial to the north. There will be

landscaping and fencing along the east property to screen the project

form the adjacent residential properties up the hill to the east. The

building steps back as it gets taller on the east side to minimize the

impact and disruption to the residents to the east. To the north is

commercial and the residential units will sit back an average of 10' or

There will be a 5' planting strip with street trees between the curb and

the 6' wide sidewalk to provide a buffer from the traffic along Lake City Way NE. The main entry has a plaza with benches and overhead weather protection and large amounts of glazing to provide more security for the

residents who will be using the lobby / plaza area, which will promote

enhanced landscaping and a water feature.

more from the north property line.

socialization in these areas.

A-3 Entrances Visible from the Street

Entries should be clearly indetifiable and visible from the street.

A-5 Respect for Adjacent Sites

Buildings should respect adjacent properties by being located on their sites to minimize disruption of the privacy and outdoor activities of residents in adjacent buildings.

A-6 Transition Between Residence and Street

Building and the sidewalk should provide security and privacy for residents and encourage social interaction among residents and neighbors.

A-7 Residential Open Space

Residential projects should be sited to maximize opportunities for creating usable, attractive, well-integrated open space.

The large community courtyards on the second floor are set back from the street and are facing west to take best advantage of the sun. Planting will be used to provide wind and noise screening from Lake City Way. Community rooms are off the community courtyards on the second floor and there is a large open deck on the roof that will have a bar-b-que area, dog walk area, covered seating andscreening from the wind along with pea patch gardens for the residents.

A-10 Croner Lots

Buildings on corner lots should be oriented towards the public street fronts. Parking and automobile access should be located away from corners.

The corner of the project was redesigned to orient the main entry to the corner and provide a grander, more defined entry with enhanced landscaping, benches and a water feature. The residential entrace is further enhanced with a prominent arched overhead canopy. At the sixth floor the units facing Lake City Way were reduced in size to step the building back. Each of the three main wings of the building set back different distances from the property line to help reduce the "canyon effect" along Lake City Way. The relationship between the street level facade and the upper floors were redesigned to tie together better. The parking layout was redesigned to be more efficient and allow for better circulation.

B. Height, Bulk and cale

B-1 Height, Bulk and Scale

Projects should be compatible with the scale of development anticipated by the applicable Land Use Policies for the surrounding area and should be sited and designed to provide a sensitive transition to near-by, less-intensive zones.

The street level commercial area and the uppers floors were redesigned to connect together. The street level facade now has metal awnings that are more appropriate for commercial applications. The height has been adjusted to provide weather protection for pedestrians and to reduce the continual horizontal band along the front. Window patterns and sizes were changed to help with reducing the bulk and scale. The brick was extended up to the second floor and materials and colors changed to create a common vocabulary that helps tie the building together.

C. Architectural Elements and Materials

C-2 Architectural Concept and Consistency

Building design elements, details and massing should create a well-proportioned and unified building form and exhibit an overall architectural concept.

Buildings should exhibit form and features identifying the functions within the building.

The street front facade was redesigned to adjust the proportions and create a more uniform feel to the building. The materials and colors flow together better. The changes in glazing patterns and window sizes at the street level, along with the lights and metal awnings help to distinguish the commercial from the residential

._____

C-3 Human Scale

The design of new buildings should incorporate architectural features, elements and details to achieve a good human scale.

C-4 Exterior Finish Material

Building exteriors should be constructed of durable and maintainable materials that are attractive even when viewed up close. Materials that have texture, patterns, or lend themselves to high quality of detailing are encouraged.

D. Pedestrian Environment

D-1 Pedestrian Open Spaces and Entrances

Convenient and attractive access to the building's entry should be provided. To ensure comfort and security, paths and entry areas should be sufficiently lighted and entry areas should be protected from the weather. Opportunities for creating lively, pedestrian-oriented open space should be considered.

D-2 Blank Walls

Buildings should avoid large blank walls. Where blank walls are unavoidable, they should receive design treatment to increase pedestrian comfort and interest.

D-7 Personal Safety and Security

Project design should consider opportunities for enhancing personal safety and security in the environment under review.

D-9 Commercial Signage

Signs should add interest to the street front environment and should be appropriate for the scale and character desired in the area.

D-10 Commercial Lighting

Appropriate levels of lighting should be provided in order to promote visual interest and a sense of security for people in commercial districts evening hours.

D-11 Commercial Transparency

Commercial storefronts should be transparent, allowing for a direct visual connection between pedestrians on the sidewalk and the activities occurring on the interior of a building. Blank walls should be avoided.

D-12 Residential Entries and Transitions

For residential projects in commercial zones, the space between the residential entry and the sidewalk should provide security and privacy for residents and be visually interesting for pedestrians. Residential buildings should enhance the character of the streetscape with small gardens, stoops, and other elements that work to create a transition between the public sidewalk and private entry.

E. Landscaping

E-2 Landscaping to Enhance the Building and/or Site

Landscaping, including living plants, special pavement, trellises, screen walls, planters, site furniture and similar features should be appropriately incorporated into the design to enhance the project.

Response

The height of the awnings and the two levels of windows along the street facing facade and benches at the entry help bring the commercial street frontage to a human scale.

Brick will be used at the base of the building to cover all exposed concrete and will have a blend of colors that ties in with the rest of the building colors. Changes in brick color and orientation will be used to create more detail and to break up the expanses of brick. The stairs towers will be painted in a color that mimics the brick to bring that color up the full height of the building. The brick will also extend above the commercial space to a point that architecturally makes sense with the the residential part of the building yet does not create a distinctive horizontal band. The awnings are made of metal \$ some glass that are more appropriate for the location that they are used. The location of the awnings are such that they provide weather protection along the street front.

The main front entry was redesigned to make it more prominent and to allow it to take better advantage of the entry plaza area. There is a canopy that extends from the front of the building to provide weather protection for the benches at the entrance. More windows and better placement allow for more visibility for those in the lobby and those sitting near the entry. The location of the benches, the water feature and enhanced landscaping at the entrance plaza make it more user friendly and the 5' landscape buffer along the street frontage help making it more secure.

The street facing facade has very little blank walls along Lake City Way, there are large expanses of glazing that will allow for pedestrians to look into the commercial areas as well as the residential lobby. Along the south street facing facade there will be landscaping used to help soften blank walls that are not broken up by windows.

The large windows, building lighting and use of store front doors help to increase the personal safety for those coming and going from the building and the 5' landscape buffer between the street and sidewalk provide a secure buffer for those using the sidewalk.

The proposed building signage will sit on top of the metal awnings above the door to each commercial entrance, at the main entrance, along with signage at the entrance to each stair tower and at the entrance and exits from the parking garage. The signage will be be uniform in size and font.

The lighting along the street frontage will be high quality fixtures that are coordinated with the architectural style of the building and that will enhance the architectural feature of the building. The levels of illumination will be sufficient to provide a sense of security.

The street level facing facades in the commercial area are primarily transparent glass from 2' above the sidewalk level to an average of 15'. The maximum length of blank wall is no greater than 9'.

The main entrance to the building has been reoriented to make better use of the prominent corner. A landscape architect and interior / exterior designer have both been involved in the redesign of the entry plaza to provide creative landscaping, covered seating and secure lighting for the main entry along with landscape to screen the blank walls on the north and south facades. Window sizes and proportions where changed to create more visual interest and to help with the window to wall ratio. The lighting and visibility of the main lobby has been revised to for better person safety and security. Windows have been added between the community spaces and the corridor and a window was placed at the end of one of the corridors to help bring in more light and visual interest in the long corridors.

The landscape architect has picked street trees that are to a shape and scale that is appropriate for the size of this building. The landscaping has been designed to incorporate the Green factor and will be appropriate for the location, end users and type of project.

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JOB: 2007040

LAKE CITY WAY MIXED USE 152-UNIT AFFORADABLE SENIOR HOUSING 137 I G LAKE CITY WAY NE RECOMMENDATION MEETING DPD PROJECT # 3007936

SHEET TITLE: Summary of Early

Design G	Guidance

DATE REVISION

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DESIGN: JM/JP

APPROVED: JN

DEPARTURES FROM DEVELOPMENT STANDARDS

REQUIREMENT	REQUEST	APPLICANT'S JUSTIFICATION			
Parking location and access (SMC 23.47A.0321c) Access to parking must be from the street with the fewest lineal feet of commercially zoned frontage.	Request access to parking from Lake City Way N.E. One residential egress point is proposed on N.E. 137th.	Intersection controls prevent access to N.E. I 37th from Lake City Way N.E. This request was presented to Ken Bardsley with SDOT, and he is in agreement with the location of proposed driveways.			
Street level development standards (SMC 23.47A.008B.2) Sixty percent of the street-facing facade between two feet and eight feet above sidewalk shall be transparent.	Request reduction in percentage of transparency along N.E. 137th.	Because of grade change, auto egress, parking and the trash \$ tranformer rooms needing to be on an exterior wall and a landscape screen along the south wall - the length of required tranparency will not be met.			
Street level development standards (SMC 23.47A.008D) Residential uses are limited to 20% of teh street level street facing facade.	Request residential use exceeds 20% of street facing facade at Lake City Way N.E. \$ N.E. 37th.	Because of grade change, auto egress and trash room, the residential uses \$\frac{1}{2}lobby will exceed the 20% requirement along NE 137th Street - the percentage of non residential use will be 82%. To create a prominent corner with pedestrian access to residential area the residential lobby will exceed the 20% requirement along Lake City Way NE - the percentage of non residential use will be 23%.			

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LAKE CITY WAY MIXED USE I 52-UNIT AFFORADABLE SENIOR HOUSING I 37 I 6 LAKE CITY WAY NE RECOMMENDATION MEETING DPD PROJECT # 3007936

SHEET TITLE:

Design Deprature Requests

OG/16/08 RECOMMENDATION MEETING REVISION

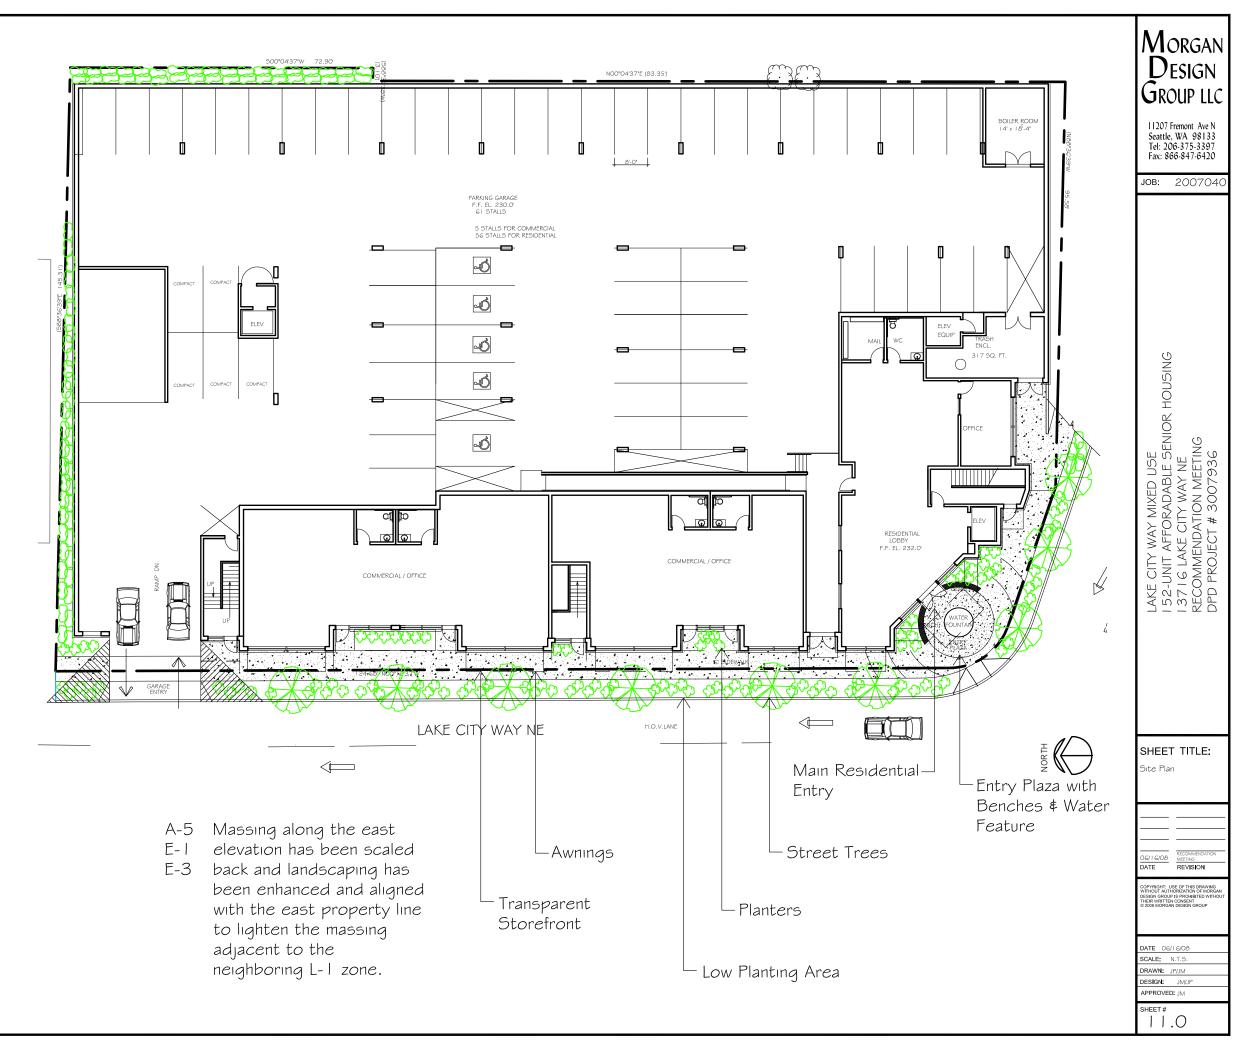
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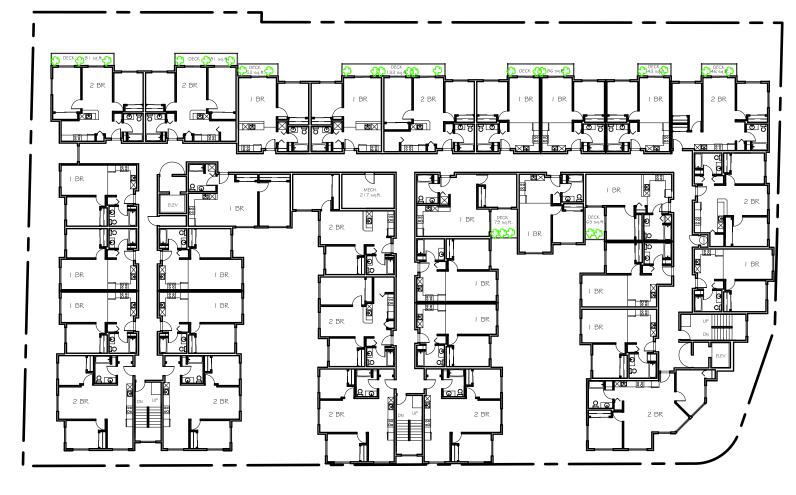
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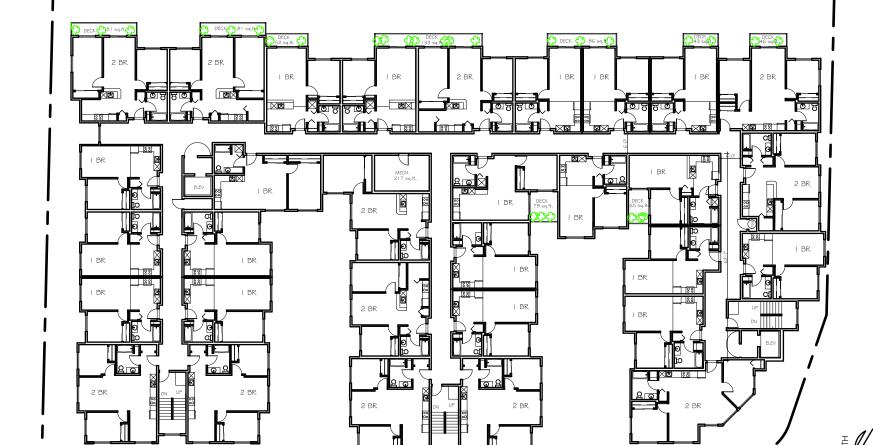
- A-8 All parking and vehicle access has been limited to the northwest corner of the site, as far from the prominent building corner at the intersection of NE I 37th Street/Erickson Place NE and Lake City Way NE.
- A-3 All commercial units along C-3 Lake City Way have entrances visible from the street to encourage human activity. Canopies and transparent storefront enhance the human scale.
- A-2 A large entry courtyard and plaza located at the southwest corner of the site provides a prominent entry to the residential portion of the building and it further provides open space. Surrounding commercial spaces encourage human activity. Lush landscaping, gathering space and overhead protection connects the building to the pedestrian at a human scale.
- A-10 This building sits on a corner lot at the intersection of NE137th/Erickson Place \$ Lake City Way. The southwest corner creates a highly visible condition from points south and east of the site. This condition has been embraced with the creation of an open public plaza, and canopies to accessorize the building facade.











Level 4 Residential Units

Typical Upper Floor Plan MORGAN DESIGN GROUP LLC

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OB. 20070²

LAKE CITY WAY MIXED USE
152-UNIT AFFORADABLE SENIOR HOUSING
137 16 LAKE CITY WAY NE
RECOMMENDATION MEETING
DPD PROJECT # 3007936

SHEET TITLE:

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DATE RECOMMENDATION MEETING REVISION

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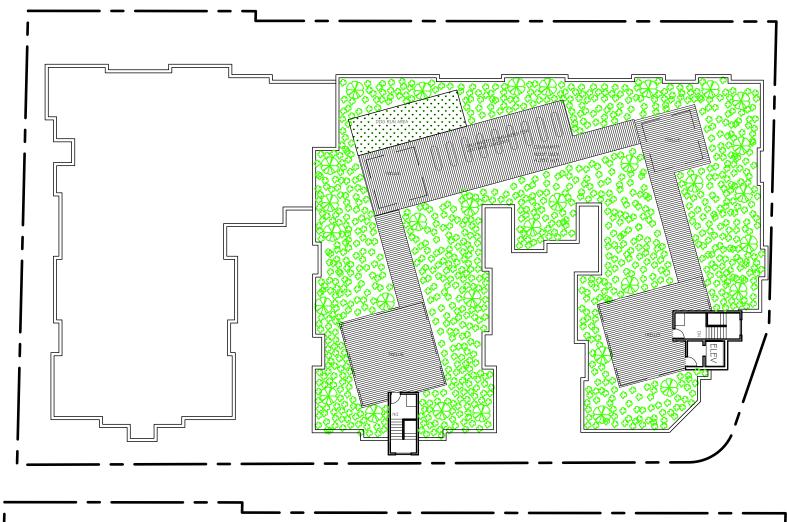
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A CONTRACTOR OF THE CONTRACTOR

Level 7 Residential Units

Roof Plan



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20070

LAKE CITY WAY MIXED USE
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Floor Plans

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 A_{-2} This building sits on a corner lot at the intersection A_{-6} of NE I 37th/Erickson Place \$ Lake City Way. The

A-10 southwest corner creates a highly visible condition

- D-I from points south and east of the site. This condition
- D-7 has been embraced with the creation of an open
- D-12 public plaza, and canopies to accessorize the building facade. All parking and vehicle access has been limited to the northwest corner of the site, as far from the prominent building corner at the intersection of NE I 37th Street/Erickson Place NE and Lake City Way NE.
- A-3 All commercial units along Lake City
 A-4 Way have entrances visible from the
- C-3 street to encourage human activity.
 Canopies and transparent storefront enhance the human scale.
- E-2 Lush landscaping along the building facades, street trees and low-demand plants in small planter boxes enhance the building.

- C-2 Architectural concept and consistency has
- C-4 been achieved by using durable exterior finish materials applied to accentuate the primary masses of the building. Pattern and texture has been utilized in the material application to enhance the design and differentiate the building elements from one another.

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LAKE CITY WAY MIXED USE
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137 I G LAKE CITY WAY NE
RECOMMENDATION MEETING
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PRELIMINARY ELEVATIONS

06/16/08 RECOMMENDATION MEETING
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A-5 The height, bulk and scale of this building has B-I been concentrated to the west side of the site in order to take advantage of existing contours and slopes to build "into the slope", thereby respecting the adjacent properties by allowing better access to light and air to the lowrise zone to the east and southeast.

C-2 Architectural concept and consistency has been C-4 achieved by using durable exterior finish materials applied to accentuate the primary masses of the building. Pattern and texture has been utilized in the material application to enhance the design and differentiate the building elements from one another.

E-2 Lush landscaping along the building facades, street trees and low-demand plants in small planter boxes enhance the building.

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137 I G LAKE CITY WAY NE
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A-3 A large entry courtyard C-3 and plaza located at the southwest corner of the site provides a prominent entry to the residential portion of the building and it further provides open space. Surrounding commercial spaces encourage human activity. Lush landscaping, gathering space and overhead protection connects the building to the pedestrian at a human scale.

Massing along the east elevation has been scaled back and landscaping has been enhanced and aligned with the east property line to lighten the massing adjacent to the neighboring L-1 zone.

Architectural concept and C-4 consistency has been achieved by using durable exterior finish materials applied to accentuate the primary masses of the building. Pattern and texture has been utilized in the material application to enhance the design and differentiate the building elements from one another.



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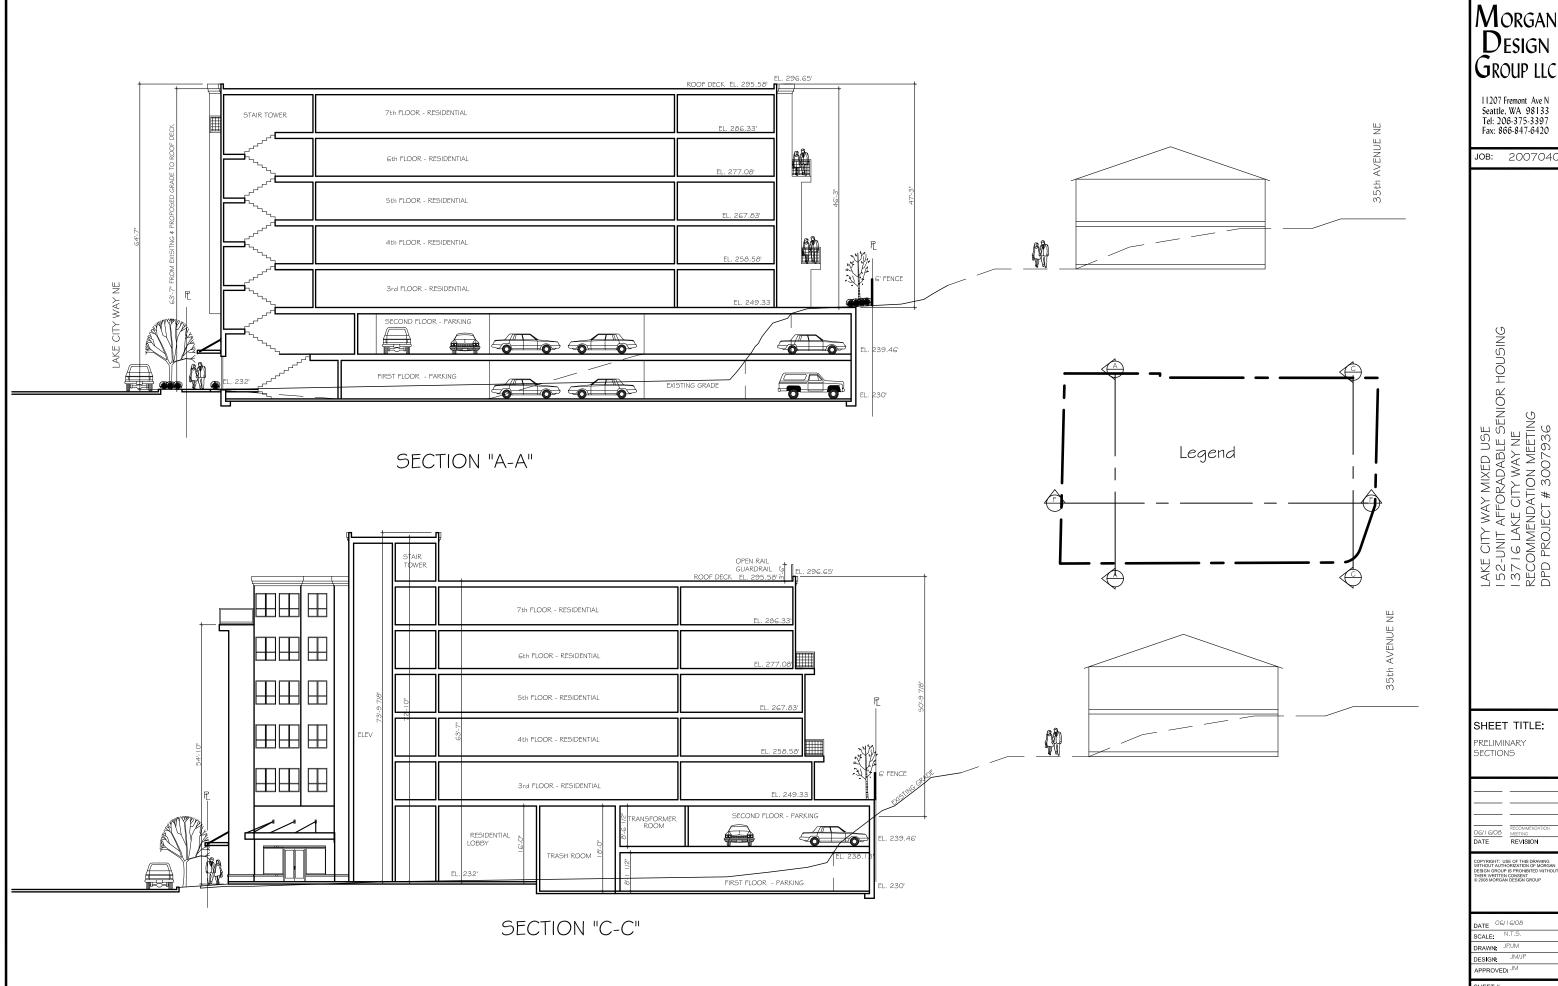
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06/16/08 DATE

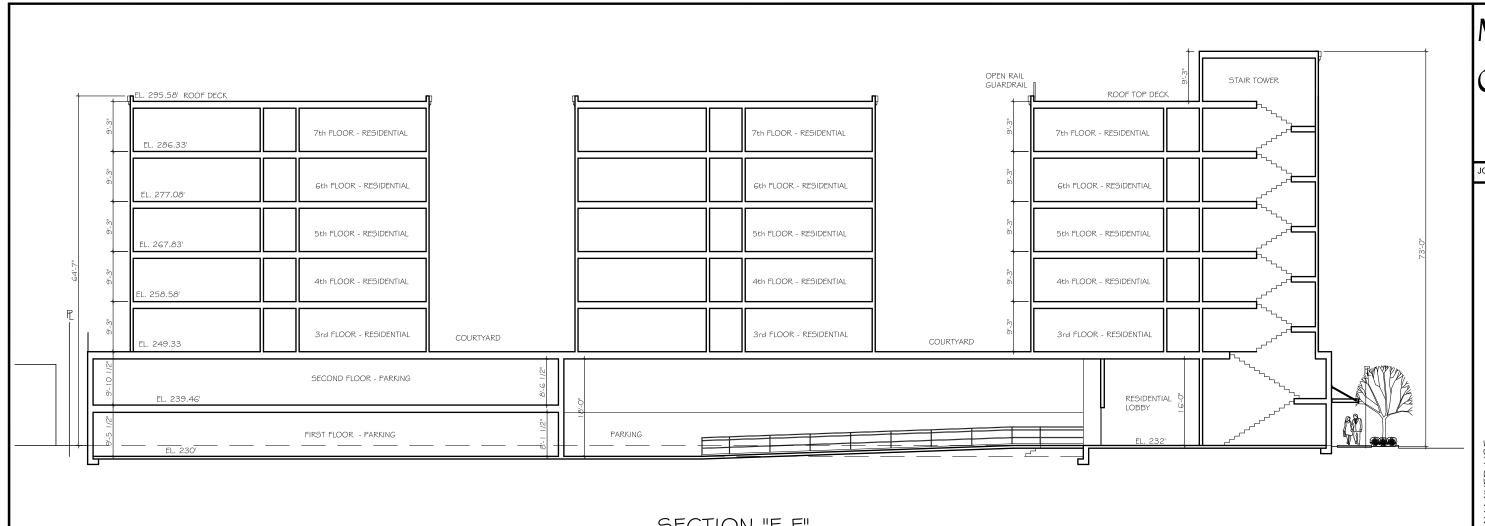
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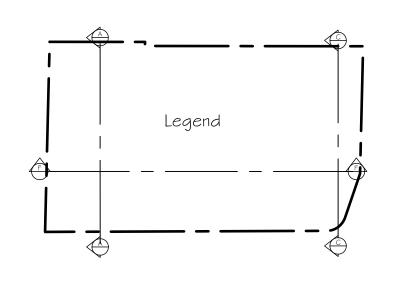


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SECTION "F-F"



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LAKE CITY WAY MIXED USE I 52-UNIT AFFORADABLE SENIOR HOUSING I 37 I 6 LAKE CITY WAY NE RECOMMENDATION MEETING DPD PROJECT # 3007936

SHEET TITLE:

PRELIMINARY SECTIONS

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SHEET TITLE:

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SHEET# 20.0













Examples of the multiple profiles of proposed cladding systems utilized to distinguish building elevations.

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LAKE CITY WAY MIXED USE 152-UNIT AFFORADABLE SENIOR HOUSING 13716 LAKE CITY WAY NE RECOMMENDATION MEETING DPD PROJECT # 3007936

SHEET TITLE: MATERIALS

SCALE: N.T.S DRAWN: JP/JM
DESIGN: JM/JF
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Typical Commercial Canopy

Dark anodized aluminum with a combination of glass and solid infill

Outdoor Lighting High bronze color, 16" Luna Dark Sky Energy Star



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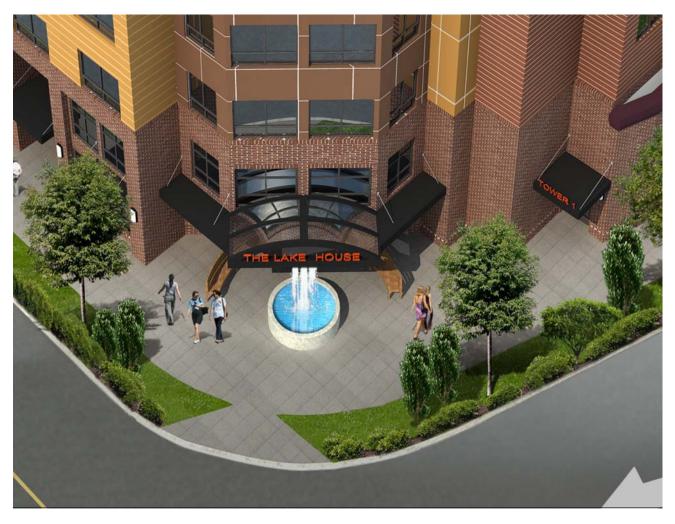
SHEET TITLE:

Canopies, Signage \$ Outdoor Lighting

SCALE: N.T.S

SHEET # 22.0





Main Residential Entry Canopy

Dark anodized aluminum with a combination of glass and solid infill

Outdoor Lighting High bronze color, 16" Luna Dark Sky Energy Star



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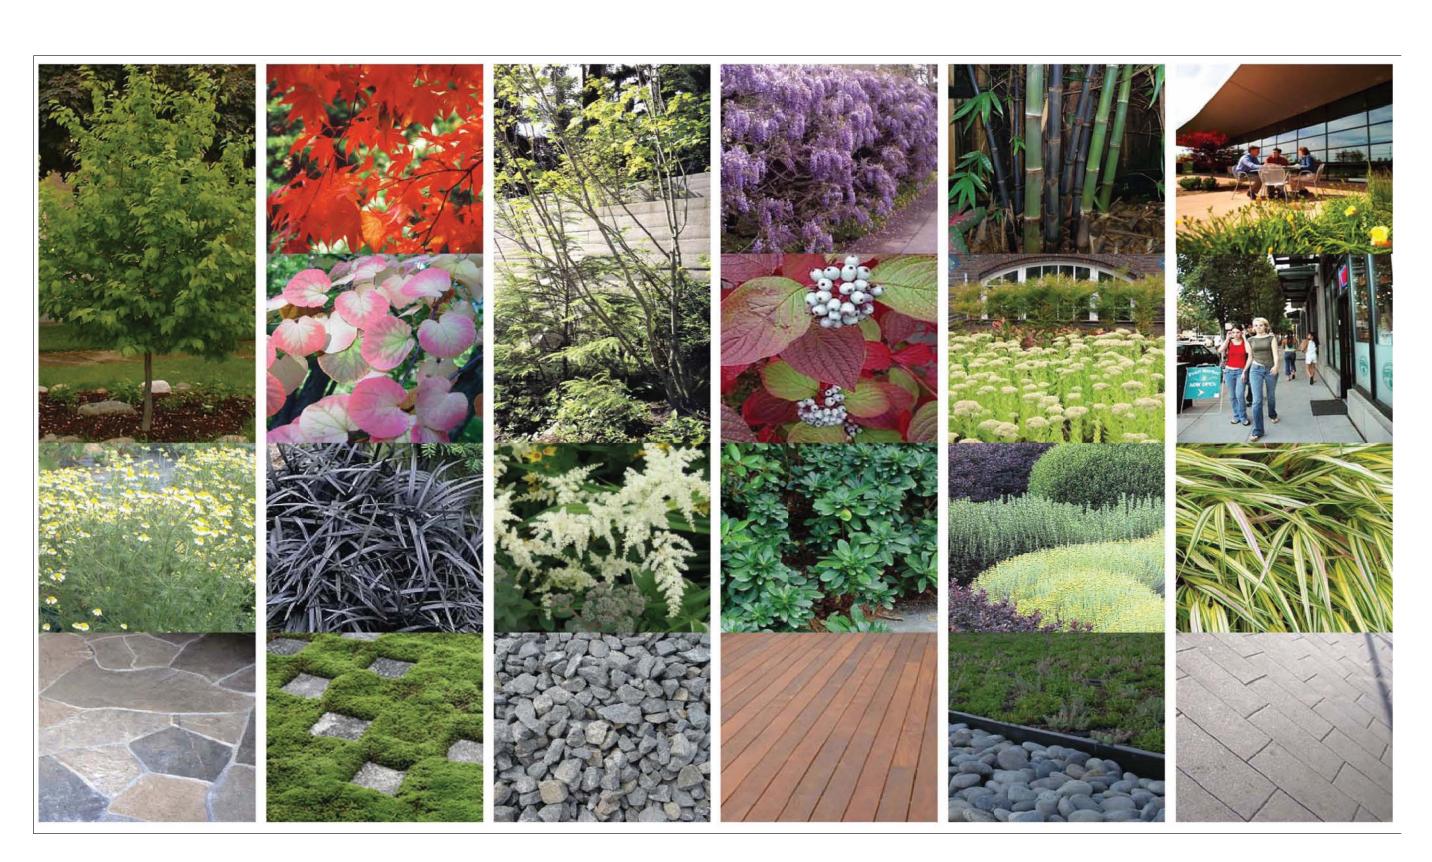
LAKE CITY WAY MIXED USE
152-UNIT AFFORADABLE SENIOR HOUSING
137 I G LAKE CITY WAY NE
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SHEET TITLE:

Canopies, Signage \$ Outdoor Lighting

SCALE: N.T.S

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P-PATCH



MEADOW



OUTDOOR TERRACES



		SI	EATT	LE×green	factor	14
770	L VERBION 1-42-07	enter of pa				ou need at least 0.300
	Parcel size (ENTER THIS VALUE FIRST)	1 33,	825	<u> </u>	SCORE	0.663
	Types of Area [™]			Square Feet	Factor	Total
Α	Vegetation planted with a soil depth of less than 24"					
1	Lawn or grass pavers or ground covers		[enter sg ft 8217	0.2	1,643
2	Plants and shrubs 3' and higher at maturity		[enter sg ft	0.3	
В	Vegetation planted with a soil depth of more than 24"					
1	Lawn, grass pavers or other plants less than 3' tall at maturity	enter numb	ev of plo	enter sg ft 7588	0.7	5,312
2	Shrubs taller than 3' at maturity - calculated	50		8016	0.3	2,405
	at 16 sq ft per plant (typically planted no closer than 18" on center)	enter numb				
3	Tree canopy for "small trees" in SDOT's Street Tree Planting Schedule or equivalent canopy spread of 15' - calculated at 50 sq ft per tree	1	2	600	0.3	180
4	Tree canopy for "small/medium trees" in Street Tree Planting Schedule or equivalent canopy spread of 20' - calculated at 100 sq ft per tree	enter numb	er of pla	nts 0	0.3	
5	Tree canopy for "medium/large trees" in Street Tree Planting Schedule or equivalent canopy spread of 25' - calculated at 150 sq ft per tree	enter numb		nts 0	0.4	*
6	Tree canopy for "large trees" in in Street Tree Planting Schedule or equivalent canopy spread of 30" - calculated at 200 sq ft per tree	enter numb		nts 2000	0.4	800.0
7	Tree canopy for preservation of "exceptional trees" or trees with trunk diameter exceeding 24" at four and one half feet above the ground, calculated at 250 sq ft per tree	enter numb		nts 0	0.5	147
8	Permeable paving that drains only itself. It must be at grade calculated per square foot		[enter sq ft 68	0.6	40.8
С	Green roofs - 4" minimum soil depth at time of planting		[enter sg ft 14006	0.7	9,804.2
D	Vegetated walls		[enter sq ft 0	0.7	-
E	Water features (fountains) or rain gardens (where allowed by SPU)		[enter sg ft 39	0.7	27.3
3on	uses	sub-total o	sqft=	40,534		
F	Landscaping using drought tolerant plants or where at least 50% of annual irrigation needs are met from non-potable sources		[enter sg ft 18,674	0.1	1,867
G	Landscaping visible to passers by from adjacent public right of way or public open spaces			enter sg ft 3,445	0.1	345
	Page 19 1104 of boom obou obdood			green fect	tor numerator =	22,424
	* Do not count public rights of way in parcel size calculation. ** To calculate your green factor score, you may count the landscape econtiguous with the parcel. Seattle Green Factor , 0803		hat are	in public right	s of way if the	y are

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LAKE CITY WAY MIXED USE 152-UNIT AFFORADABLE SENIOR HOUSING 13716 LAKE CITY WAY NE RECOMMENDATION MEETING DPD PROJECT # 3007936

SHEET TITLE:

Landscaping

OG/ I G/O8 RECOMMENDAT

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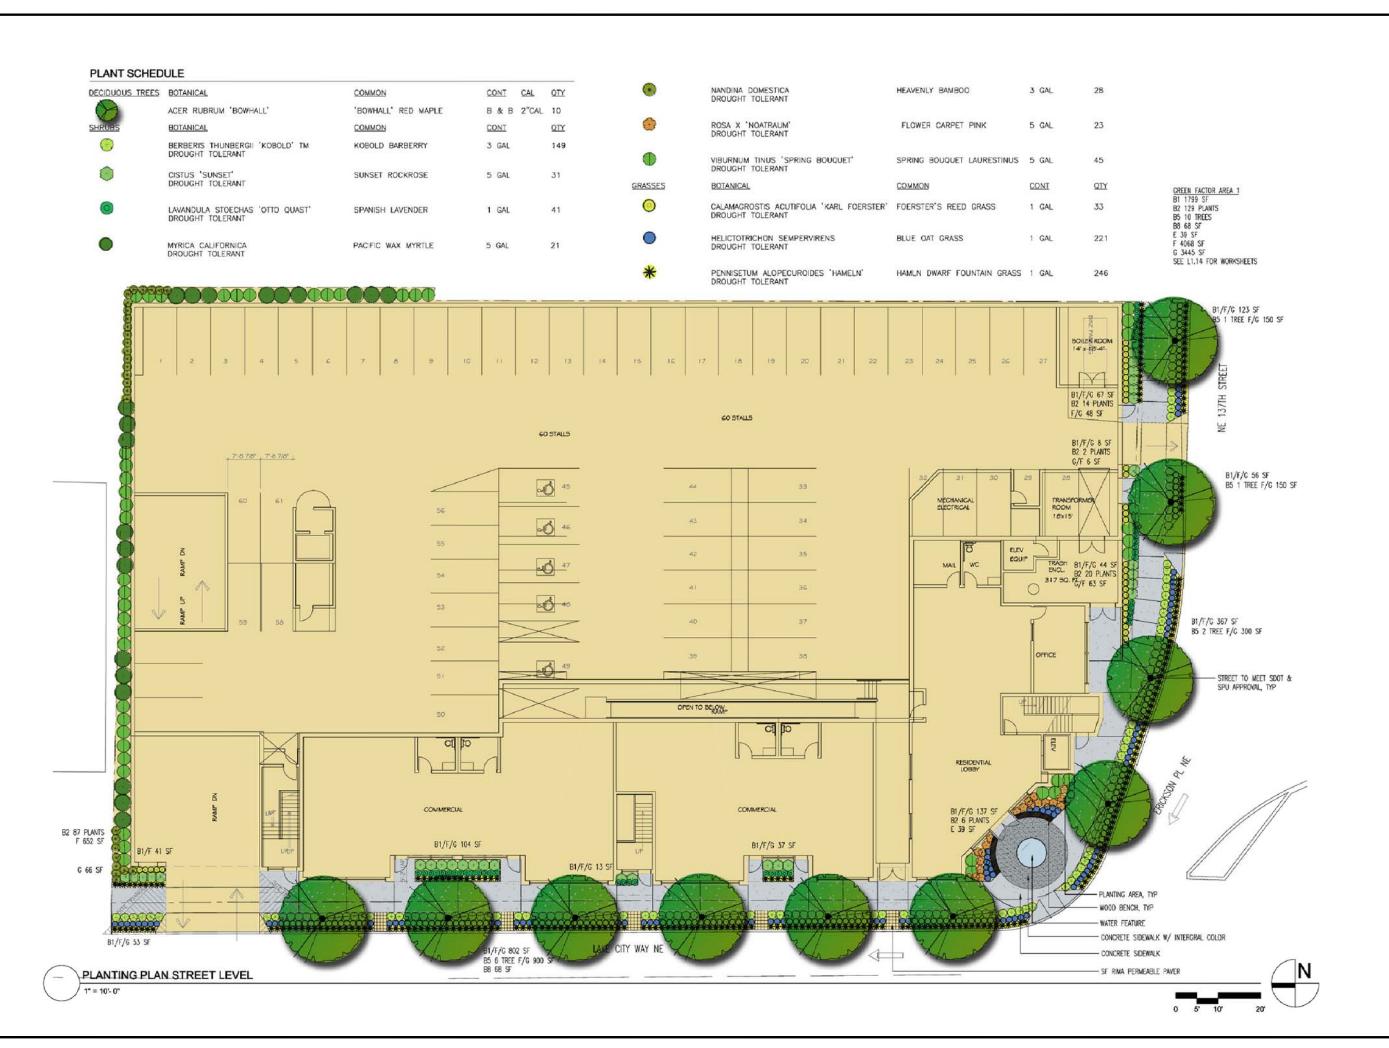
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LAKE CITY WAY MIXED USE
152-UNIT AFFORADABLE SENIOR HOUSING
137 I G LAKE CITY WAY NE
RECOMMENDATION MEETING
DPD PROJECT # 3007936

SHEET TITLE:

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SHEET# 26.0

PLANT SCHEDULE

PLANT SCHED	OLE						
DECIDUOUS TREES	BOTANICAL	COMMON	CO	TN	SIZE		QTY
8	ACER CIRCINATUM DROUGHT TOLERANT	VINE MAPLE	В	& B	5'-6'	HT.	12
SHRUBS	BOTANICAL	COMMON	CO	NT			QTY
	CHOISYA TERNATA DROUGHT TOLERANT	MEXICAN ORANGE	2 (GAL			32
•	CORNUS BAILEYI DROUGHT TOLERANT	BAILEY'S RED-TWIG DOGWOOD	3 (GAL			51
	ESCALLONIA 'RED ELF' DROUGHT TOLERANT	RED ELF ESCALLONIA	1 (GAL			90
\oplus	GAULTHERIA SHALLON DROUGHT TOLERANT	SALAL	1 (GAL			255
	LIRIOPE MUSCARI 'BIG BLUE' DROUGHT TOLERANT	BIG BLUE LILYTURF	2 (GAL			224

MAHONIA AQUIFOLIUM DROUGHT TOLERANT	OREGON GRAPE	5 GAL	99
MYRICA CALIFORNICA DROUGHT TOLERANT	PACIFIC WAX MYRTLE	5 GAL	42
NANDINA DOMESTICA DROUGHT TOLERANT	HEAVENLY BAMBOO	3 GAL	38
RHODODENDRON 'DORA AMATEIS'	RHODODENDRON	3 GAL	237
RIBES SANGUINEUM DROUGHT TOLERANT	RED FLOWERING CURRANT	5 GAL	20

GREEN FACTOR AREA 2 B1 5789 SF B2 372 PLANTS B3 12 TREES (600 SF) C 5789 SF F 6389 SF SEE L1.14 FOR WORKSHEETS



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LAKE CITY WAY MIXED USE
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PLANT SCHEDULE GROUND COVERS BOTANICAL COMMON

CAREX MORROWII 'ICE DANCE' ICE DANCE JAPANESE SEDGE 4"POT⊕ 12" OC 777

HELICTOTRICHON SEMPERVIRENS BLUE OAT GRASS 4"POT⊕ 18" OC 631 DROUGHT TOLERANT

IMPERATA CYLINDRICA 'RED BARON' RED BARON JAPANESE BLOOD GRASS 4"POT⊕ 18" OC 304 DROUGHT TOLERANT

LAVANDULA ANGUSTIFOLIA LAVENDER 4"POT® 12" OC 973
DROUGHT TOLERANT

QTY

CONT

LIRIOPE MUSCARI 'SILVERY SUNPROOF' SILVERY SUNPROOF BLUE LILYTURF 4"POT® 18" OC 503 DROUGHT TOLERANT

MAHONIA REPENS CREEPING MAHONIA 4"POT® 18" OC 795
DROUGHT TOLERANT

NASSELLA TENUISSIMA MEXICAN FEATHER GRASS 4"POT® 12" OC 787
DROUGHT TOLERANT

SEDUM ACRE 'AUTUMN JOY' 4"POT® 12" OC 624 DROUGHT TOLERANT

TRELLIS, TYP - FENCE, TYP - DOG RUN PLANTING AREA, 8" DEEP GREEN ROOF TRAY SYSTEM, TYP - COMPOSITE WOOD DECK, TYP - GALVANIZED CONTAINER FOR VEGETABLE GARDEN, TYP TRELLIS, TYP TRELLIS, TYP GREEN FACTOR AREA 3 A1 8217 SF C 8217 SF F 8217 SF SEE L1.14 FOR WORKSHEETS

PLANTING PLAN ROOF LEVEL

1" = 10'-0"

5' 10' 20' N

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APPROVED: JM SHEET#

SHEET# 28.0



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JOB: 2007040

LAKE CITY WAY MIXED USE 152-UNIT AFFORADABLE SENIOR HOUSING 13716 LAKE CITY WAY NE RECOMMENDATION MEETING DPD PROJECT # 3007936

SHEET TITLE:

Renderings

DATE OG/16/08
SCALE: N.T.S.
DRAWN: JP/JM
DESIGN: JM/JP
APPROVED: JM

SHEET # 29.0



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SHEET TITLE:

Renderings

DATE 06/16/08 SCALE: N.T.S. DRAWN: JP/JM

DESIGN: JM/JP

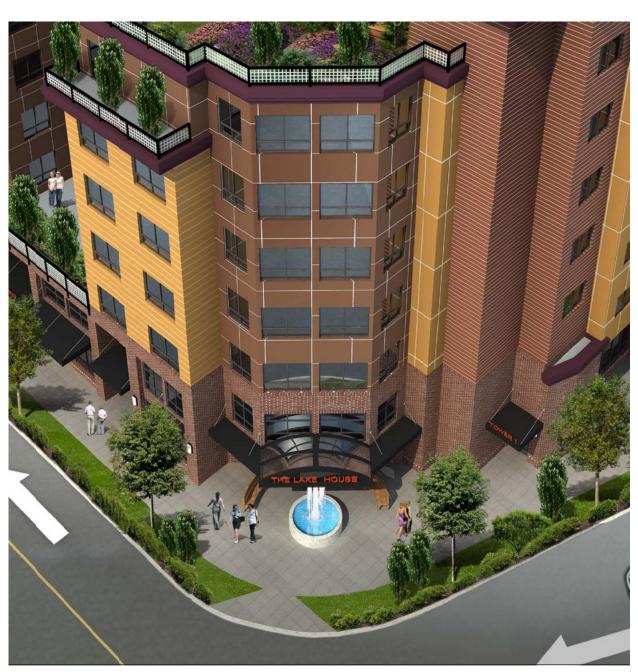
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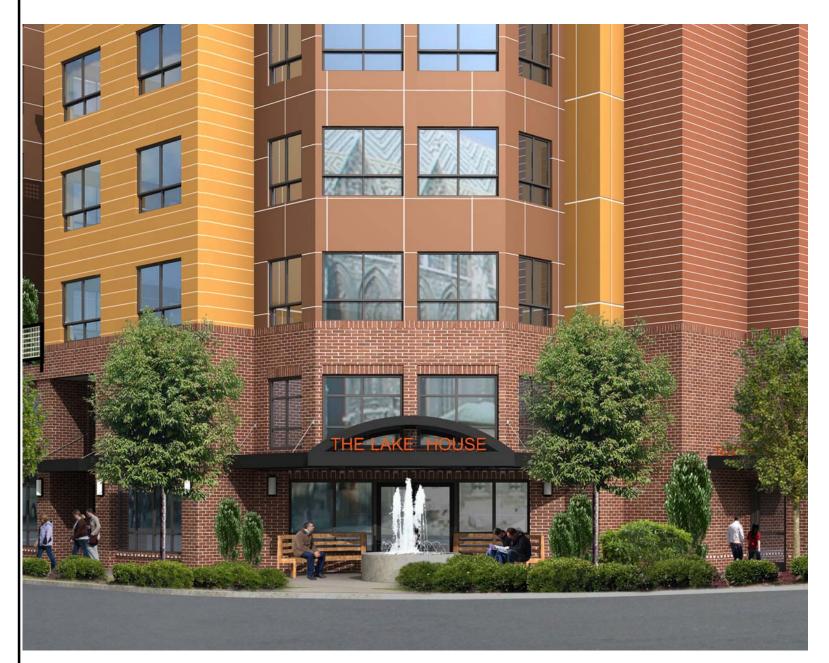


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SHEET TITLE:

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